Landscape Improvements

# Cafeteria Terrace

130 Turner Street Waltham, MA

PREPARED FOR:

Owner

Permit Set July 24, 2019


PREPARED BY:


Landscape Architect



1035 Cambridge Street, Suite 1 Cambridge, MA 02141 Web. www.symbio-design.com Tel: 617-921-4254

#130 **TURNER** STREET

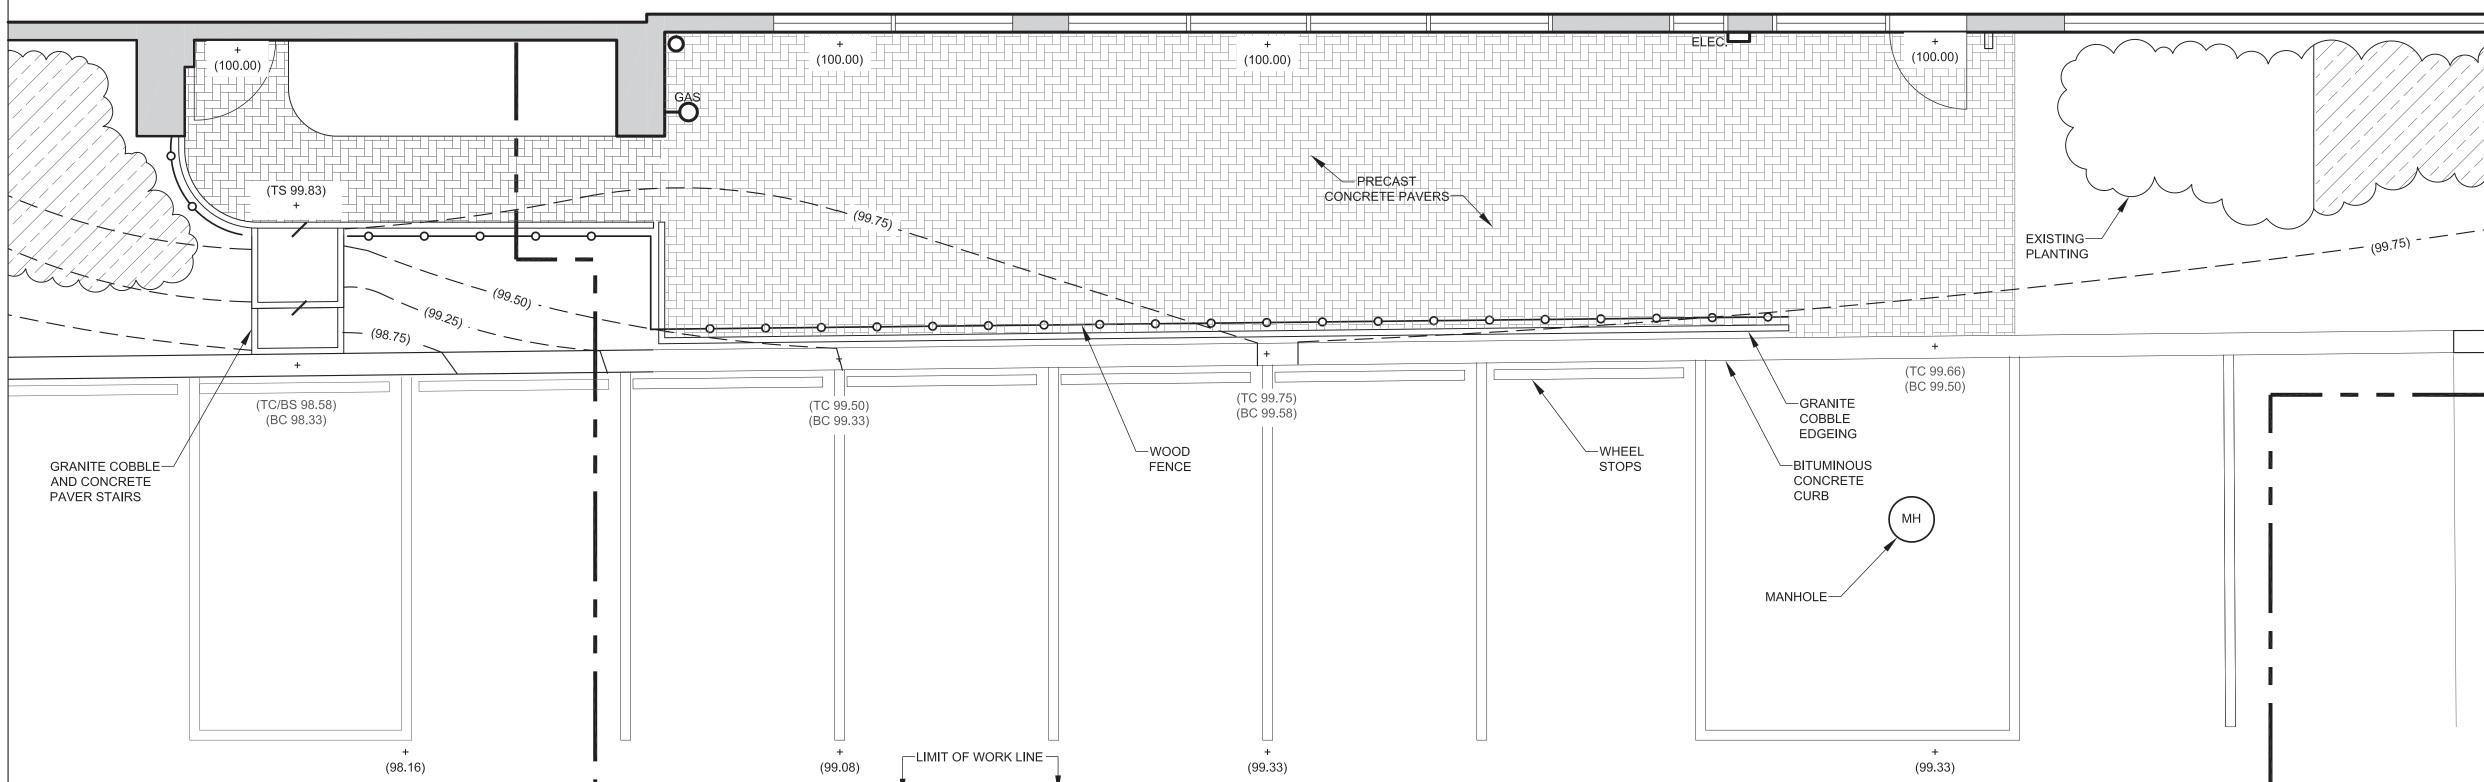

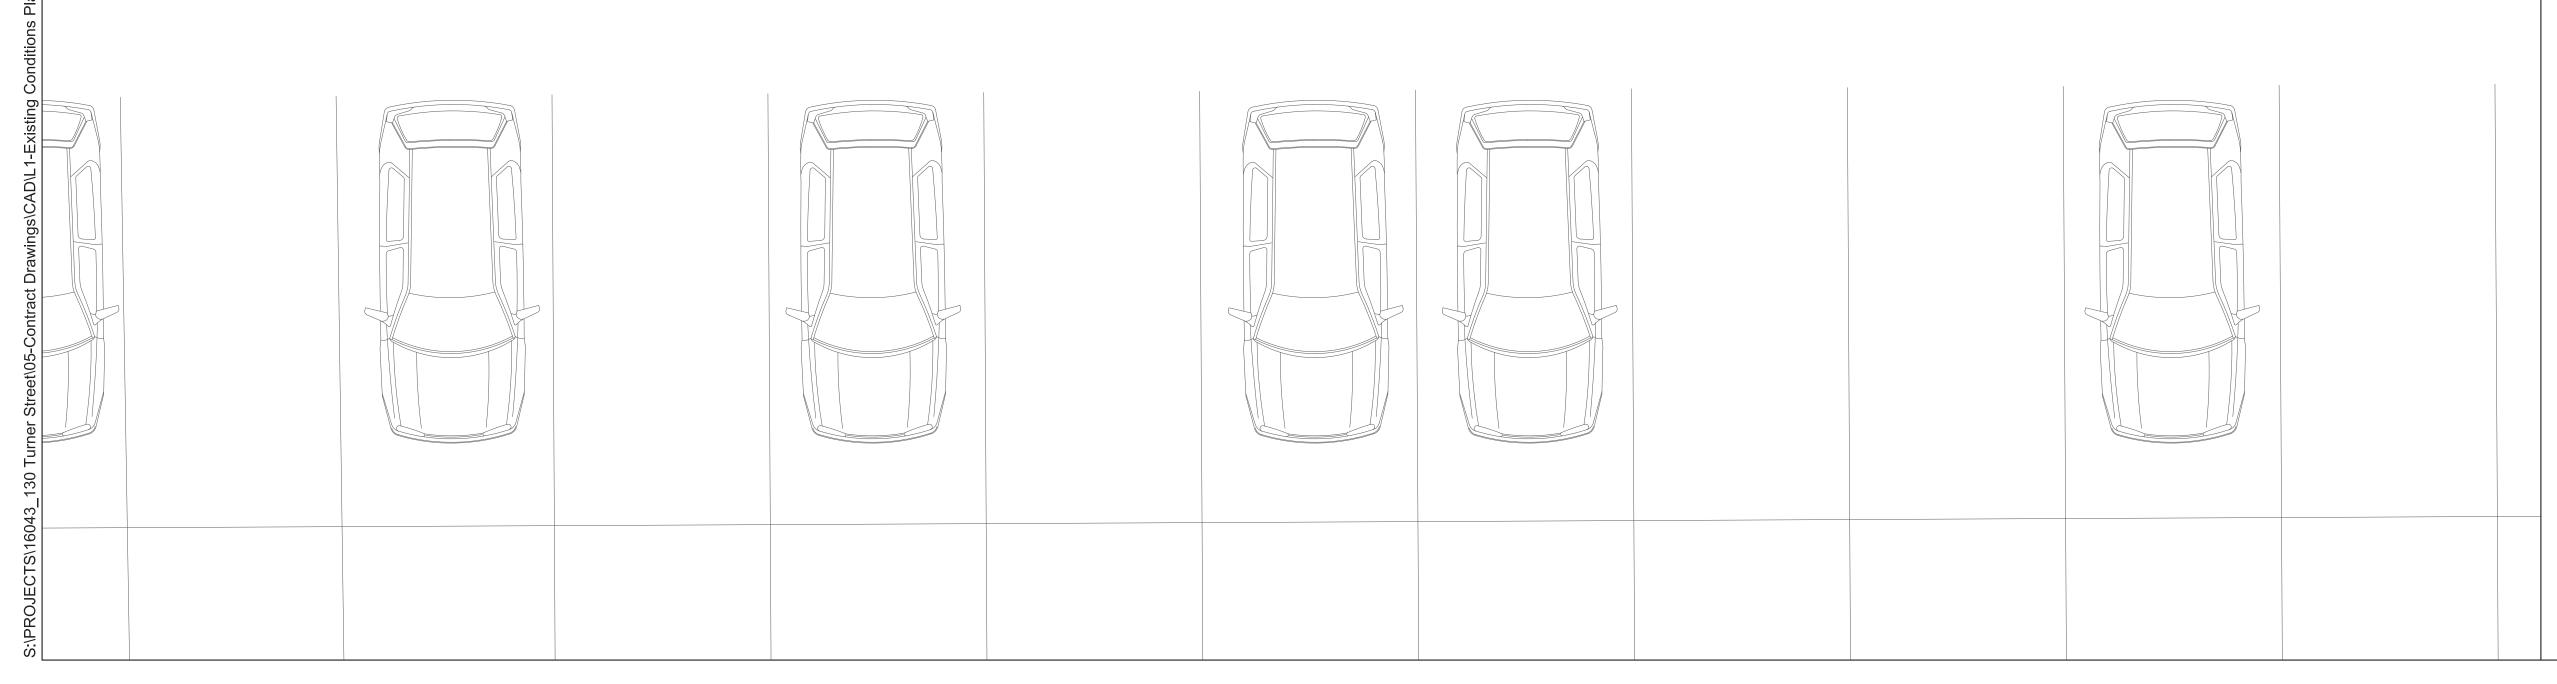

## GENERAL NOTES

EXISTING CONDITIONS:

1. Existing conditions taken from a PDF file titled 17-7476 -2018-03-06 MA Stoney Brook PGS2 NS.PDF

provided by Jumbo Capital. 2. Contractor shall verify all existing conditions and notify the landscape architect at once in writing of any discrepancies between the existing conditions as indicated on the plan and actual field conditions and receive

written instructions prior to proceeding. 3. Contractor shall be responsible for checking existing spot elevations to verify that they are accurate. 4. Existing underground utilities have been plotted from drawings and shall be considered approximate only. Contractor shall verify all utility locations and elevations prior to excavation before construction starts. 5 All utilities public and private must be contacted, including those in control of utilities not shown on this plan Contact 'dig safe' 1-800-322-4844, report any discrepancies in writing to the landscape architect and owner

and receive written instructions prior to proceeding. **BENCH MARKS:** 1. The contractor shall establish permanent bench marks, maintain all established bounds and bench marks and replace as directed any which are destroyed or disturbed.

1. Contractor shall employ special care in scheduling construction so as to minimize disruption to surrounding pedestrian and vehicular traffic.

2. contractor shall employ special care to protect safety of pedestrians inside and outside of contract limit line. 3. Contractor shall keep emergency exits clear at all times. any blocking shall be scheduled in advance and approved by the owner.

LIMIT OF WORK LINE: 1. Limit Of Work Line is noted on the drawings. Contractor is responsible for all damage due to operations inside and outside the limit of work line. Contractor shall meet line and grade of existing conditions at the contract limit line. See specifications for requirements regarding maintaining and protecting existing utilities inside and outside the limit of work line.

2. The contractor is responsible for damage inside and outside of the limit of work due to contract operations. **GENERAL CONSTRUCTION REQUIREMENTS:** 

1.Construction fence shall be chain link fence with green wind screen and shall generally follow contract limit line. Coordinate with the owner in the field to confirm exact layout. TREE PROTECTION:

. It is the intent of this contract to avoid any disturbance to existing trees or shrubs on the site other than those specifically designated for removal. Adjustments shall be made in the field at the direction of the

landscape architect.

SITE PREPARATION:

2. Protect all existing trees and shrubs to remain. 3. Tree protection fence shall be green plastic snow fence. Prune existing trees to be protected.

. Excavated materials which are utilized on site in fill areas shall be subject to testing. 2. Stripped topsoil shall be stockpiled inside contract limit line or as directed by the owner. in all cases, straw bales or silt fence shall be installed at the toe of the stockpile to prevent erosion. All topsoil shall be

screened and tested as specified. STORM DRAINAGE:

Refer to grading plan for all proposed site drainage structures, castings and storm water piping.

2. Maintain the integrity of the existing storm drainage system at all times. 3. Refer to site preparation plans for resetting or abandoning of structures.

**EROSION CONTROL:** 

1. Straw bales and/ or silt fence shall be staked in place as required and as directed by the landscape architect, to prevent erosion and to limit flow of soil materials during construction.

. Contractor shall submit a schedule of demolition for approval by the owner. 2. Contractor is advised to visit the site to become aware of items scheduled for demolition which may have been removed during any advanced construction.

**SAW CUTTING:** . When new pavement is to be placed against existing pavement, the existing pavement shall be sawcut to an even base course. Protect sawcut edge until installation of new pavement. cut the top course back 12" further than the cut of the base course.

1. All materials removed from the site shall be disposed of in a safe and legal manner. Removal of pavements and existing curbs, if any, shall be for the full depth including base courses. Remove any footings associated with site improvements to be removed.

1. All line and grade work not presently established at the site shall be laid out by a registered engineer/ land surveyor employed by the contractor in accordance with drawings and specifications. 2. The landscape architect shall verify layout of pavements, light fixtures, and planting in field before final installation.

**ADJUST UTILITIES:** 1. Adjust, as required, all existing utility frames, grate covers, etc. that are to remain to finish grade. 2. Obtain landscape architect's approval of location and elevation of new light bollard base forms prior to

delivery of concrete. 3. Cap and abandon as required, existing drainage structures.

1. Remove and deliver to the owner all signs required for removal to complete the work of this contract.

**SPECIAL REQUIREMENTS:** 1. Contractor's personnel shall exercise care to refrain from using loud and/or abusive language on site. 2. This is a 'NO SMOKING' project site. Violation of this policy shall result in a fine of \$1,000.00 per

3. Contractor shall clean their work area at the completion of each day's work. This shall include removal of all trash and reasonable stockpiling of materials and equipment in an organized and safe manner. Violation

of this policy shall result in a fine of \$500.00 per occurrence. 1. All walk pavement shall have a minimum 1 1/2% and a max of 2% cross pitch unless otherwise indicated

2. From time to time there are changes made in the handicap accessibility codes. Such changes may occur

during the course of the construction of this project if changes become necessary to meet codes, a change order will be issued to cover statutory requirements.

PERMITS AND CODES:

1. All work under this contract shall be installed in accordance with the laws, ordinances, rules and regulations of all city, state, and federal authorities having jurisdiction.

2. Should changes in the drawings and/or specifications be required to conform to these rules, the contractor and this subcontractor shall notify the landscape architect at the time of submitting his bid; otherwise he shall be held to perform all work necessary for as approved installation without extra expense to the owner. 3. Apply and pay for permits, certificates of inspection and licenses in connection with this work; deliver it to the landscape architect at the completion of the work.

**GUARANTEES:** 

1. In addition to manufacturers' guarantees, the contractor shall warrant all work of site improvements including all planting, both parts and labor, for a period of two (2) years from date of acceptance by the owner. The contractor shall be held responsible for all parts of his work. If failure in the work develops within two (2) years of the date of final approval and acceptance of the work, the contractor shall be required to replace all faulty materials at his full expense.

LANDSCAPE ARCHITECT



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PROJECT NAME

130 Turner Street

Waltham, MA

PROJECT TEAM




REVISIONS

DRAWING TITLE

Existing Conditions Plan

DRAWING INFORMATION



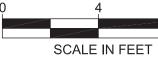

DRAWING NUMBER

**DRAWING LIST** 


L-1 Existing Conditions L-2 Site Preparation Plan


L-3 Grading Plan


L-4 Layout and Materials Plan L-5 Planting Plan

L-7 Details L-8 Details L-9 Details

L-6 Details

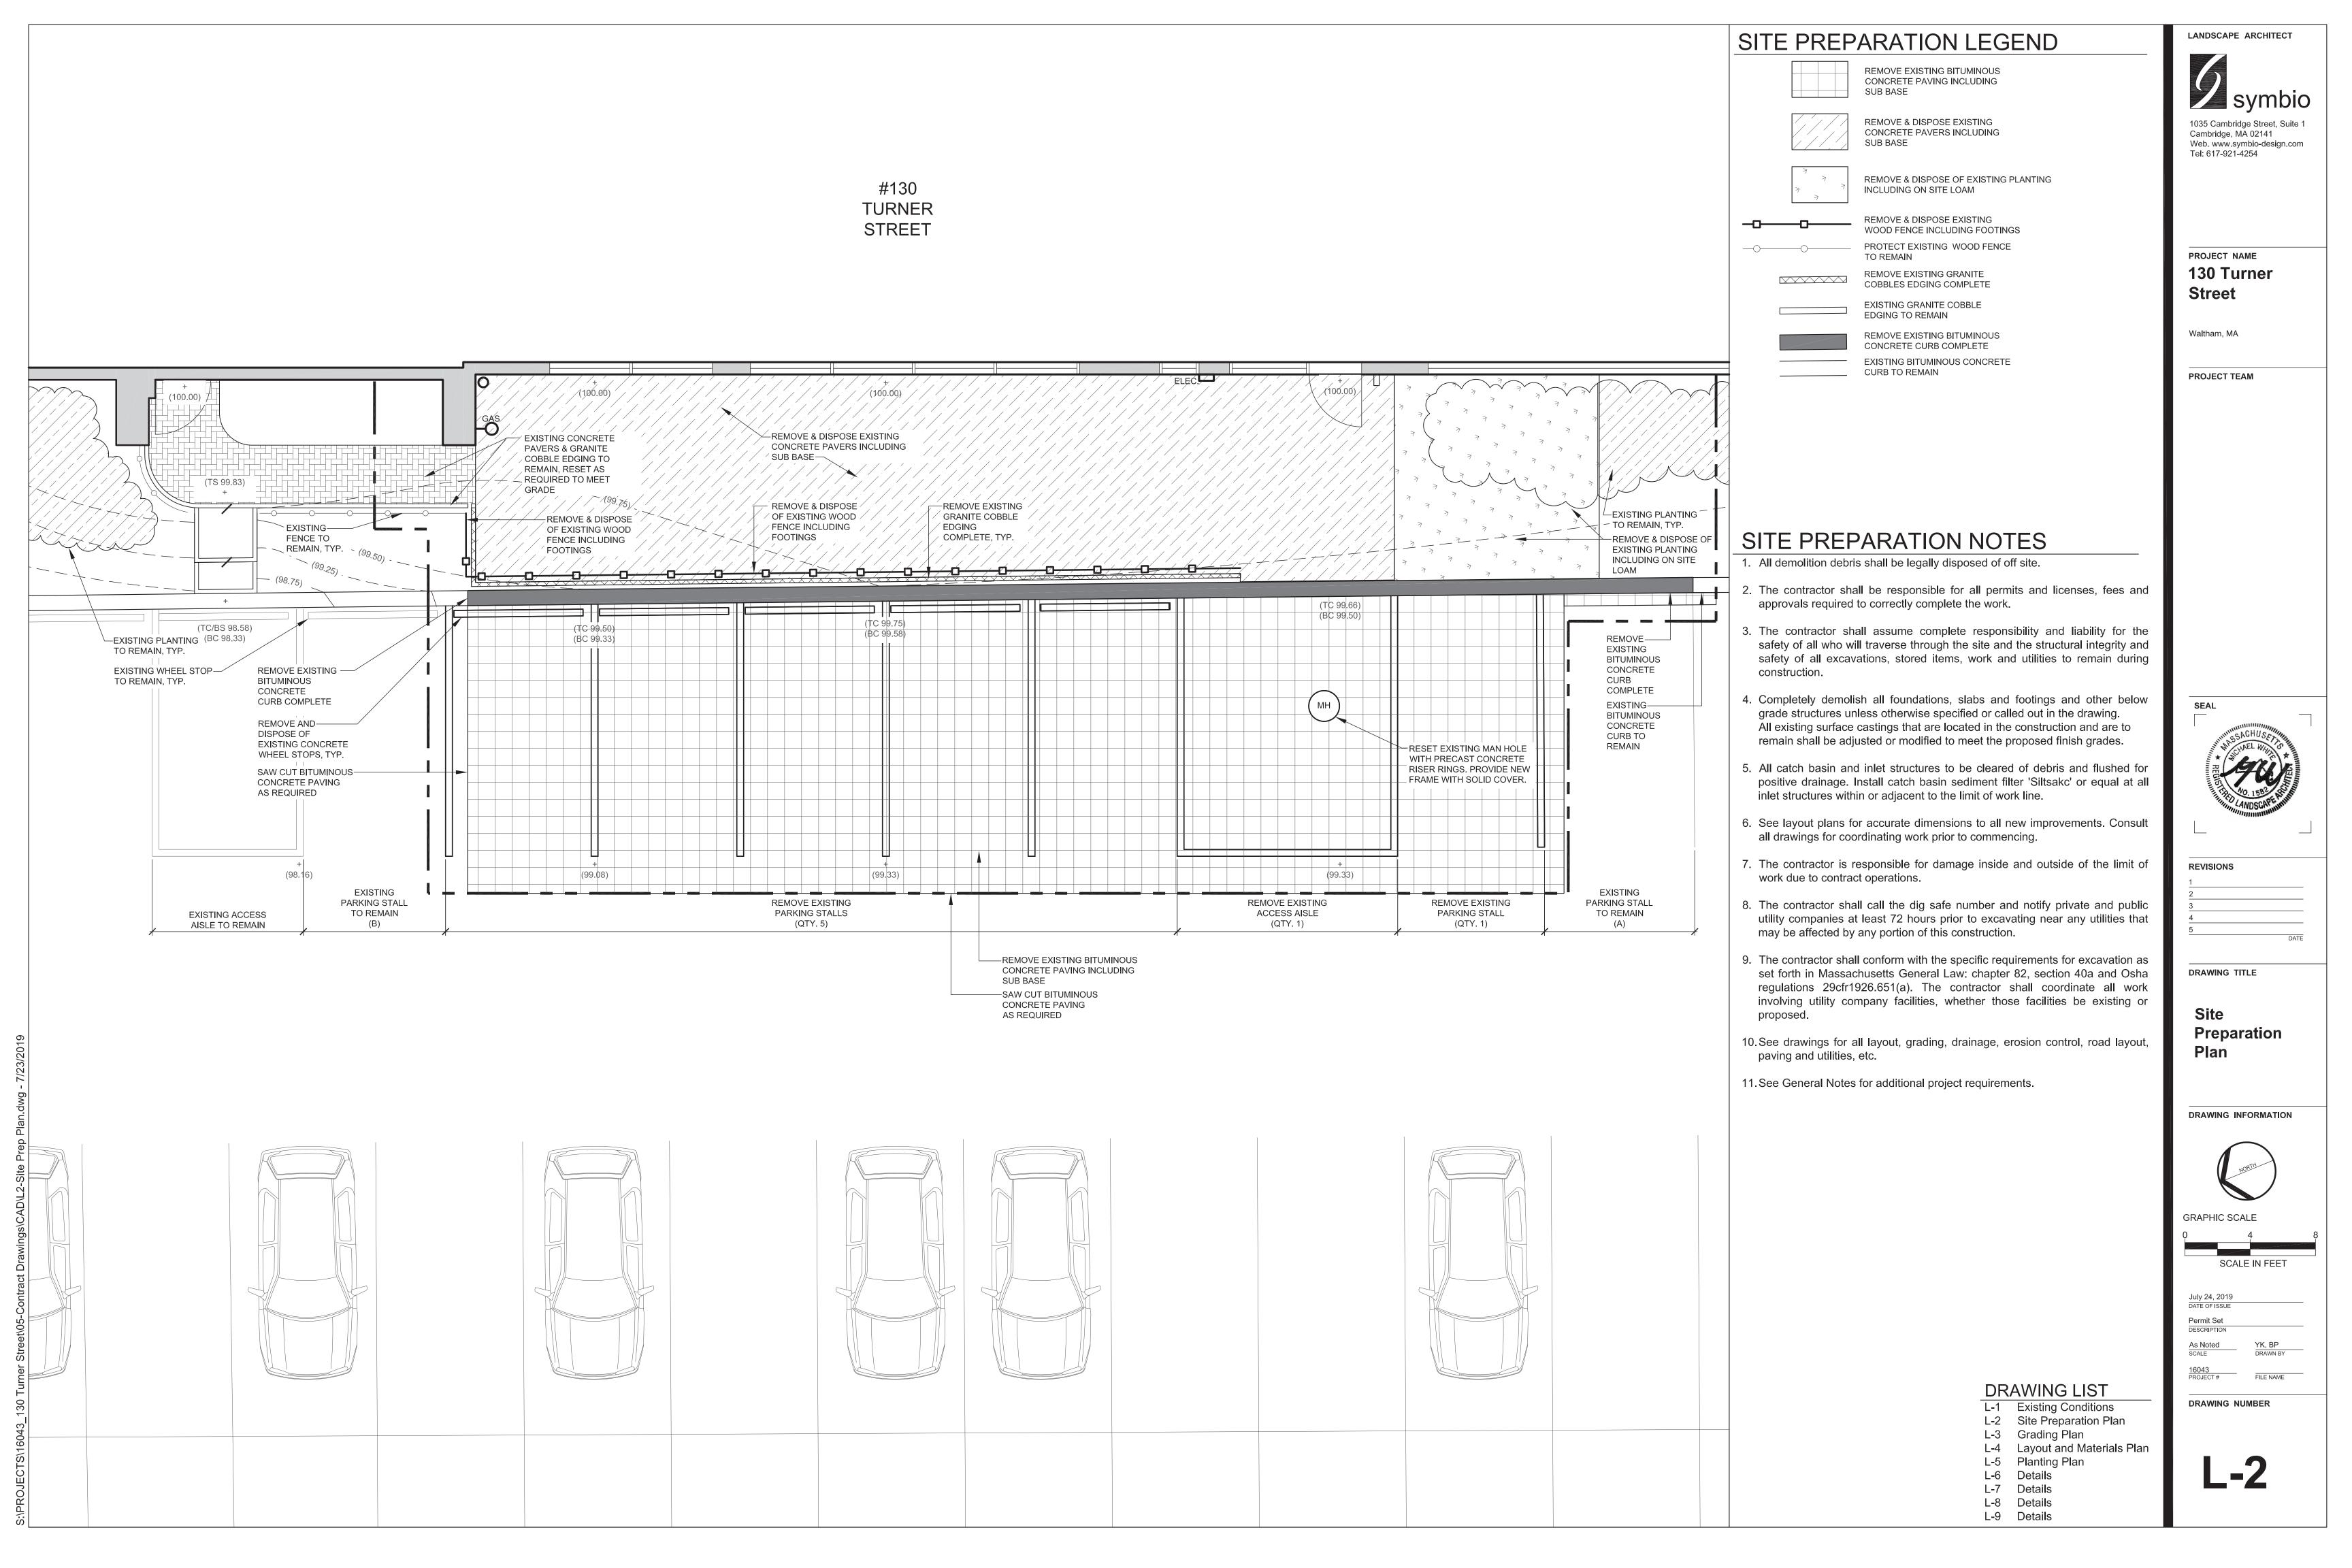

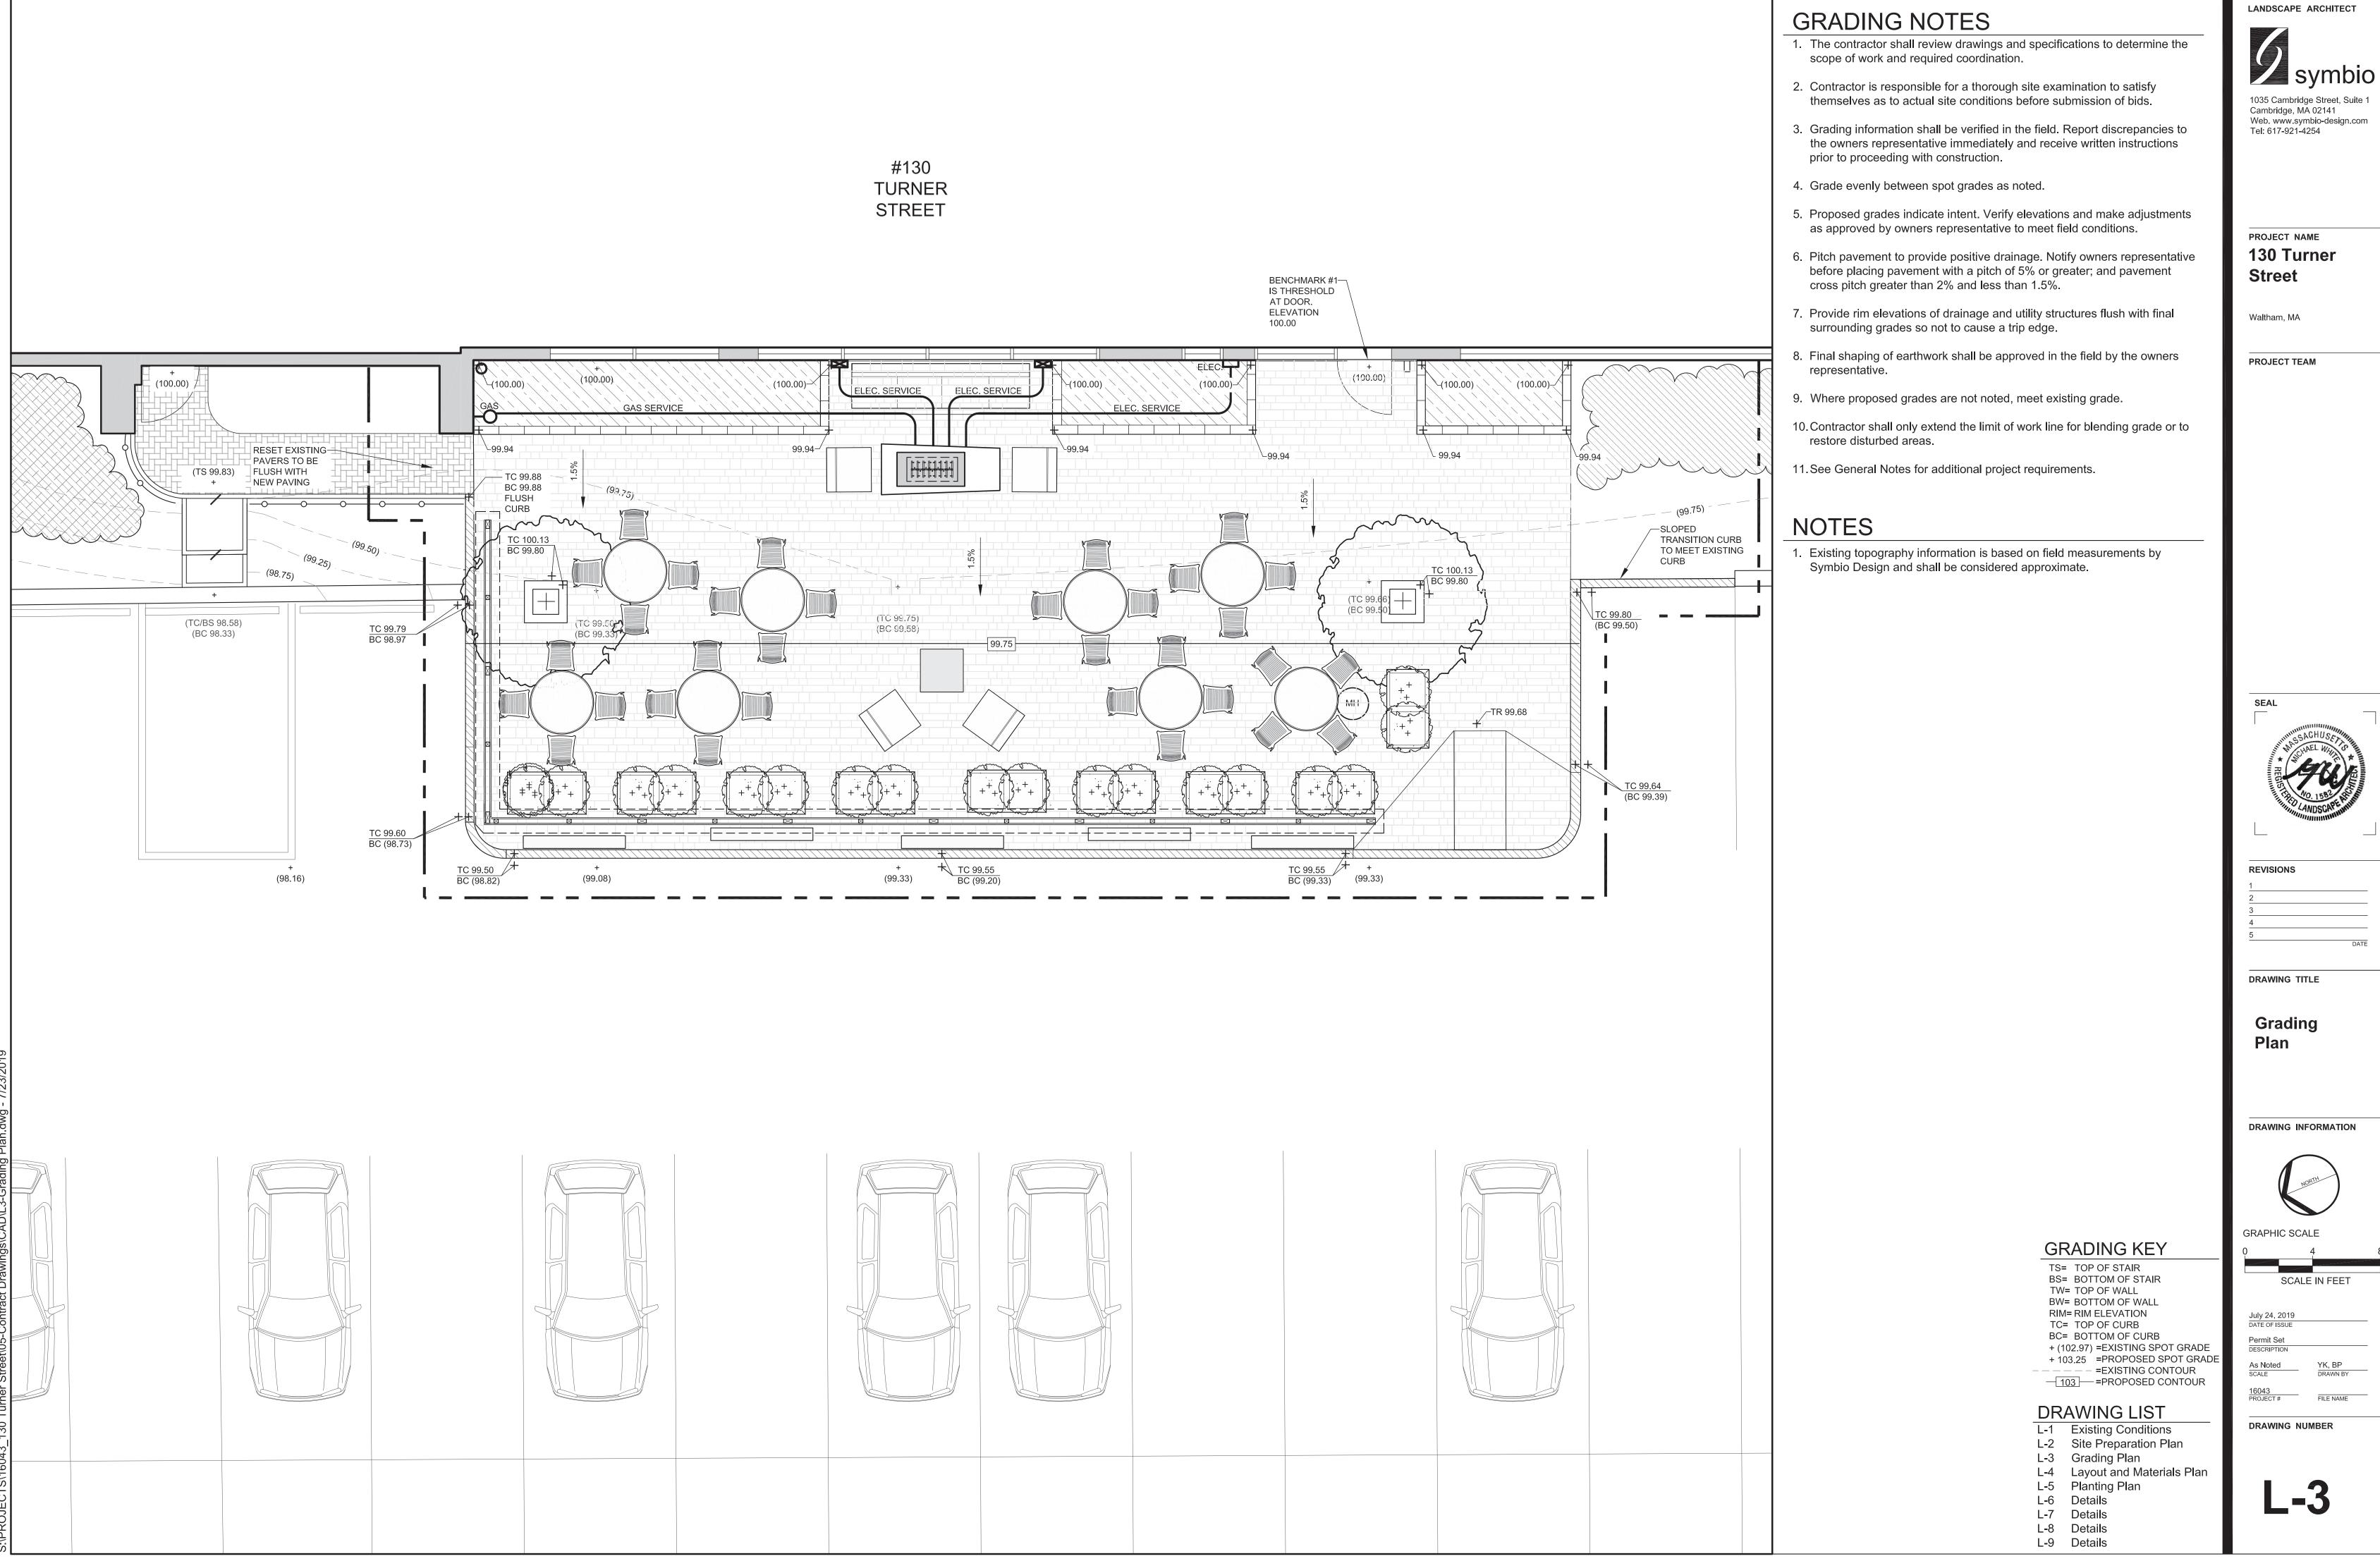

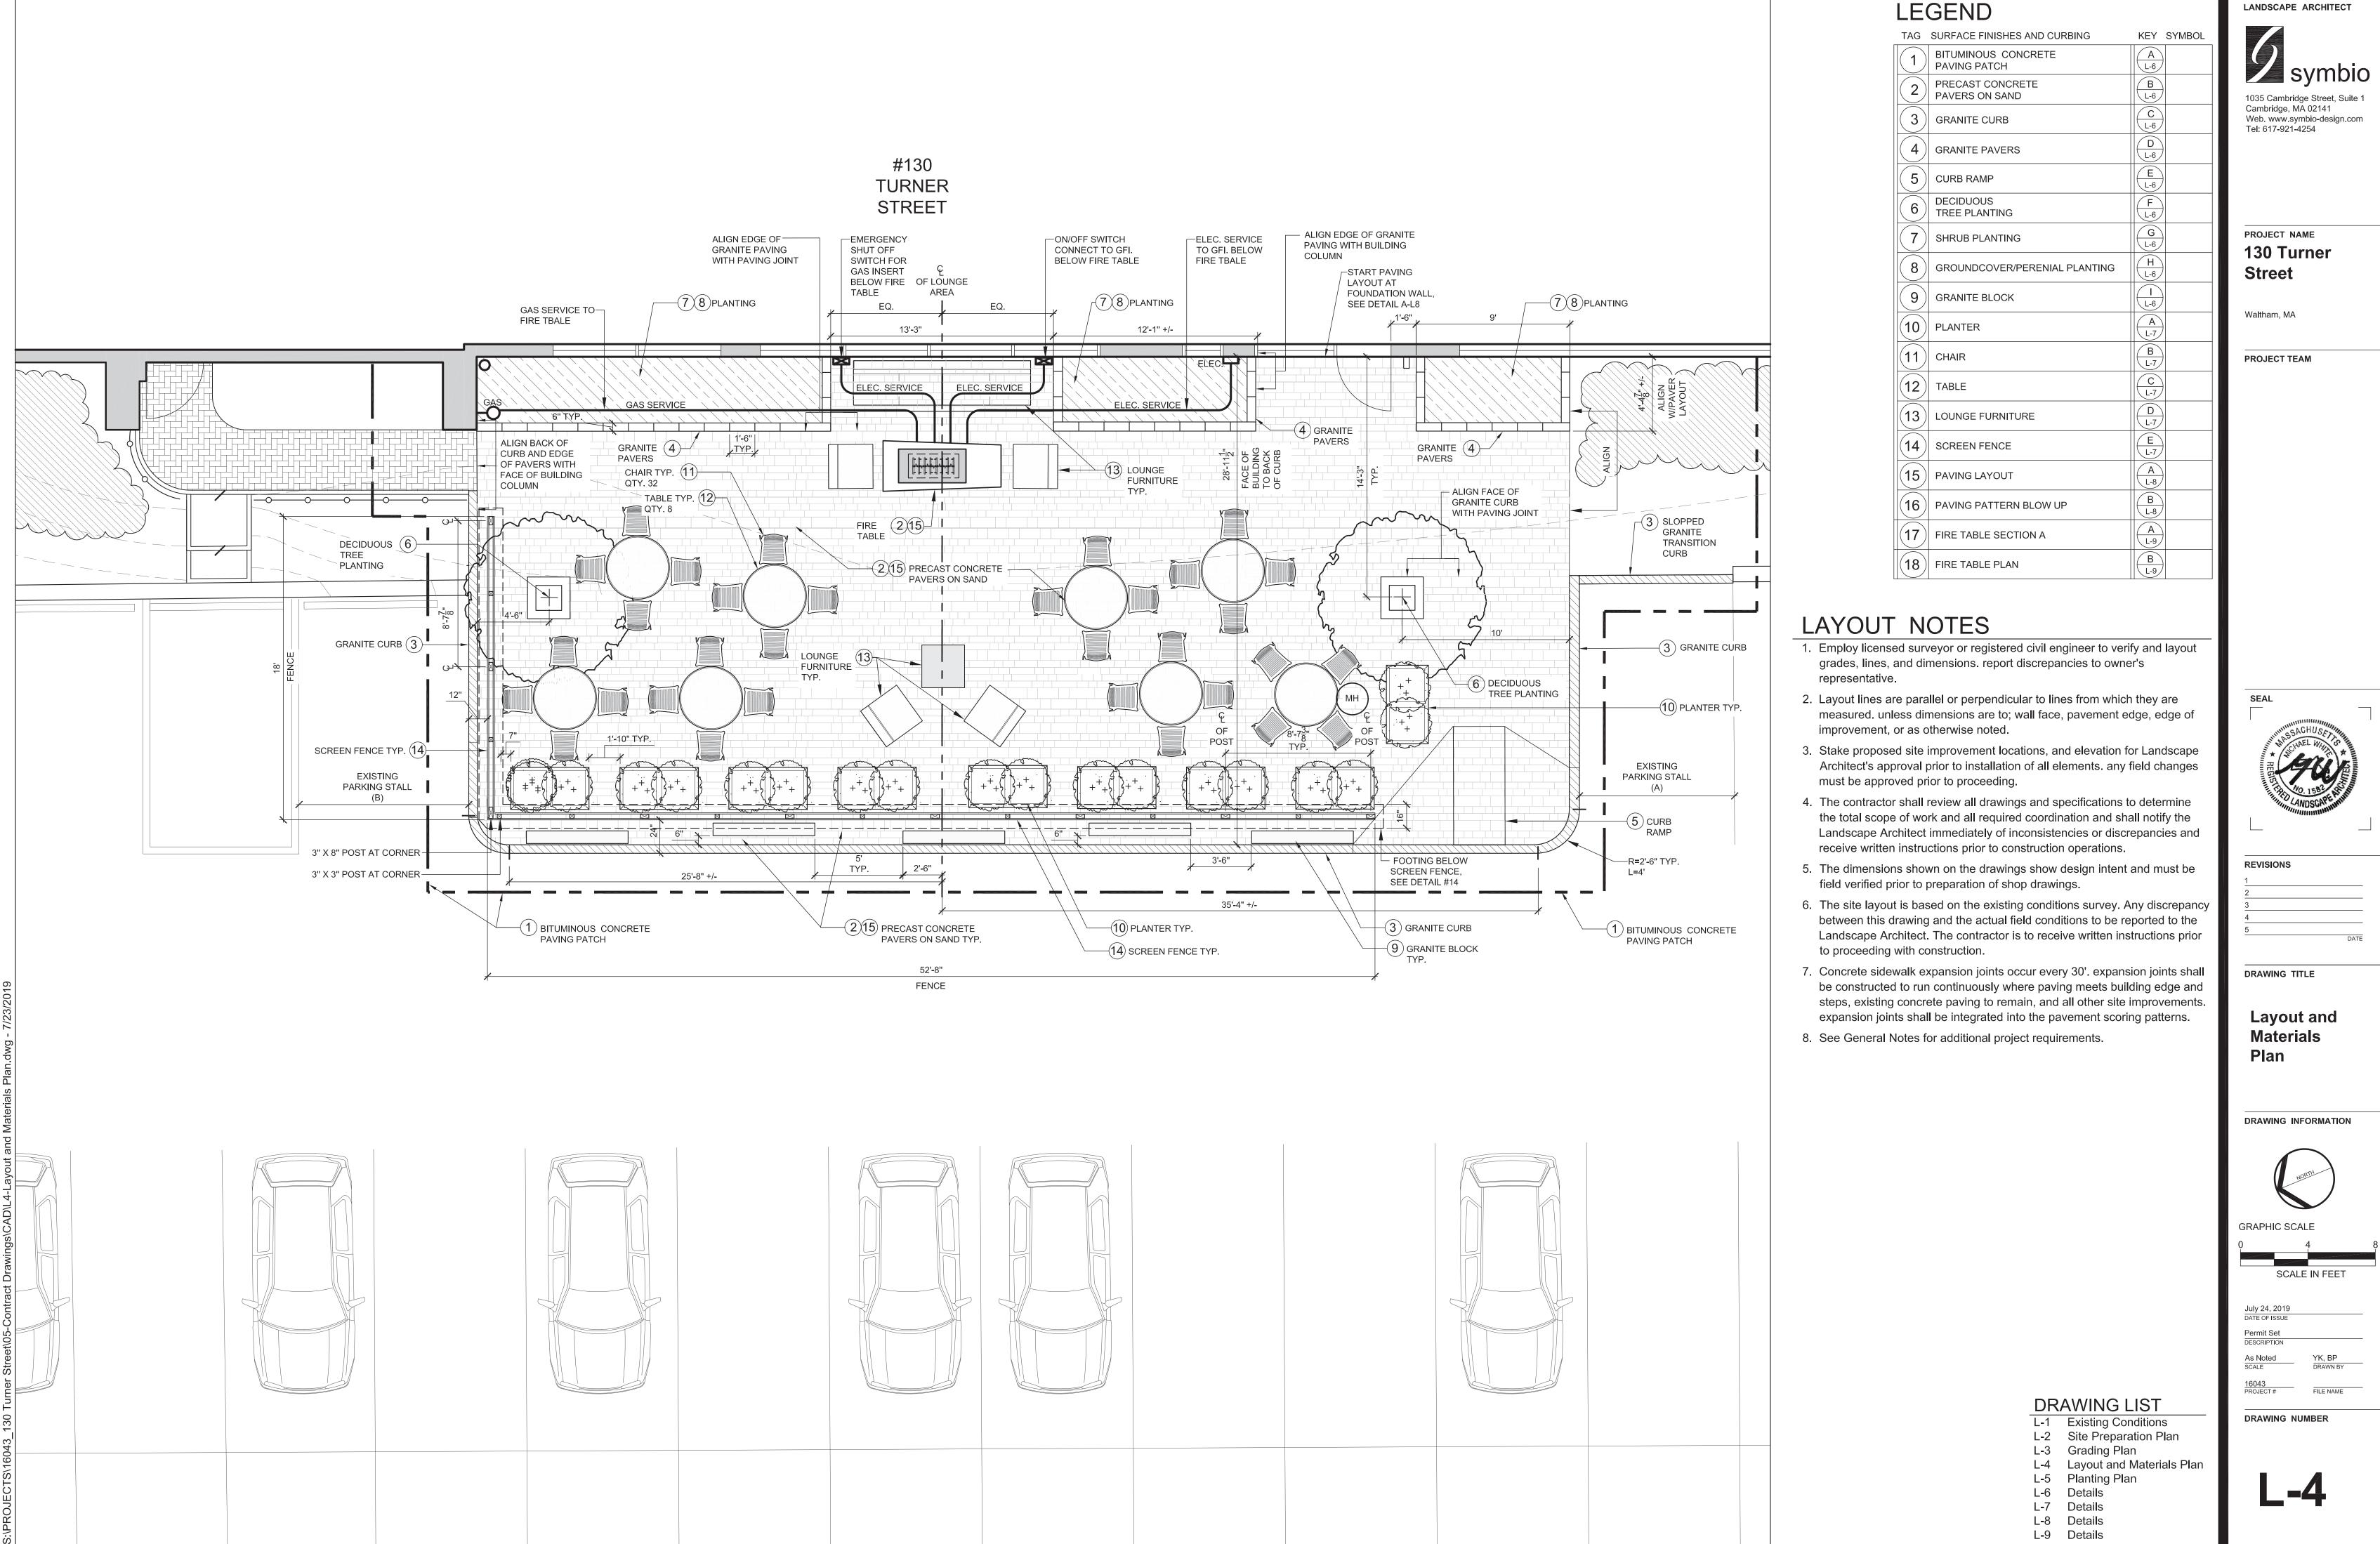

LANDSCAPE ARCHITECT

### PLANTING NOTES

- Loam for lawns and planting shall be "sandy loam" per USDA classifications w/ PH of 6.0-6.5 ,organic matter of 5%-10% and CEC, cation exchange capacity of 10-15. Amend planting soil w/ compost and loam for lawns w/ organic fertilizer.
- 2. Bottom of plant beds to be set 15" below finished grade and 5"-7" below finished grade at all lawn areas.
- 3. Provide and place 15" depth planting soil at all beds and 6" depth loam at all lawn areas.
- Contractor to review, comment and accept site conditions for incorporation into their work prior to commencing work under this contract.
- The contractor shall supply all plant materials in quantities sufficient to complete the planting shown on this drawing. The landscape architect shall review and approve all plant materials, at the nursery, prior to delivery to the site.
- Plant pits for tree planting shall be dug three times the width of the root ball and as deep as the ball. Plant pits and planting beds shall be backfilled with the removed soil and amended planting mix in lifts to avoid air pockets in backfill. Slow release fertilizer packets shall be installed with all plant materials at time of planting. Follow manufacturer's instructions for fertilizers.
- . All plant material to be set plumb, and at the same relationship with finish grade as it bore in nursery.
- 8. All burlap, wire baskets and other materials attached to plants shall be removed prior to planting. Care shall be taken not to break or disturb the root ball of plants.
- 9. All plants shall be watered immediately after planting.
- 10. 3" dark hardwood mulch shall be spread over all plant beds. Mulch shall not touch trunk of shrubs and trees. Provide sample of mulch for review and approval
- 11. The contractor shall maintain all plants for thirty (90) days after the completion of plant installation. Maintenance shall consist of keeping all plants in a healthy growing condition as well as watering. Contractor to supply temporary irrigation for maintenance period.

- 12. No root ball is to be located within 12" of the foundation wall.
- 13. Contractor shall locate and verify with Landscape Architect all trees, shrubs, perennials, and/or groundcover to remain, be removed, or transplanted.
- 14. Protect in place existing trees, shrubs, and groundcover to remain.
- 15. All new planting material shall conform to minimum guidelines established by the American Standard for Nursery Stock published by the American Association of Nurserymen, Inc. (ANN).
- 16. Confirm location of all proposed planting for approval by the Landscape Architect prior to the commencement of planting.
- 17. In the event that quantity discrepancies or material omissions occur between the plant materials list and the drawings, the higher number of plants shall govern. The contractor shall report any discrepancies to the Landscape Architect.
- 18. Any proposed substitutions of plant species shall be made with plants of equivalent overall form, height, branching habit, flower leaf, fruit, color, and culture and must be approved by Landscape Architect.
- 19. Contractor shall warranty all work including labor, materials and all miscellaneous charges including delivery and off loading costs for a period of two (2) years. At the request of Landscape Architect, Contractor will promptly replace or repair any work, equipment, or materials that fail to function properly for a period of (2) years after completion of the project.

## PLANT SCHEDULE

Trees SYMBOL	QTY	SCIENTIFIC NAME	COMMON NAME	SIZE	COM MENTS
GB	2	Ginkgo Biloba	Ginkgo	4" cal.	B&B
Shrubs SYMBOL	QTY	SCIENTIFIC NAME	COMMON NAME	SIZE	COM MENTS
HQ	12	Hydrangea quercifolia 'Munchkin'	Dwarf Oakleaf Hydrangea	2.5' -3' ht.	CG
JC	12	Juniperus conferta 'Blue Pacific'	Shore Juniper	2.0' -2.5' sp.	. CG

Ferns, Perennials, Vines, Grasses and Groundcover											
SYMBOL	SYMBOL QTY SCIENTIFIC NAME COMMON NAME				SPACING	COM MENTS					
AC	80	Astilbe arendsii 'Bridal Veil'	Bridal Veil Astilbe	2 gal.	18" O.C.	CG					
EF	200	Euonymus fortunei 'Coloratus'	Purple Leaf Wintercreeper	1 gal.	8" O.C.	CG					
IS	50	Iris sibirica 'White Swirl'	Siberian Iris	1 gal.	18" O.C.	CG					
LS	182	Liriope spicata	Creeping liriope	1 gal.	12" O.C.	CG					

DRAWING LIST L-1 Existing Conditions

L-2 Site Preparation Plan L-3 Grading Plan

L-4 Layout and Materials Plan L-5 Planting Plan

L-6 Details L-7 Details L-8 Details L-9 Details

LANDSCAPE ARCHITECT 1035 Cambridge Street, Suite 1 Web. www.symbio-design.com PROJECT NAME 130 Turner Street Waltham, MA **PROJECT TEAM** REVISIONS DRAWING TITLE

**Planting** Plan


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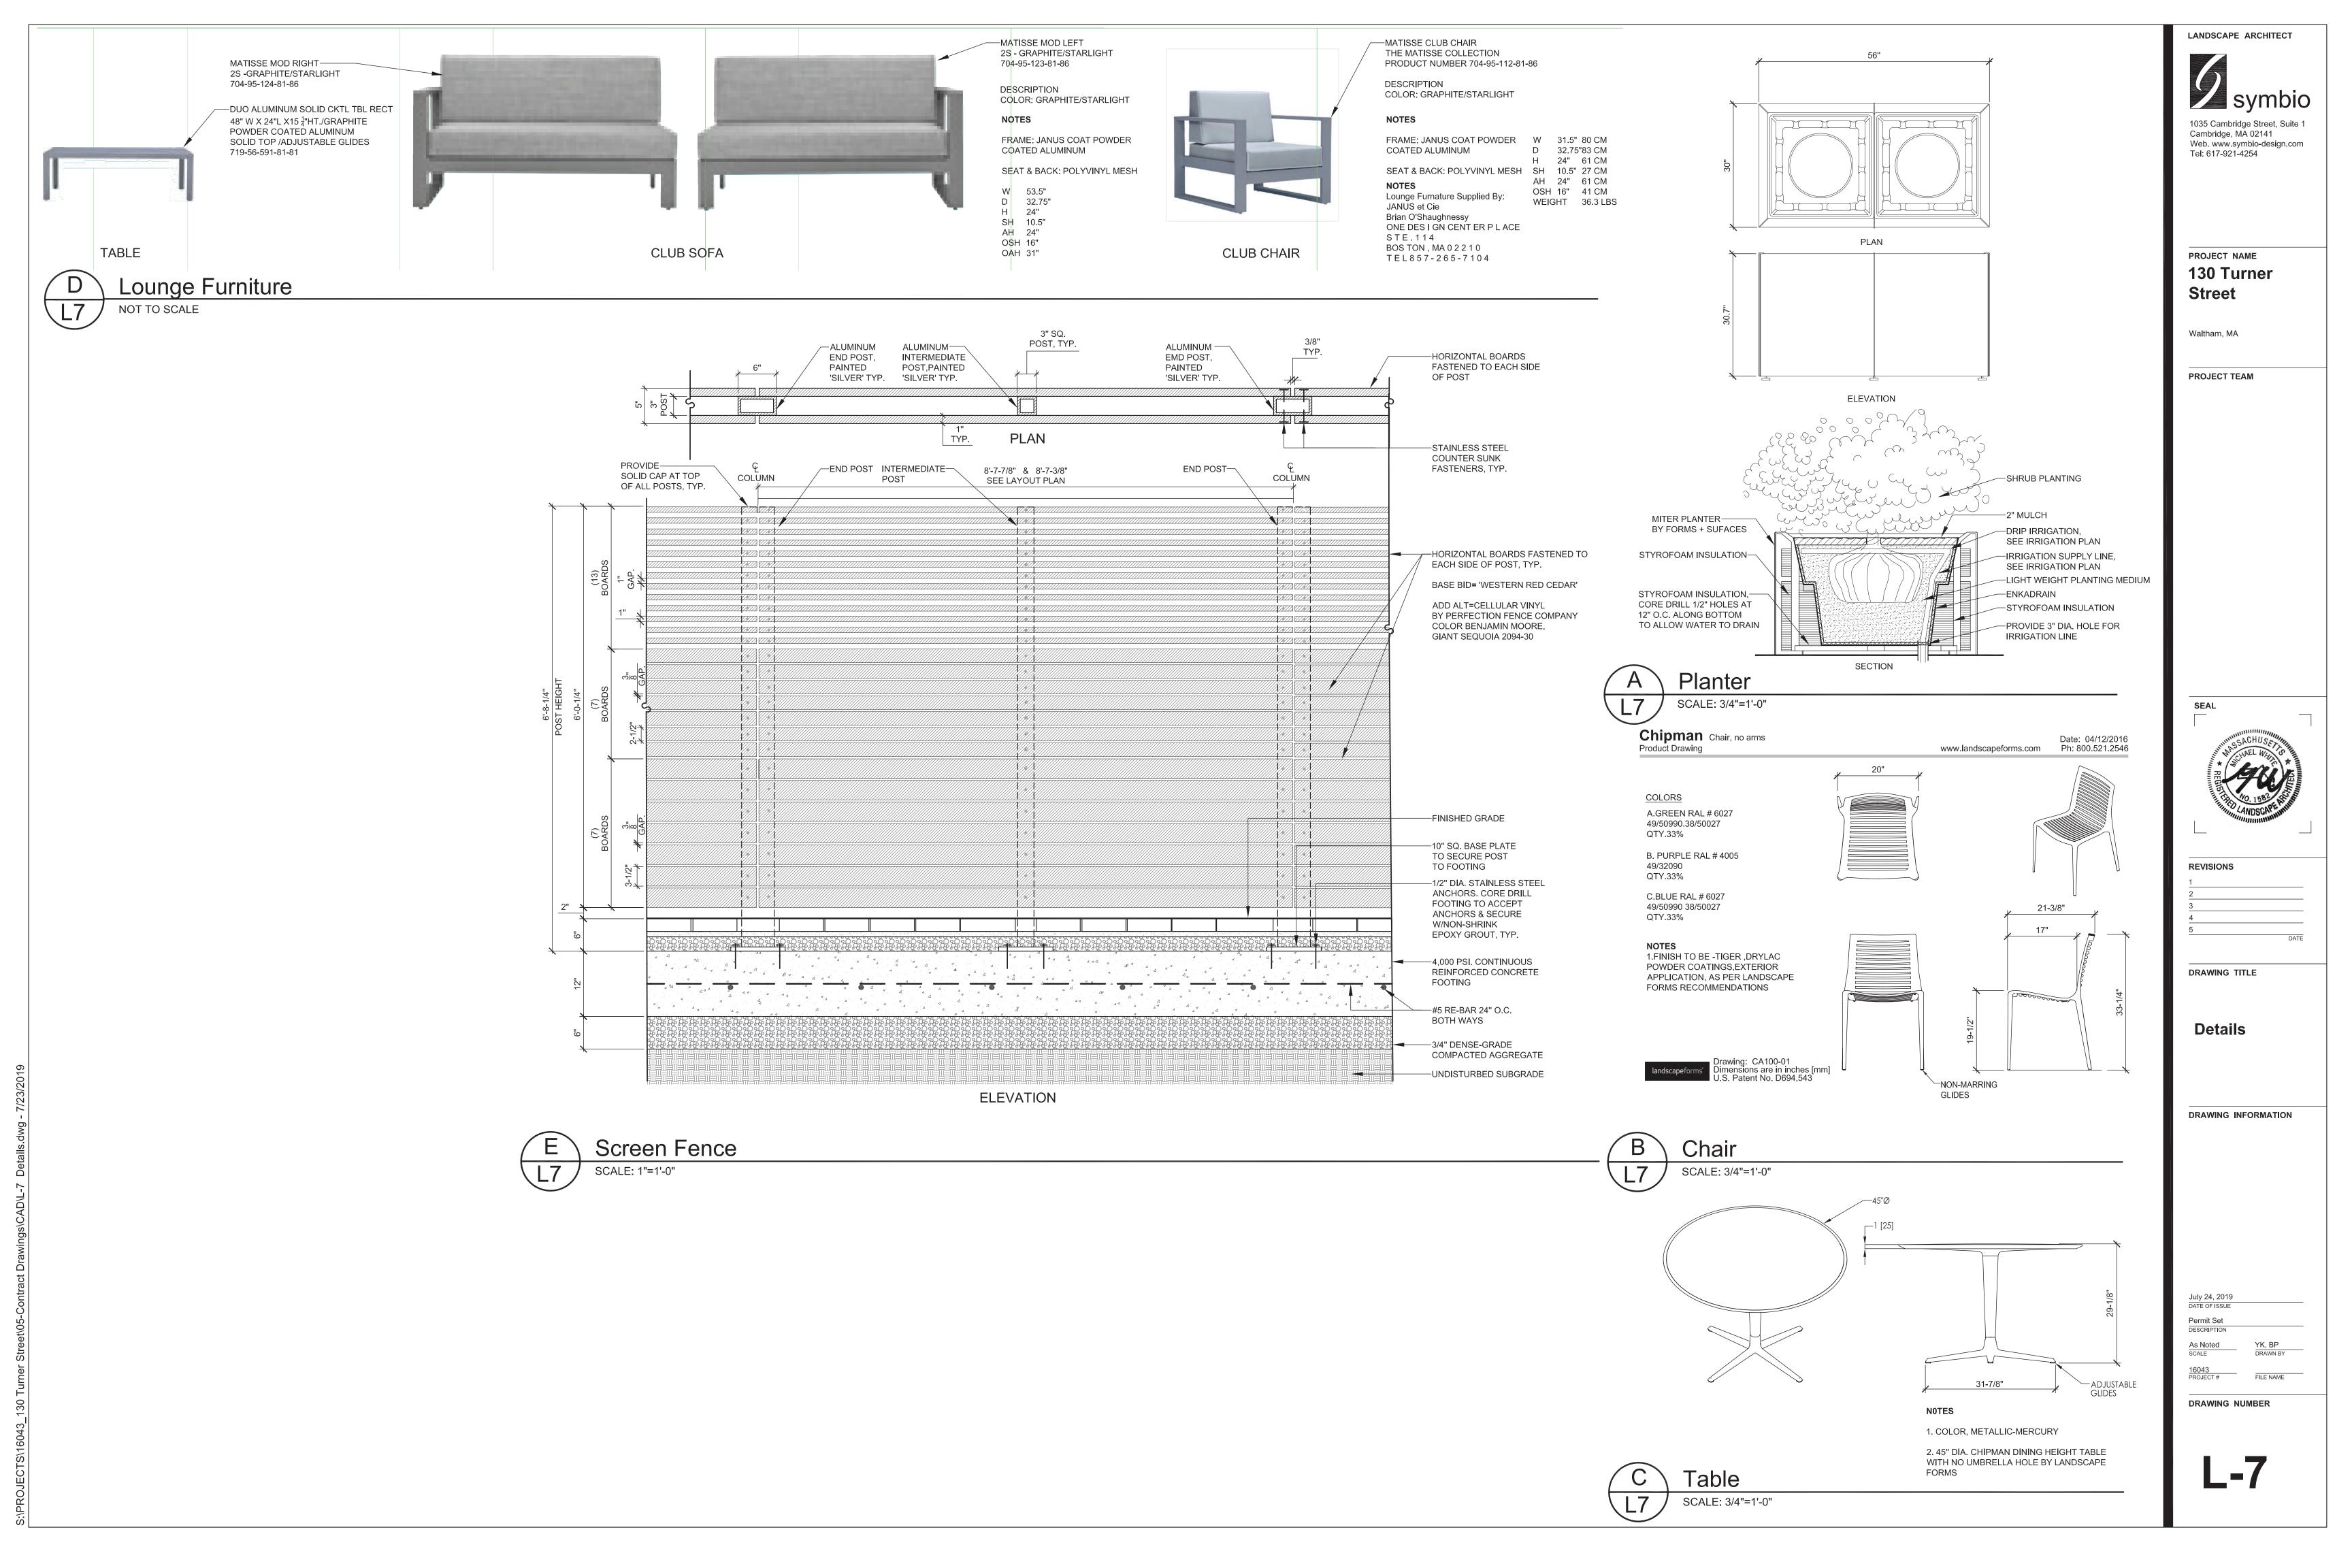



**GRAPHIC SCALE** 


SCALE IN FEET

FILE NAME DRAWING NUMBER



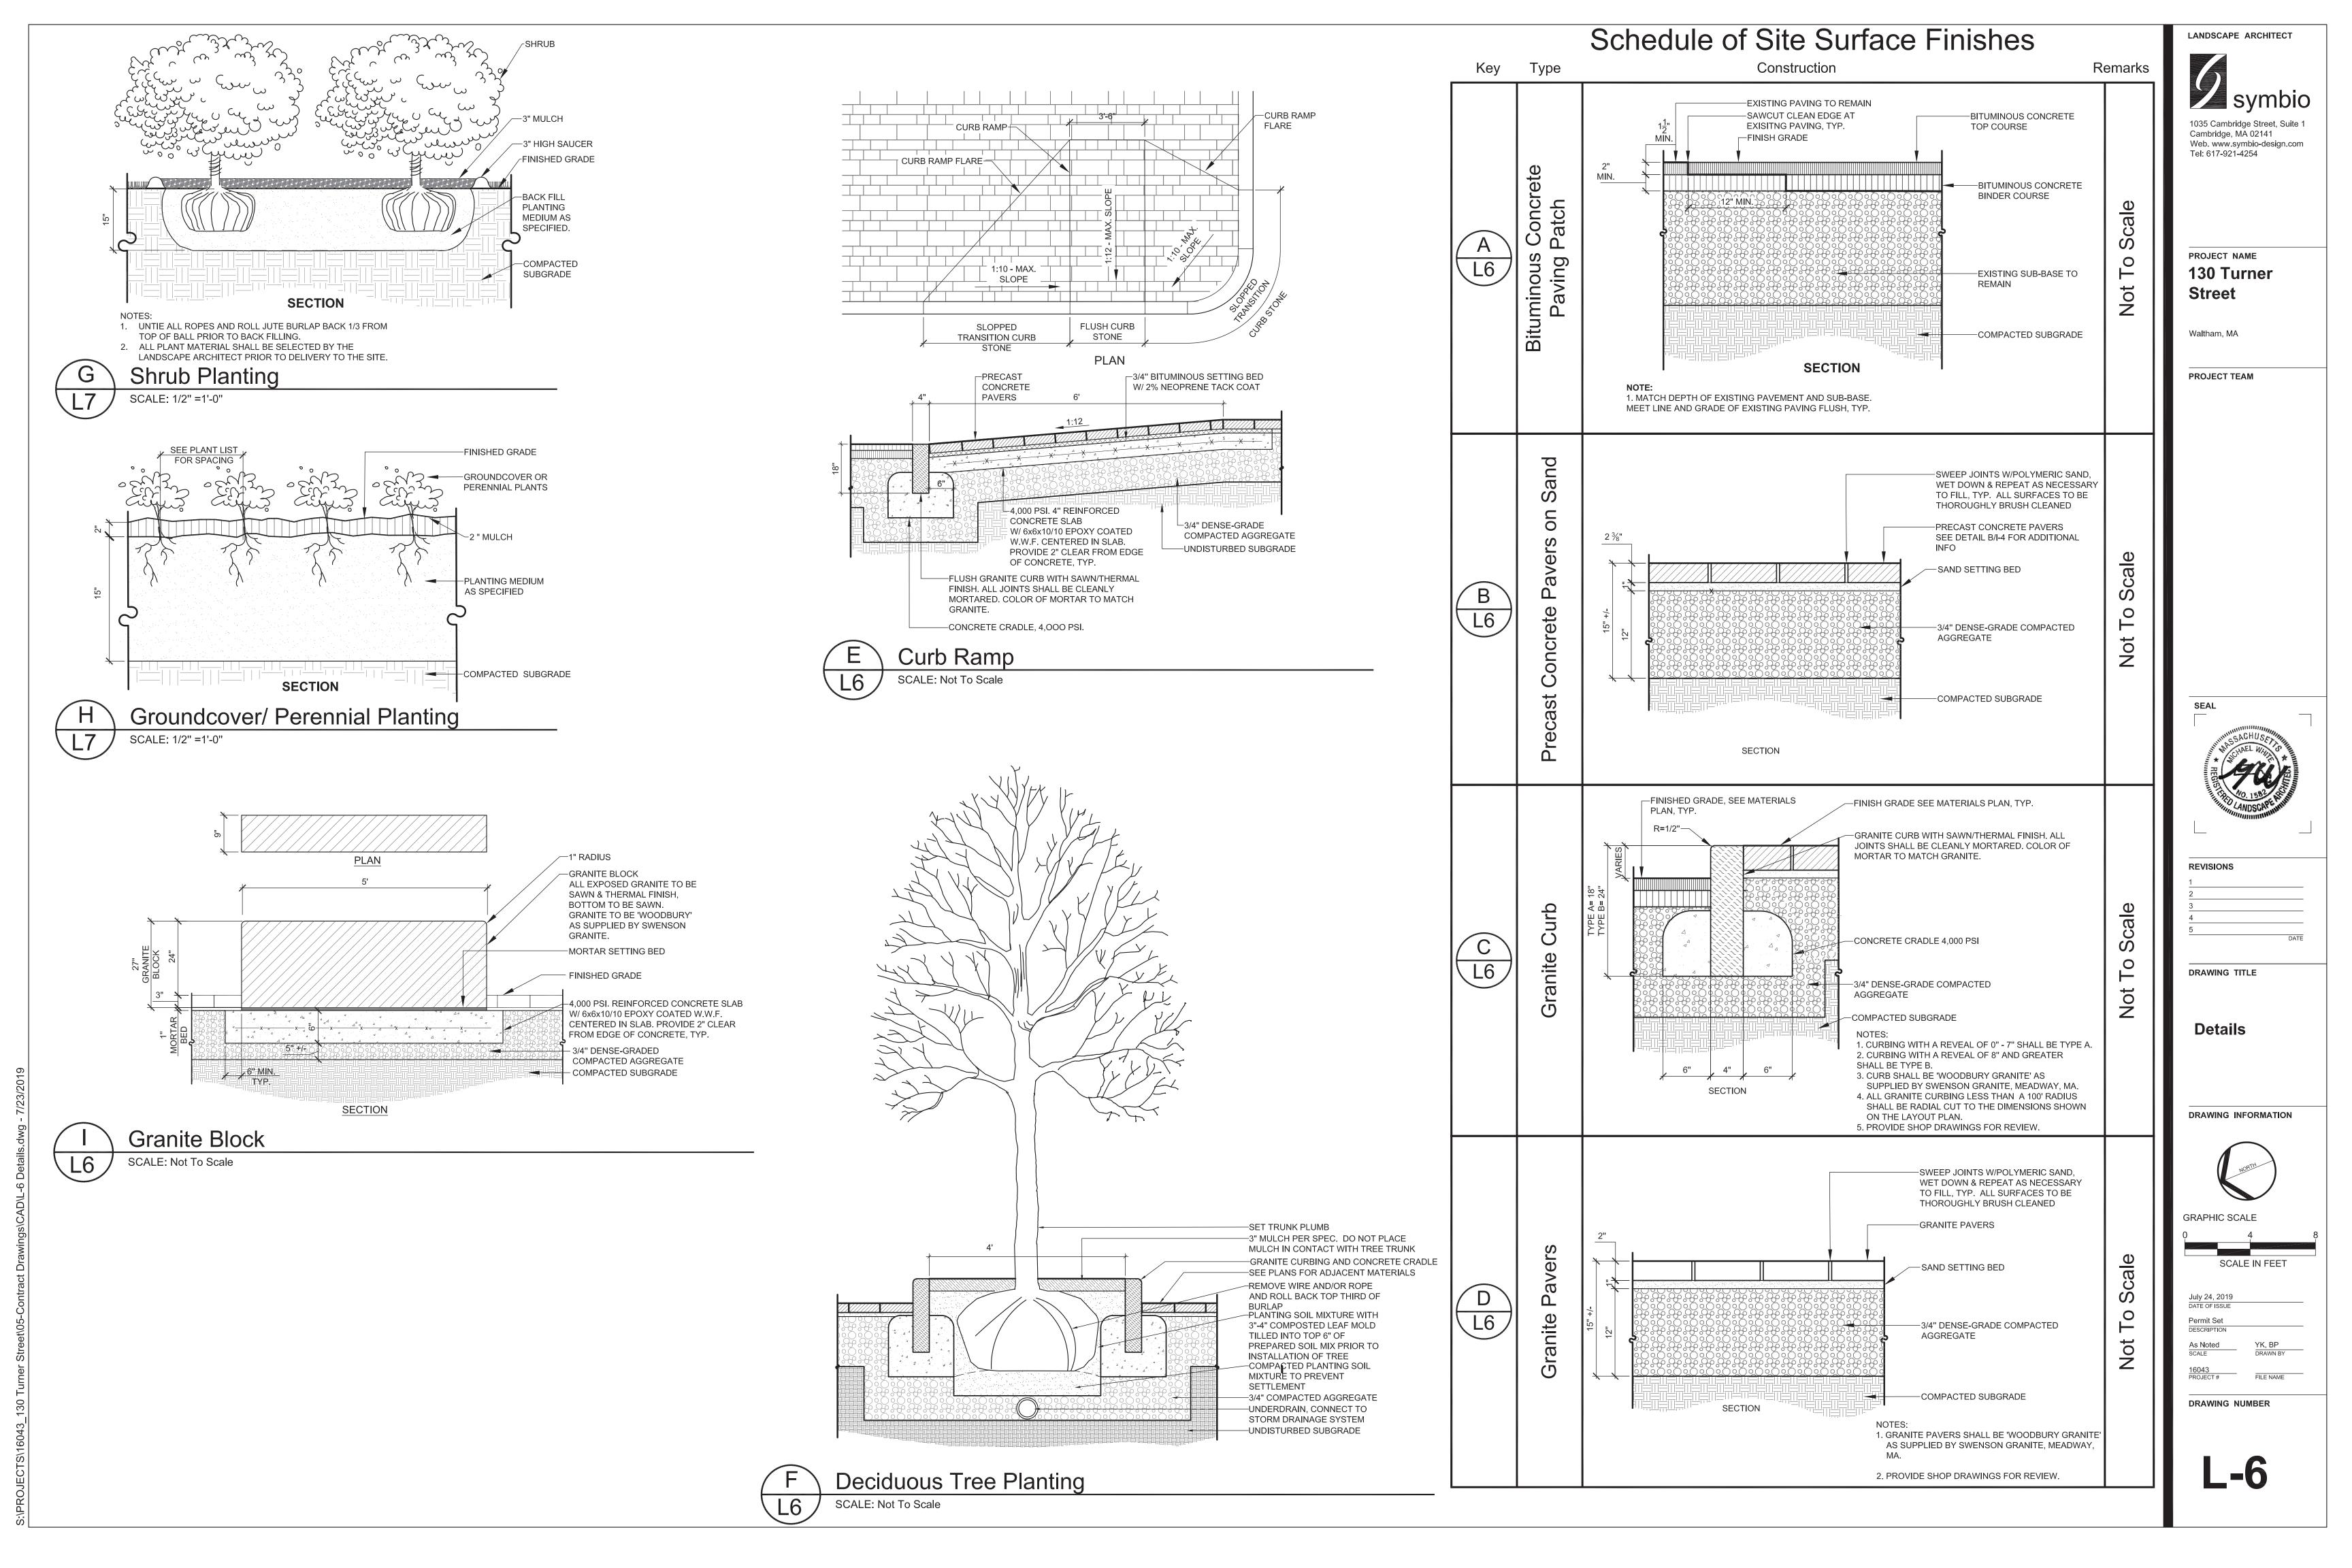


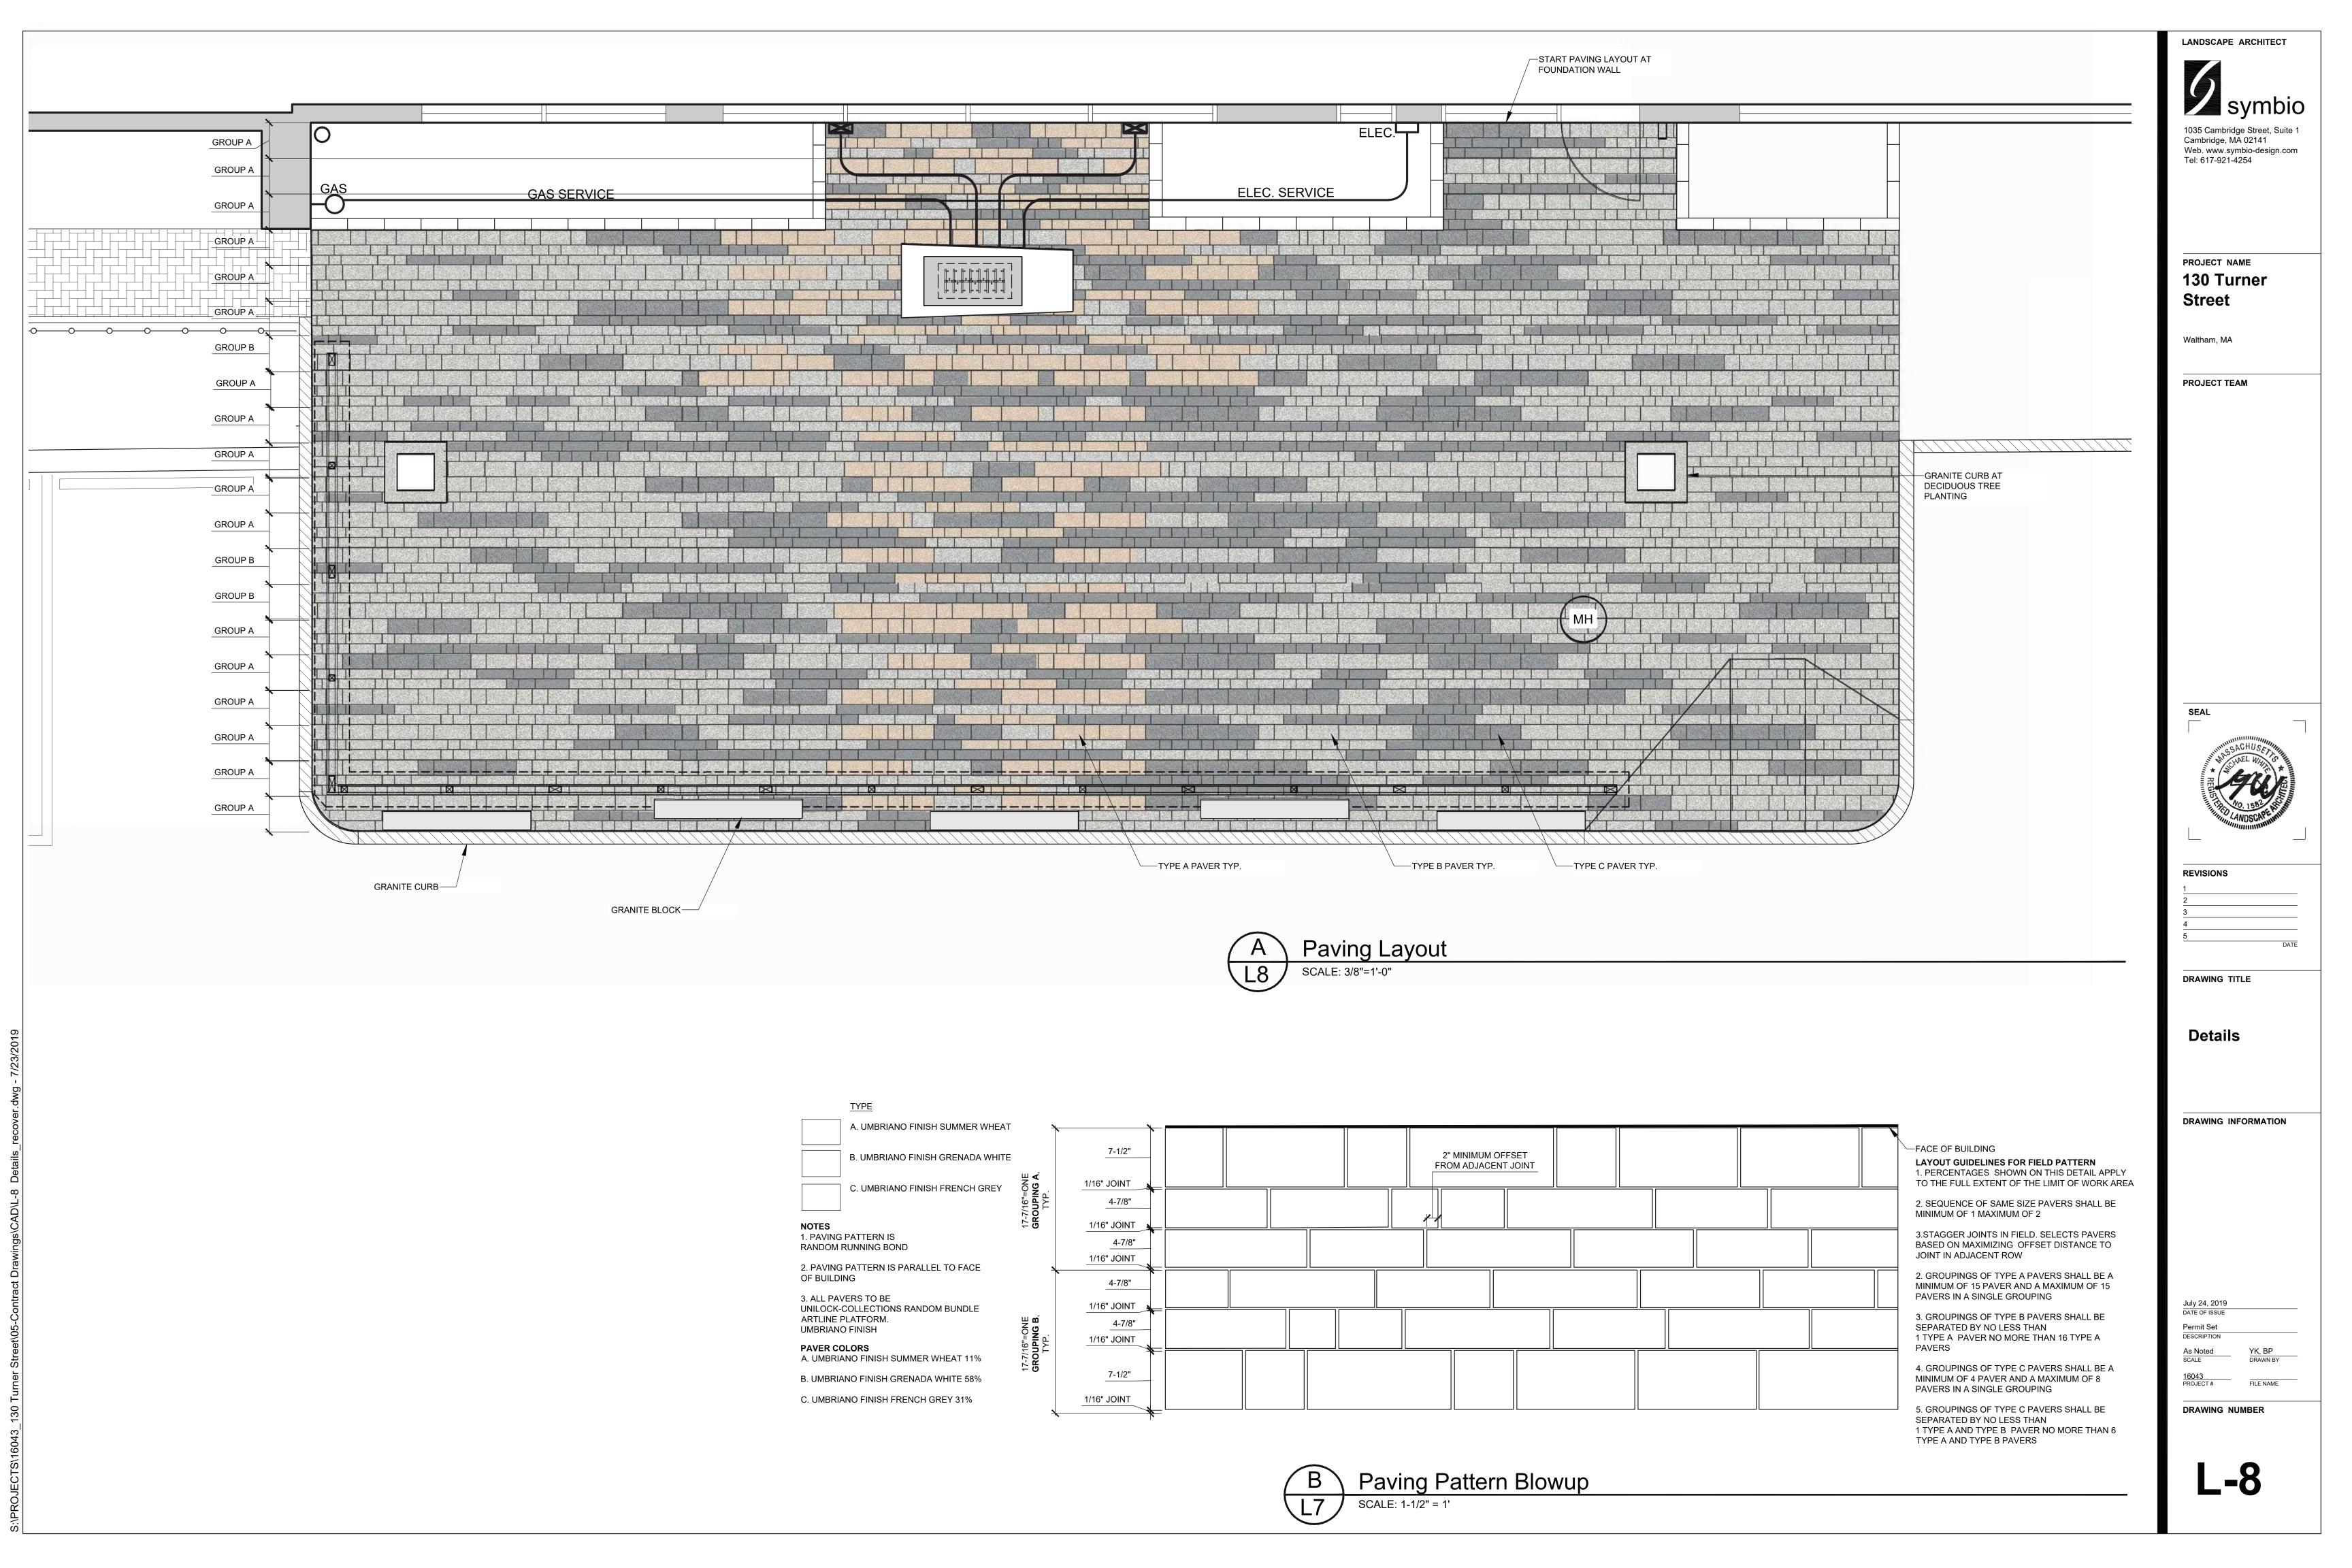

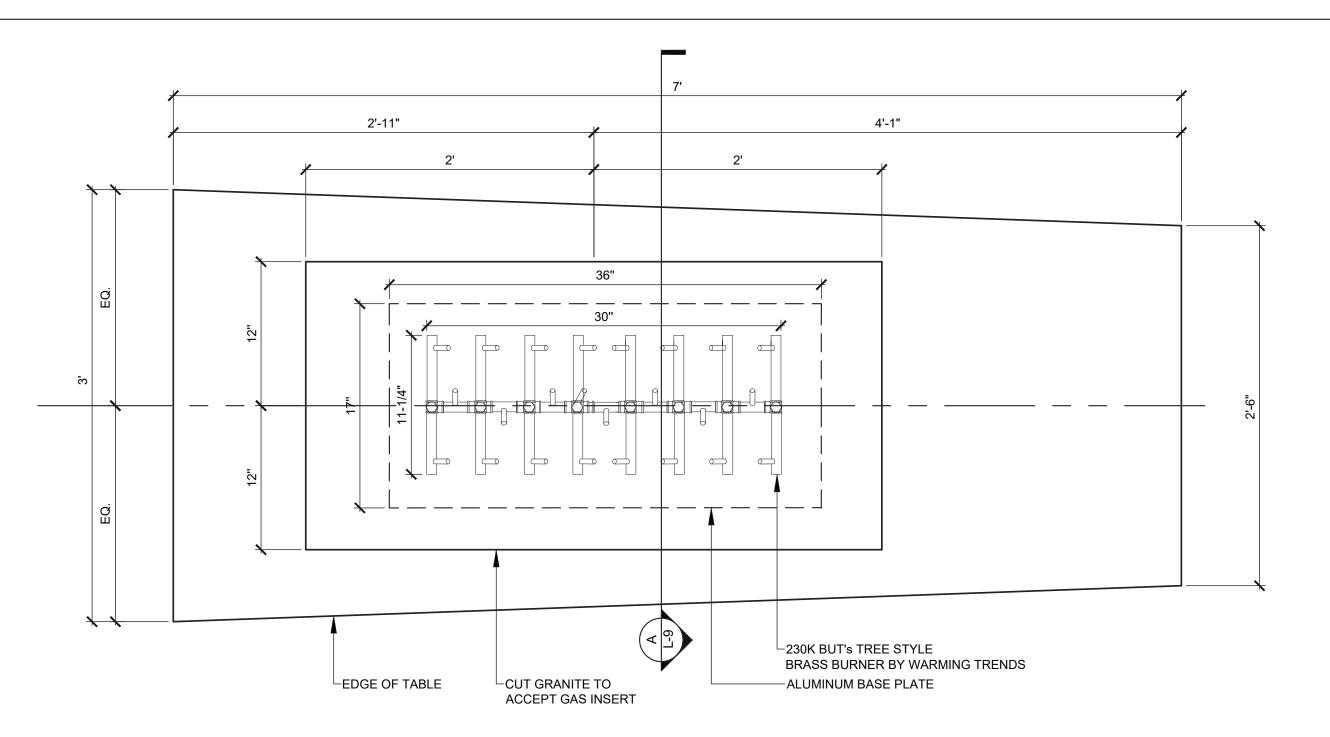


Fire Table Plan

L-9 SCALE: 1-1/2"=1'-0"

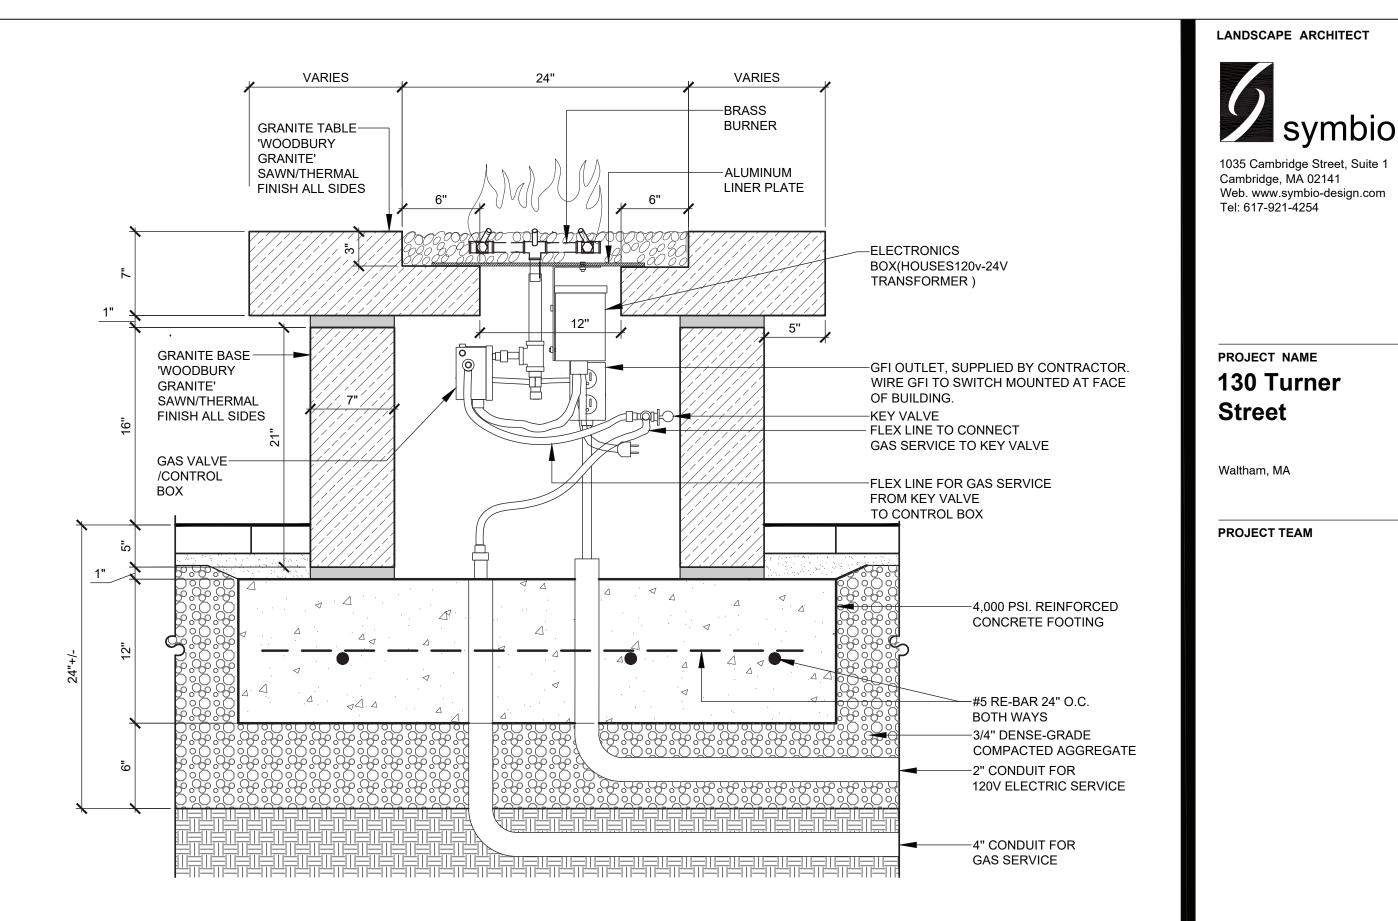

SCALE: 1-1/2"=1'-0"

Fire Table Section A

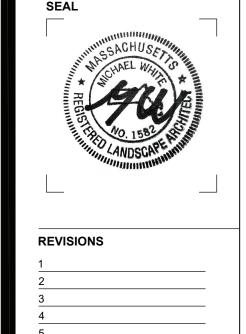

LANDSCAPE ARCHITECT

PROJECT NAME


Waltham, MA

**PROJECT TEAM** 

130 Turner

DRAWING TITLE



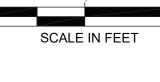

DRAWING NUMBER