City of Waltham Purchasing Department Waltham, Massachusetts 02452

ADDENDUM NO. 1

Plans & Specifications for: Elsie Turner Field & Graverson Playground, Waltham, MA

In accordance with documents prepared by: Carolyn Cooney & Associates

TO: ALL PLAN HOLDERS

This Addendum No. 1 is to modify, correct and/or supplement the Plans and Specifications.

Bidders are hereby informed that Plans and Specifications for the above-mentioned project are modified, corrected and/or supplemented as follows and that Addendum No. 1 becomes a part of the Contract Documents. Addendum No. 1 consists of Changes described in Items 1 through 27 and attached Drawings and Specification Sections.

Addendum 1 must be acknowledged as received in Section 00310 - Form for General Bid THE FOLLOWING REVISIONS ARE MADE A PART OF THIS CONTRACT

In accordance with documents prepared by: Carolyn Cooney & Associates

GRAVERSON PLAYGROUND

- **ITEM NO. 1** *Graverson Playground:* Revise Specifications Section 01020 Allowances as follows: Delete Paragraph 1.03 Allowance for Irrigation Booster Pump in its entirety.
- **ITEM NO. 2** *Graverson Playground:* Revise Specifications Section 02510 Bituminous Concrete Paving and Curbs as follows:

Section Title & Footers: Delete "& Curbs" 1.02 SCOPE OF WORK.B.1: Delete "& curbing".

- **ITEM NO. 3** Graverson Playground: Replace Specifications Section 02725, Drainage & Sewer Pipe. with attached revised Section. Revision adds specifications for Ductile Iron Pipe and PVC surface drains.
- **ITEM NO. 4** *Graverson Playground:* Revise Specifications Section 02850 Athletic Equipment, as follows:

Add to Paragraph 2.01.A.

"Local distributor: New England Recreation Group, 1-800-861-1209."

- **ITEM NO. 5** *Graverson Playground:* Replace Drawing L.102A with attached new Drawing L.102A. Revision is to the Limit of Work Line.
- **ITEM NO. 6** Graverson Playground: Replace Drawing L.102 with new Drawing L.102 attached. Revision is to clarify that two player's benches and footings are to be demolished.
- **ITEM NO. 7** *Graverson Playground:* Replace Drawing L.613 with new Drawing L.613 attached. Revision is to size of backboard.
- **ITEM NO. 8** *Graverson Playground:* Replace Drawing L.625 with new Drawing L.625 attached. Revision is to Drain Basin Detail.

ELSIE TURNER FIELD

ITEM NO. 9 Revise Specification Section 16526, Exterior Athletic Lighting. Add the following Subparagraph to 1.01.A.:

"1. The Contractor shall obtain all required permits, and shall arrange for City Building Department and Wires Department inspectors to inspect installation prior to backfilling electrical trenches and foundations."

Revise Table 1.02 A, as follows:

Area of Lighting	Average Target Illumination Levels	Maximum to Minimum Uniformity Ratio	Grid Points	Grid Spacing
Softball Infield	50 Footcandles	2.0:1.0	25	20' X 20'
Softball Outfield	30 Footcandles	2.5:10	82	20' X 20'

Revise Table 1.02 B, as follows:

Area of Lighting	Annual Usage Hours	25 year Usage Hours
Softball	300	7500

Revise Table 1.03. B as follows:

	Average	Maximum
Property Line Maximum Vertical Footcandles	.04 fc	.4 fc
Property Line Horizontal Footcandles	.006 fc	.06 fc
Property Line Max Candela	3772.5 Cd	28850 Cd

Revise 2.01.C.4 to read "The Contractor shall supply all drivers and supporting electrical equipment.

Delete 2.01.C.4.b in its entirety.

Delete Paragraph 2.02.B. Energy Consumption, in its entirety.

Delete Paragraph 2.03.D Foundation Drawings, in its entirety.

Add Paragraph 2.04 C.1 thru 3 as follows:

- 1. Remote Lighting Control System: System shall allow Owner and users with a security code to schedule on/off system operation via a web site, phone, fax or email up to ten years in advance. Manufacturer shall provide and maintain a two-way TCP/IP communication link. Trained staff shall be available 24/7 to provide scheduling support and assist with reporting needs.
 - The Owner may assign various security levels to schedulers by function and/or fields. This function must be flexible to allow a range of privileges such as full scheduling capabilities for all fields to only having permission to execute "early off" commands by phone. Scheduling tool shall be capable of setting curfew

limits.

3. Controller shall accept and store 7-day schedules, be protected against memory loss during power outages, and shall reboot once power is regained and execute any commands that would have occured during the outage.

Add the following to 3.05 INSPECTIONS:

- "3.05.B. The Contractor shall arrange for an inspection by the Building Department prior to backfilling pole foundations."
- **ITEM NO. 10** *Elsie Turner Field*: Replace Specification Section 02728 Drainage Structures with new section attached.
- **ITEM NO. 11** *Elsie Turner Field*: Replace Coversheet with Coversheet attached. Revision is to add drawings L.609 Retaining Wall Elevation and L.625 Trench Drains/Leaching Basins, to the list of Contract Documents.
- **ITEM NO. 12** *Elsie Turner Field*: Replace Drawing L.101 with new Drawing L.101 attached. Revision is to clarify sawcutting requirement.
- **ITEM NO. 13** *Elsie Turner Field*: Replace Drawing L.102 with new Drawing L.102 attached. Revision is to clarify portions of stone walls to remain or to be demolished.
- ITEM NO. 14 Elsie Turner Field: Replace Drawings L.201 and L.202 with new Drawings L.201 and L.202 attached. Revision includes repositioning of shade shelters at softball field, reduction in the amount of protective fencing, revision to size and shape of exercise area, revision to bioretention area 2 and surrounding walkway layout. Addition of trench drains and leaching basins at softball field.
- **ITEM NO. 15** *Elsie Turner Field*: Replace Drawing L.301 and L.302 with new Drawings L.301 and L.302 attached.
- **ITEM NO. 16** *Elsie Turner Field:* Replace Drawings L.401 and L.402 with new Drawings L.401 and L.402. Revision is to field grading, parking lot grading, and height of wall at parking lot.
- **ITEM NO. 17** *Elsie Turner Field:* Replace Drawings L.501 and L.502 with new Drawings L.501 and L.502. Revision is to areas of sod and seed related to changes in plan at Softball field and Bioretention area No. 2.
- **ITEM NO. 18** *Elsie Turner Field*: Replace Drawing L.602 with new Drawing L.602 attached. Revision is to dimensions of mow strip.
- **ITEM NO. 19** *Elsie Turner Field*: Replace Drawing L.605 with new Drawing L.605 attached. Revision is to Chain Link fence mow strip.
- **ITEM NO. 20** *Elsie Turner Field*: Replace Drawing L.606 with new Drawing L.606 attached. Revision is to mow strip at backstop.
- **ITEM NO. 21** *Elsie Turner Field*: Add new drawing L.609 attached. Revision is to height of retaining wall.
- **ITEM NO. 22** *Elsie Turner Field*: Replace Drawing L.612 with new Drawing L.612 attached. Revision is to exercise area equipment and layout.
- **ITEM NO. 23** *Elsie Turner Field*: Replace Drawing L.613 with new Drawing L.613 attached. Revision is to delete Back Extension.

- **ITEM NO. 24** *Elsie Turner Field*: Replace Drawing L.614 with new drawing L.614 attached. Revision is to delete a portion of chain link fencing at dugouts.
- **ITEM NO. 25** *Elsie Turner Field*: Add new drawing L.624, attached.
- **ITEM NO. 26** *Elsie Turner Field*: Replace Drawing ES.1A with new Drawing ES.1A attached. Revision is to number of light fixtures.
- **ITEM NO. 27** *Elsie Turner Field*: Replace Drawing ES.2 with new Drawing ES.2 attached. Revision is to number of light fixtures, and correction to Control Cabinet Detail connections.

Attachments:

Graverson Specifications Section 02725

Elsie Turner Specifications Section 02728

Graverson L.102A

Garverson L. 102

Graverson L.613

Graverson L.625

Elsie Turner Coversheet

Elsie Turner L.101-L.102

Elsie Turner L.201-L.202

Elsie Turner L.301-L.302

Elsie Turner L.401-L.402

Elsie Turner L.501-L.502

Elsie Turner L.602

Elsie Turner L.605

Elsie Turner L.606

Elsie Turner L.609

Elsie Turner L.612

Elsie Turner L.613

Elsie Turner L.614

Elsie Turner L.624

Elsie Turner ES.1A

Elsie Turner ES.2

SECTION 02725

DRAINAGE AND SEWER PIPE

PART I - GENERAL

1.01 GENERAL PROVISIONS

- A. All of the Contract Documents, including the Contract Form, General Provisions, General Conditions, Supplemental Conditions, and all Attachments to the General Provisions, and Division 1 General Requirements, apply to the work of this Section.
- B. Examine and coordinate all Contract Drawings and other sections of the specifications for requirements which affect work of this section whether or not such work is specifically mentioned in this section. Coordinate work with other trades to assure the steady progress of all work under the Contract. The Contractor shall refer to the Contract Documents for all new work and coordinate how it relates to the installation of drainage and sewer pipe.

1.02 SCOPE OF WORK

- A. Under this Section the Contractor shall furnish all materials, equipment, labor, transportation, facilities and all operations and adjustments required for the installation of drainage and/or sewer pipe and all incidentals thereto.
- B. Drainage and sewer pipe shall be placed in the sizes and lengths indicated on the plans. Gate valves shall be placed along the drain and sewer pipes at locations as shown on the plans.
- C. Provide all coordination and pay all fees associated with installation of the sewer connection.

1.03 RELATED WORK

- A. Section 01050 Field Engineering.
- B. Section 01700 Project Closeout.
- C. Section 02100 Site Preparation and Demolition.
- D. Section 02200 Earthwork.
- E. Section 02622 Field Drainage System.
- F. Section 02728 Drainage Structures.

1.04 REFERENCES

- A. The following standards and definitions are applicable to the work of this Section to the extent referenced herein:
 - 1. ASTM A74 Cast Iron Soil Pipe and Fittings.
 - 2. ASTM C76 Reinforced Concrete Culvert, Storm Drain, and Sewer

Pipe

- 3. ASTM C443 Joints for Circular Concrete Sewer and Culvert Pipe, using Rubber Gaskets.
- 4. STM D1557 Test Methods for Moisture-Density Relations of Soils and Soil-Aggregate Mixtures using 10 lb. (4.54 kg) Rammer and 18 inch (457 mm) Drop.
- 5. ASTM D2729 Poly(Vinyl Chloride) (PVC) Sewer Pipe and Fittings.
- 6. ASTM D1248 HDPE(High Density Polyethylene)(HDPE) Pipe and Fittings.
- 7. ASTM F2648 Test Methods for Non-Pressure (gravity flow) polyethylene (PE) pipes and fittings.

1.05 SHOP DRAWINGS/MANUFACTURER'S CUTS AND SPECIFICATIONS

- A. The Contractor shall submit to the Landscape Architect for approval six (6) copies of all materials and equipment proposed for use indicating manufacturers' names and addresses, identifying data and expected delivery dates. No consideration will be given to partial lists submitted from time to time. Intention of using specified materials and equipment shall not relieve the Contractor from submitting the above list, nor shall submission of the list relieve him from submission of shop drawings. Any item of material or of equipment not submitted for approval on the list will not be approved unless of the exact make and characteristics specified.
- B. If the material or equipment is installed before it is approved, the Contractor shall be liable for the removal and replacement at no extra charge to the Owner, if, in the opinion of the Landscape Architect, the material or equipment does not meet the intent of the Contract Documents.
- C. The Contractor shall submit the following information with all equipment shop drawings:
 - 1. Manufacturer's certified scale drawings, cuts or catalogs, including installation details.
 - 2. Manufacturer's specifications, including certified performance characteristics and capacity ratings.
- D. Product Data: The Contractor shall provide data indicating pipe and pipe accessories, connections, etc.

1.06 SAMPLES

- A. The Contractor shall submit all samples as requested in accordance with the provisions of the General Conditions. Samples accepted will be returned to the Contractor within five (5) days and may be incorporated into the work. Samples not accepted will be returned for disposition by the Contractor.
- B. One (1) square foot of filter fabric.
- 1.07 CODES, ORDINANCES AND PERMITS

- A. All work shall be performed in strict accordance with local and state codes and regulations including OSHA Construction Regulations Title 29 CFR Part 1926.
- B. Site utilities work shall be done in strict accordance with the Commonwealth of Massachusetts State Plumbing Code, latest edition, and all revisions thereto, and City of Waltham Engineering Department and Department of Public Works standards.
- C. Any material or workmanship called for in the above-mentioned requirements, which are not specified or shown on the drawings, shall be furnished and installed by the Contractor as though same has been specifically mentioned or indicated. If the drawings and specifications are at variance with any regulations, the bidder shall notify the Landscape Architect ten (10) days before the date for submitting his bid. In many cases the drawings are in excess of the requirements in the codes and these shall be followed to the fullest. If the Contractor fails to notify the Landscape Architect at this time and installs work in variance with the above-mentioned codes and regulations, he shall assume the responsibility and the expense to rectify the installation.
- D. Before commencing work, the Contractor shall obtain all permits necessary in connection with the installation of this equipment and pay fees required for same. He shall include the cost and back charge of installing any portion of the work where performed by municipal departments or utility companies.

1.08 SUBSTITUTIONS

A. Any reference to a particular device, product, material, article or system shall be interpreted as establishing a standard of quality, design, performance, or function, and shall not be construed as limiting competition.

1.09 RECORD DRAWINGS

A. The Contractor shall submit record drawings as specified in Section 01700 - Project Closeout.

1.10 SITE VISITATION

A. It is recommended that all prospective bidders visit the job site to acquaint themselves with the general and special conditions that may be encountered which will have a bearing on labor, transportation, cutting and patching, material handling and storage, and similar items, during the prosecution of the work. Failure to do so shall not relieve him of his responsibility for properly estimating the difficulties involved in the work to be performed under this section.

1.11 REFERENCE STANDARDS

A. References herein to any technical society, organization, group or body is made in accordance with the following abbreviations.

- B. ASTM American Society for Testing Materials.
- C. AASHTO American Association of State Highway and Transportation Officials.
- D. AWWA American Water Works Association.
- E. ANSI American National Standards Institute.
- F. MHD Standard Specifications: The Commonwealth of Massachusetts Highway Department, Standard Specifications for Highways and Bridges, 1988.
- G. Requirements of the City of Waltham Engineering Department and Department of Public Works.

1.12 MATERIALS AND WORKMANSHIP

- A. It is the intent of these specifications to establish quality standards for all material and equipment incorporated in the work of this section. All material and equipment installed hereunder shall be new and shall be the best of each respective kind and type. Proper care shall be exercised in handling all equipment and materials herein specified.
- B. The installation shall be as indicated on the drawings and in accordance with the manufacturer's recommendations as approved by the Landscape Architect. The installation shall be accomplished by workmen skilled in this type of work.
- C. All conduits, pipes, structures, etc. in use and which are damaged during excavation, whether uncovered or not and whether or not they are shown on the plans, shall be repaired at the expense of the Contractor.
- D. Storage of materials by the Contractor for incorporation into the work shall be off the site for other than material that is scheduled to be installed in the time span of two (2) working days. The storage site selected by the Contractor shall be made accessible to the City inspection forces at all times during normal working hours.

PART 2 - MATERIALS

2.01 GENERAL

A. Drawings and specifications are intended to supplement and explain each other.

Materials not specifically mentioned in the specifications shall be as indicated on the drawings. Where conflicts occur between the drawings or specifications, or within either document itself, the item or arrangement of better quality, greater quantity or higher cost shall be included in the Contractor's bid. Where no specific kind or quality of material is given, a first-class standard article, shall be furnished.

2.02 DRAINAGE AND SEWER PIPE

- A. PVC Pipe for use as storm drainage and sewer lines shall contain integrally belled and spigot type rubber gasketed joints conforming to ASTM 3034. Gaskets shall conform to ASTM F-477 and shall be marked to indicate nominal pipe size and proper insertion direction. The standard dimension ratio (SDR) of all pipe and fittings shall not exceed 35. Standard pipe lengths shall be twenty (20) feet unless otherwise approved. All necessary glues, gaskets and fittings shall be furnished in order to make the work complete and acceptable to the Engineer.
- B. HDPE Pipe shall be ADS N–12 high density polyethylene pipe (HDPE) as manufactured by Advanced Drainage Systems (ADS), or approved equal, and shall conform to the requirements of AASHTO M-294, and ASTM F2648.
 - 1. HDPE pipe shall be smooth wall perforated where indicated.
 - Pipe and fittings shall be made of polyethylene compounds which conform to the physical requirements of Type III, Category 3, 4 or 5, P23, P33, or P34, Class C per ASTM D-1248 with the applicable requirements defined in ASTM D-1248. Clean reworked material may be used.
 - 3. Pipe shall be of the diameters shown on the Drawings.
- C. HDPE Fittings shall conform to:
 - 1. Fittings shall conform to ASTM F 2306. Bell and spigot connections shall utilize a spun-on or welded bell and valley or saddle gasket meeting the watertight performance of requirements of ASTM F 2306.
 - 2. Couplers and pipe shall be from the same manufacturer.
 - 3. Couplers shall be corrugated to match the pipe corrugations and the width shall not be less than one-half the nominal diameter of the pipe. Split couplers shall be manufactured to engage an equal number of corrugations on each side of the pipe joint.
 - 4. One half inch diameter galvanized steel bolts and nuts or nylon ties as supplied by manufacturer shall be used on coupling bands.
- D. Furnish pipe in the sizes indicated on the plans and/or details.
- E. DUCTILE IRON PIPE (DIP)
 - 1. Ductile iron pipes shall be designed in accordance with AWWA C150 and shall be manufactured in accordance with AWWA C151.
 - 2. Unless otherwise indicated or specified, ductile iron pipe shall be Thickness Class 52.
 - 3. All pipe delivered to the job site shall be accompanied by independent testing laboratory reports certifying that the pipe and fittings conform to the above mentioned specifications. In addition, the pipe shall be subject to thorough

inspection and tests, the right being reserved for the Engineer to apply such of the tests specified, as he may from time to time deem necessary.

4. All cutting of pipe shall be done with a machine suitable for cutting DI pipe. Cut ends shall be beveled when recommended by the pipe manufacturer.

F. PVC SURFACE DRAINAGE INLETS AND BASINS

- 1. PVC surface drainage inlets and drain basins shall be the type as indicated on the drawings and shall be as manufactured by Nyloplast (770-932-2443) or equal, conforming to the following:
 - Drains and basins shall be manufactured from PVC pipe stock, utilizing a thermo-molding process to reform the pipe stock to the furnished configuration.
 - b. Drainage pipe connection stubs shall be manufactured from PVC pipe stock and formed to provide watertight connections with the specified pipe system.
 - 1) Joint tightness shall conform to ASTM D3212 for joints for drain and sewer plastic pipe using flexible elastomeric seals.
 - 2) The material used to manufacture the pipe stock shall conform to ASTM D1784 cell class 12454.
 - c. Grates shall be ductile iron grates and shall be made specifically for each fitting so as to provide a round bottom flange that closely matches the diameter of the surface drainage inlet.
 - 1) Grates shall be capable of supporting H-20 wheel loading.
 - 2) Grates shall be ADA compliant.
 - 3) Metal for manufacture of castings shall conform to ASTM A536 Grade 70-50-05 for ductile iron.
 - 4) Grates shall be provided painted black.
 - d. Provide concrete ring under and around grate and frame.

2.03 FILTER FABRIC

A. SUPAC 8NP by Phillips Fibers Corporation, AMOCO 4508, Trevira 1125, Mirafi 180N, or equal.

2.04 BEDDING AND COVER MATERIALS

A. Crushed Stone Bedding: Crushed stone as specified in Section 02200 - Earthwork.

B. Cover: Gravel as specified in Section 02200 - Earthwork.

2.05 APPURTENANCES

A. Provide all appurtenance and incidentals necessary to make the sewer and drainage pipe installation and connection complete and acceptable, including all materials necessary for the excavation, backfill, and compaction.

PART 3 - EXECUTION

3.01 PIPE INSTALLATION

- A. Layout out utilities as required in Section 01050 Field Engineering. Prior to excavating trenches the Contractor shall field verify all existing inverts and inform the Landscape Architect of any discrepancies. Record these inverts on Record Drawings.
- B. The trench for the pipe shall be excavated to the required line and grade and be of sufficient width to permit thorough tamping of the fill material under the haunches and around the pipe. Soft or unsuitable material encountered below the normal bedding line of the pipe shall be removed as directed, replaced with selected material, gravel or crushed stone and thoroughly compacted. The bottom of the trench shall be shaped to conform to the curvature of the pipe. This bed shall also be excavated to accommodate the bells of pipes.
- C. The pipe shall be laid true to the specified lines and grades where shown on the Plans and as directed. The bell end shall be toward rising grade and each section of pipe shall have a firm bearing throughout its length. Material placed around and under the pipe shall be free of stones larger than three (3) inches in diameter.
- D. No load greater than three (3) tons shall be moved over any pipe until a fully-compacted backfill of at least two (2) feet has been placed over the top of the pipe. This minimum will be increased to three and one-half (3-1/2) feet for a forty thousand (40,000) pound single wheel load and to four (4) feet for a sixty thousand (60,000) pound single wheel load. However, compliance with these requirements is not to be construed as relieving the Contractor of any responsibility concerning damage to the pipe.
- E. Bedding material for pipes shall conform to the requirements of Section 02200 Earthwork and shall be placed between the pipe and the walls of the trench in layers not exceeding six (6) inches in depth and thoroughly compacted. Each layer, if dry, shall be moistened and then compacted by rolling or by tamping with mechanical rammers. Compaction with iron hand tampers having a tamping face not exceeding twenty-five (25) square inches in area may be allowed only after permission has been given by the Landscape Architect. Special care shall be taken to thoroughly compact the fill under the haunches of the pipe. This method of filling and compacting shall be continued until the material is level with the centerline of the pipe. The remainder of the filling shall consist of suitable backfill material, as defined in Section 02200 Earthwork, placed in successive layers not more than six (6) inches in depth. Each layer shall be thoroughly compacted in accordance with AASHTO-T99 Standard Proctor Test.

3.02 DRAINAGE AND SEWER PIPE

A. Any pipe showing settlement after laying or which is not in true alignment or is otherwise unsatisfactory before final acceptance of the work shall be taken up and replaced or relayed by the Contractor without additional compensation..

3.03 WATER REMOVAL

A. If water is encountered during construction, provisions must be made to remove the water by sheeting and pumping as required, or laying the pipe with a crushed stone bed so that the laying of pipe and other work can be done under stable conditions, all in accordance with Section 2.04 of these Specifications.

END OF SECTION

SECTION 02728

DRAINAGE STRUCTURES

PART 1 - GENERAL

1.01 GENERAL PROVISIONS

- A. All of the Contract Documents, including the Contract Form, General Provisions, General Conditions, Supplemental Conditions, and all Attachments to the General Provisions, and Division 1 General Requirements, apply to the work of this Section.
- B. Specifications for requirements which affect work of this section whether or not such work is specifically mentioned in this section. Coordinate work with other trades to assure the steady progress of all work under the Contract. The Contractor shall refer to the Contract Documents for all new work and coordinate how it relates to the installation of drainage and sewer pipe.

1.02 SCOPE OF WORK

A. The work to be done under this Section shall include the furnishing and installation of a drainage system consisting of catchbasins, trench drains, and leaching basins. The Contractor shall provide all material, labor, tools, equipment and transportation to complete these items.

1.03 RELATED WORK

- A. Section 02100 Site Preparation and Demolition.
- B. Section 02200 Earthwork.
- C. Section 02725 Drainage Pipe.
- D. Section 03300 Cast-in-Place Concrete.

1.04 REFERENCE STANDARDS AND SPECIFICATIONS

- A. Reference to the standards, specifications and tests of technical societies, organizations and governmental bodies is made in the Contract Documents.
- B. AASHTO American Association of State Highway and Transportation Officials (tests or specifications).
- C. ASTM American Society for Testing and Materials.
- D. MHD Standard Specifications: Mass. Standard Specs. Standard Specifications for Highways, Bridges and Waterways, 1988 Edition, the Commonwealth of Massachusetts, Department of Public Works.
- E. Commonwealth of Massachusetts, Department of Public Works, Construction Standards, 1977.

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- F. Municipal Standard Specifications and Procedures, as applicable.
- G. OSHA Construction Regulations Title 29 CFR Part 1926.
- H. Americans with Disabilities Act Accessibility Guidelines (ADAAG).

1.05 CODES, ORDINANCES AND PERMITS

- A. All work shall be performed in strict accordance with local and state codes and regulations.
- B. Site utilities work shall be done in strict accordance with the Commonwealth of Massachusetts State Plumbing Code, dated September 1976, and all revisions thereto.
- C. The Contractor shall secure all permits deemed necessary in connection with the installation of this equipment and pay fees required for same. He shall include the cost and back-charge of installing any portion of the work where performed by municipal departments or utility companies.

1.06 SUBMITTALS / SHOP DRAWINGS

- A. Shop drawings shall be submitted to the Engineer for all equipment. Six (6) copies shall be submitted and shall include cuts, scale drawings, installation details, manufacturer's specifications, certified performance characteristics and capacity ratings.
- B. No material or equipment may be purchased or installed prior to the submission and written approval of the shop drawings.
- C. Product Data: Provide data indicating, catch basins, frames and grates, etc.
- D. One (1) square foot of filter fabric.

PART 2 - MATERIALS

2.01 CEMENT CONCRETE

A. Material shall comply with Section 03300 of these Specifications.

2.02 PRECAST CONCRETE DRAINAGE STRUCTURES

- A. All precast concrete units shall conform to Section M4.02.14 of the Standard Specifications in all aspects, and to the City of Waltham Standard Details for Drainage Structures as applicable.
- B. Refer to the Details in the Contract Drawings.

2.03 CASTINGS

- A. Iron castings for Catch Basins & Manholes (frames, grates and covers) shall conform to Mass Highway Construction Manual standard designs and to the requirements of AASHTO Designation M105, Class No. 30, Gray Iron Castings, unless otherwise specified. Test Bar B, 1.20 inches in diameter.
 - 1. Catch basin frame and grate casting(s) shall be 24" round grate conforming to ADA requirements.
 - Manhole Frames and Covers: Cover shall be of minimum weight of 150 pounds, HD20 loading, solid cover, with a pick-hole, with water tight top flange complying with the requirements of the City of Waltham Engineering Department.

2.04 FILTER FABRIC

A. SUPAC 8NP by Phillips Fibers Corporation, AMOCO 4508, Trevira 1125, Mirafi 180N, or equal

2.05 TRENCH DRAINS & TRENCH DRAIN PIPING AT SOFTBALL FIELD

- A. Trench drains shall be Polydrain units as manufactured by ABT, or equal, conforming to the following:
 - 1. Drains shall be radiused, presloped at approximately 0.06% slope. Units shall be interlocking with anchoring ribs.
 - 2. Drain units shall be polyester polymer concrete with a compressive strength of 17,000 psi minimum, bending strength of 4,000 psi minimum, and tensile strength of 2,000 psi minimum. Moisture absorption shall be 0.2% maximum, with freeze/thaw without weight loss of 1,600 number of cycles minimum.
 - 3. Drain units shall have inside top width of 4" and exterior width of 6" nominal.
 - 4. Drain units shall have in-line catch basins. Catch basins shall be provided with removable stainless steel trash buckets.
 - 5. Frame & grate shall be epoxy coated ductile iron conforming to ASTM A-536 with a minimum open area of 0.21 square feet per lineal foot.
 - 6. Grates shall be removable with an anti-vandal locking device.
 - 7. Grates shall be ADA compliant and heel-proof.

2.06 TRENCH DRAIN AT ENTRY DRIVE

A. Trench drain at entry drive shall be as indicated on the Drawings.

2.07 LEACHING BASINS


A. Leaching Basins shall be as indicated on the Drawings.

PART 3 - EXECUTION

- 3.01 Structures of various types and depths shall be constructed to the line and grades, dimensions and design shown on the plans and as directed with the necessary frames, gratings, covers, aluminum steps, etc., and in accordance with these Specifications after verification of inverts of utilities to remain.
- 3.02 The bricks and blocks (if required) shall be wetted as necessary before laying. All joints in brick masonry shall be thoroughly flushed full of mortar and no joints on the inside face shall be greater than one-quarter (1/4) inch. After the bricks and blocks are laid up, the outside of the structure shall be plastered with one-half (½) inch thick mortar coat.
- 3.03 Connections will be carefully made to all existing and proposed lines to the grades and elevations shown on the contract drawing.
- 3.04 All catch basins shall have a cast iron hinged metal hood trap installed over the outlet pipe or an oil trap outlet as detailed in the drawings. Use twelve (12) inch hoods, unless sizes equal to the specified pipe sizes are available.
- 3.05 Unless otherwise directed or specified, two (2) weep holes shall be built into the walls of all new structures. Each weep hole shall consist of a section of four (4) inch pipe or equivalent opening to carry water through the wall of the structure. The outside end of the pipe or opening shall be covered with a one-quarter (1/4) inch mesh galvanized wire screen 23 gauge satisfactorily fastened against the wall. The drain to the weep hole shall be excavated and back-filled with two (2) cubic feet of broken rock or crushed stone. The crushed stone shall be placed against and over the end of the pipe or opening with a section of filter cloth to prevent the entrance of fine material. Only one (1) type of weep hole shall be used consistently throughout the project.
- 3.06 Suitable materials obtained from the excavation or from borrow shall be placed between the outside of the structure and the limits of the excavation, uniformly distributed in successive layers not exceeding six (6) inches in depth and thoroughly compacted by tamping with mechanical rammers or tampers. When required, the backfill material shall be moistened during the compacting. Compaction with iron hand tampers having a tamping face not exceeding twenty-five (25) square inches may be allowed, but only after permission has been given by the Engineer.
- 3.07 All materials removed in the excavation for catch basins, manholes, or storm water recharge units and remaining after the filling about the finished structure has been made shall be used wherever possible within the project or removed and satisfactorily disposed of outside of the project limits without additional compensation.
- 3.08 The embedded ends of the aluminum ladder steps shall be painted with zinc chromate or bitumastic, and allowed to completely dry before they are installed. Installation shall be as shown on the plans.

- 3.09 Frame castings for structures shall be set in full mortar beds true to the lines and grades as directed.
- 3.10 Where directed, the castings shall be temporarily set at such grades as to provide drainage during the construction.
- 3.11 In general, all methods for installation of the catch basin and manhole units, brick adjustments and mortaring, and installation of frames, grates and covers, shall conform to Section 201 of the "Standard Specifications".
- 3.12 Installation of Trench Drain:
 - A. Install per manufacturer's instructions and as indicated on the plans.

END OF SECTION

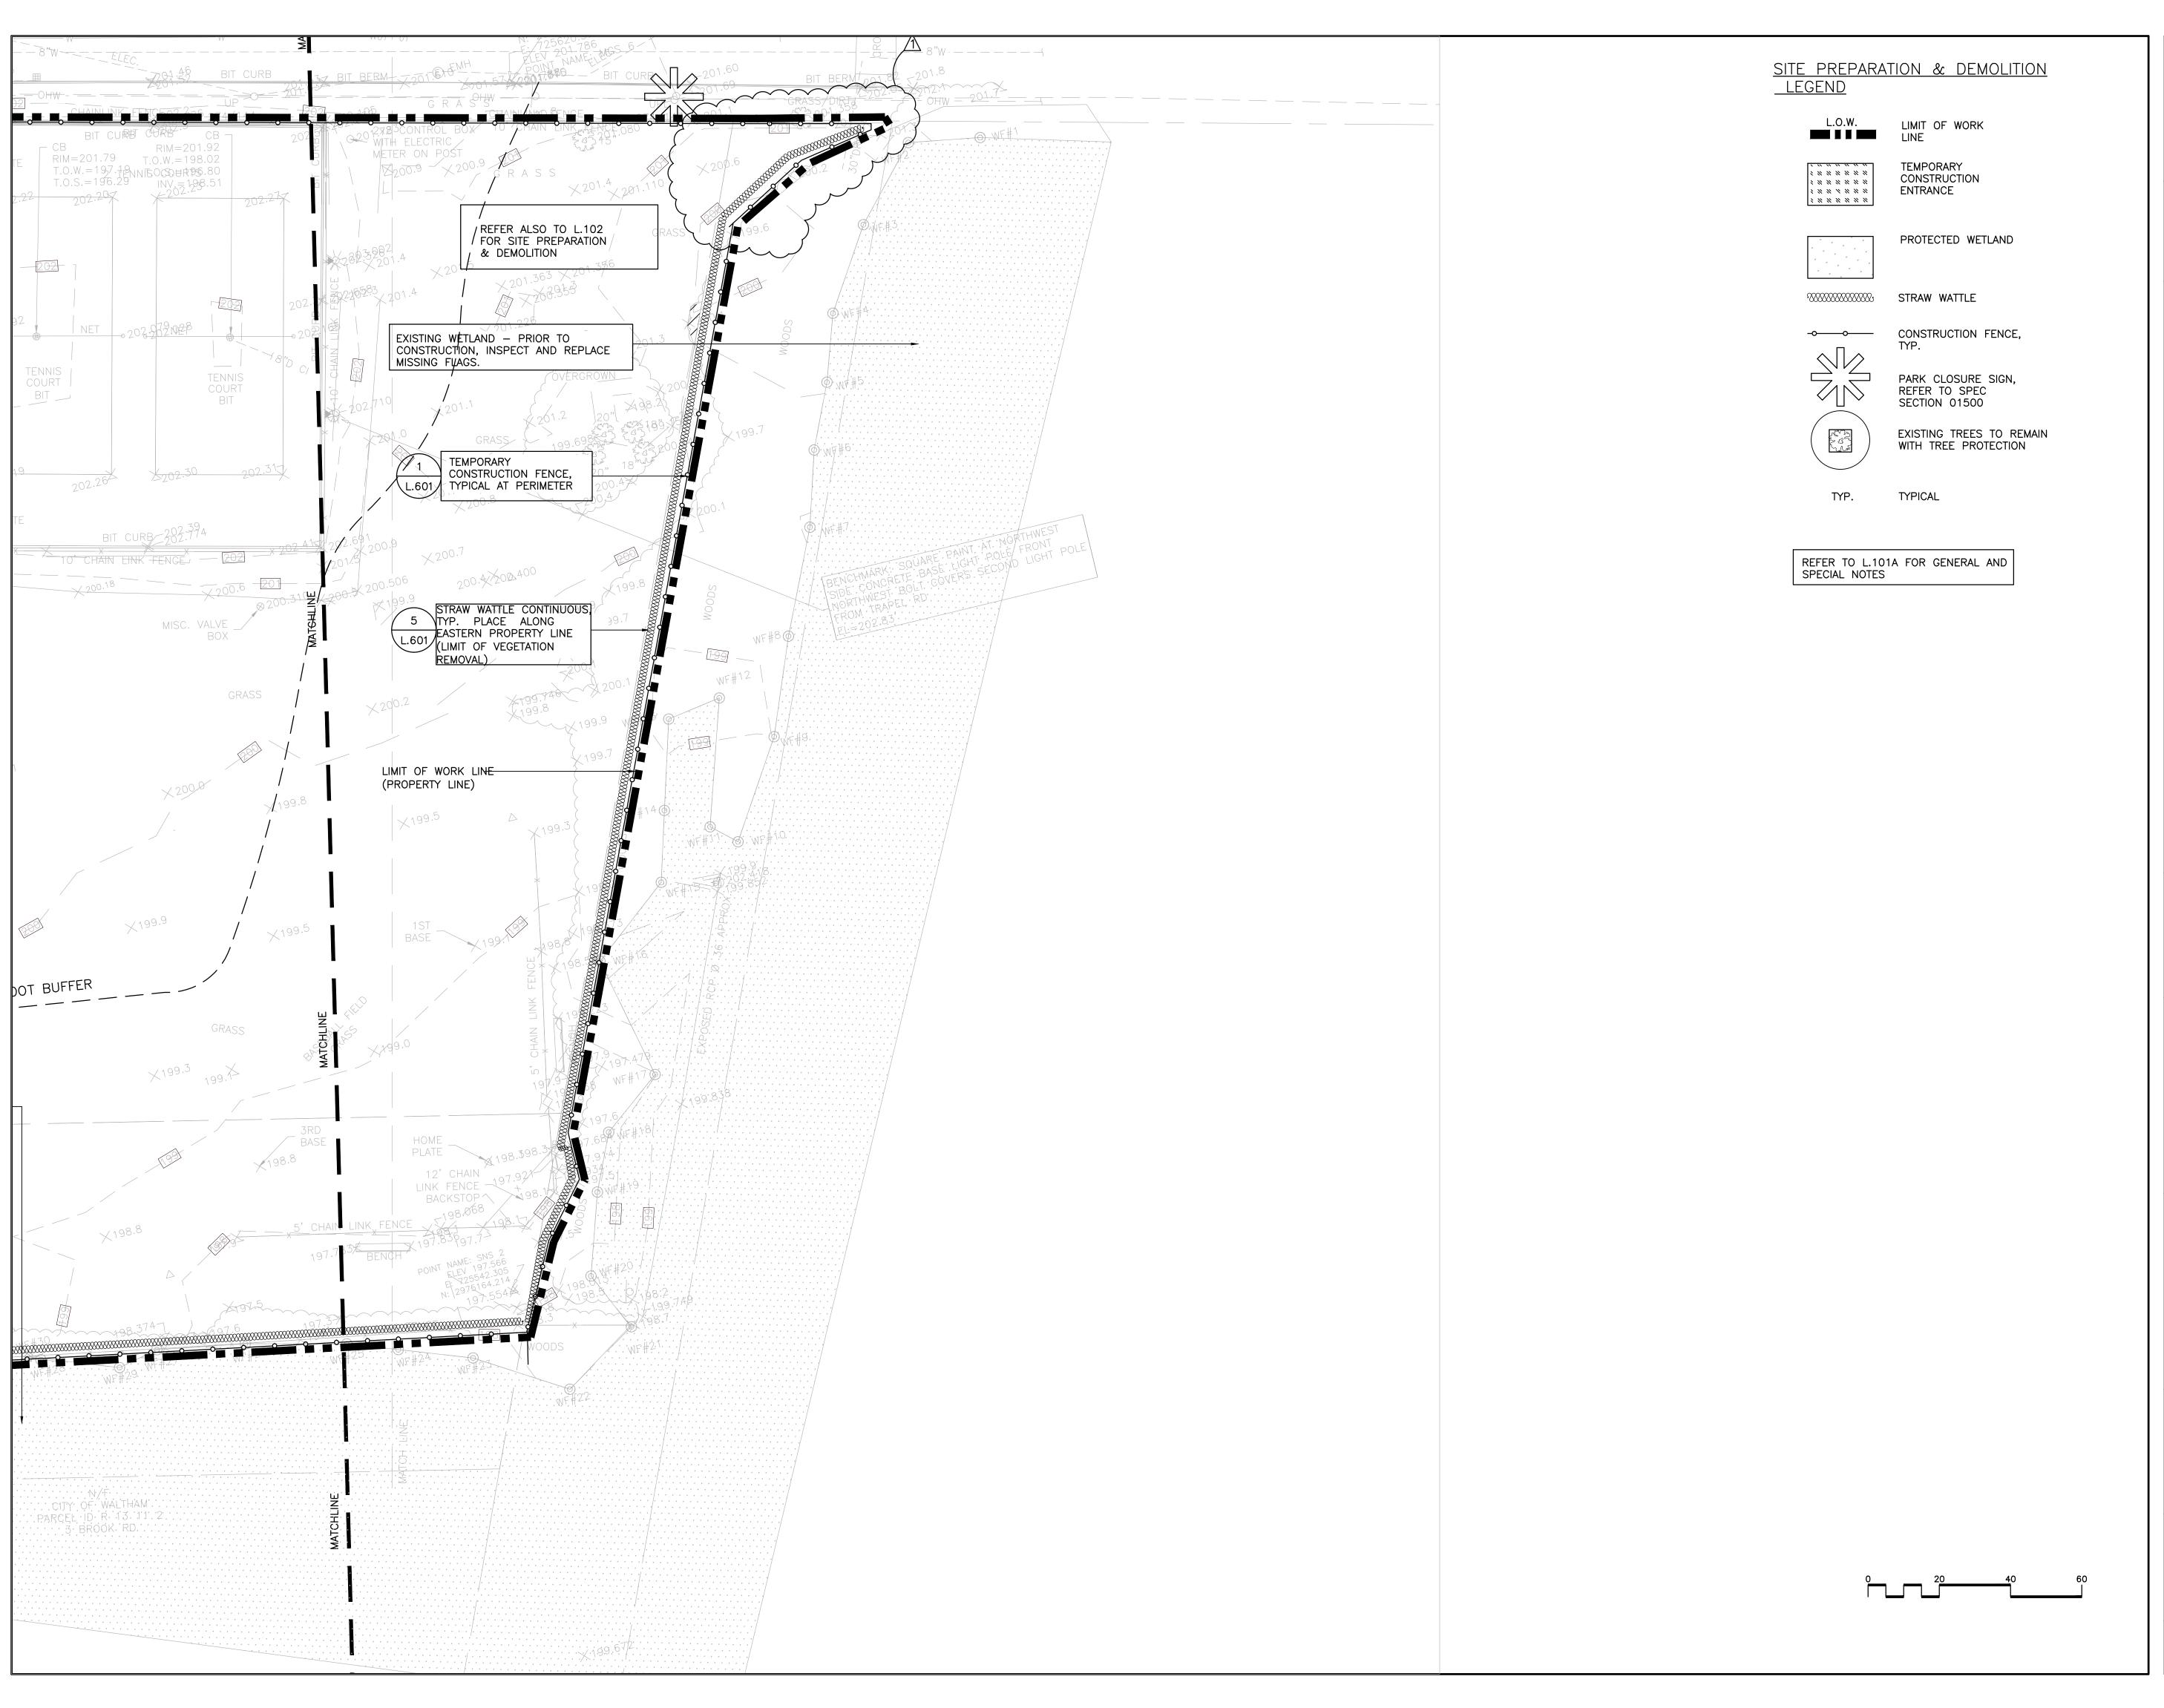

Landscape Architecture / Planning

13 Elm Street, Milford, MA 01757 Telephone 508 478 8426, Facsimile 508 478 8607




Site Engineering Consultants, Inc. 55 Grape Shot Road Sharon, Massachusetts 02067 TEL: (781) 784-0326 FAX: (781) 784-0492

CONSULTING CIVIL ENGINEERS



REVISED ADDENDUM #1 11/20/17

No. Description REVISIONS

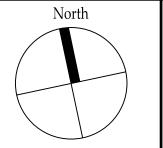

Project:

CITY OF WALTHAM CRAVERSON PLAYCROUND 16 PINE VALE ROAD WALTHAM, MA 02451


Prepared For:

CITY OF WALTHAM DEPARTMENT OF RECREATION 510 MOODY STREET WALTHAM, MA 02453

SITE PREPARATION & TEMPORARY CONTROLS

Date OCT 31, 2017 1"=20' Drawn By CCC Checked By DRB Approved By CCC Project No. 1710.00

L.102A

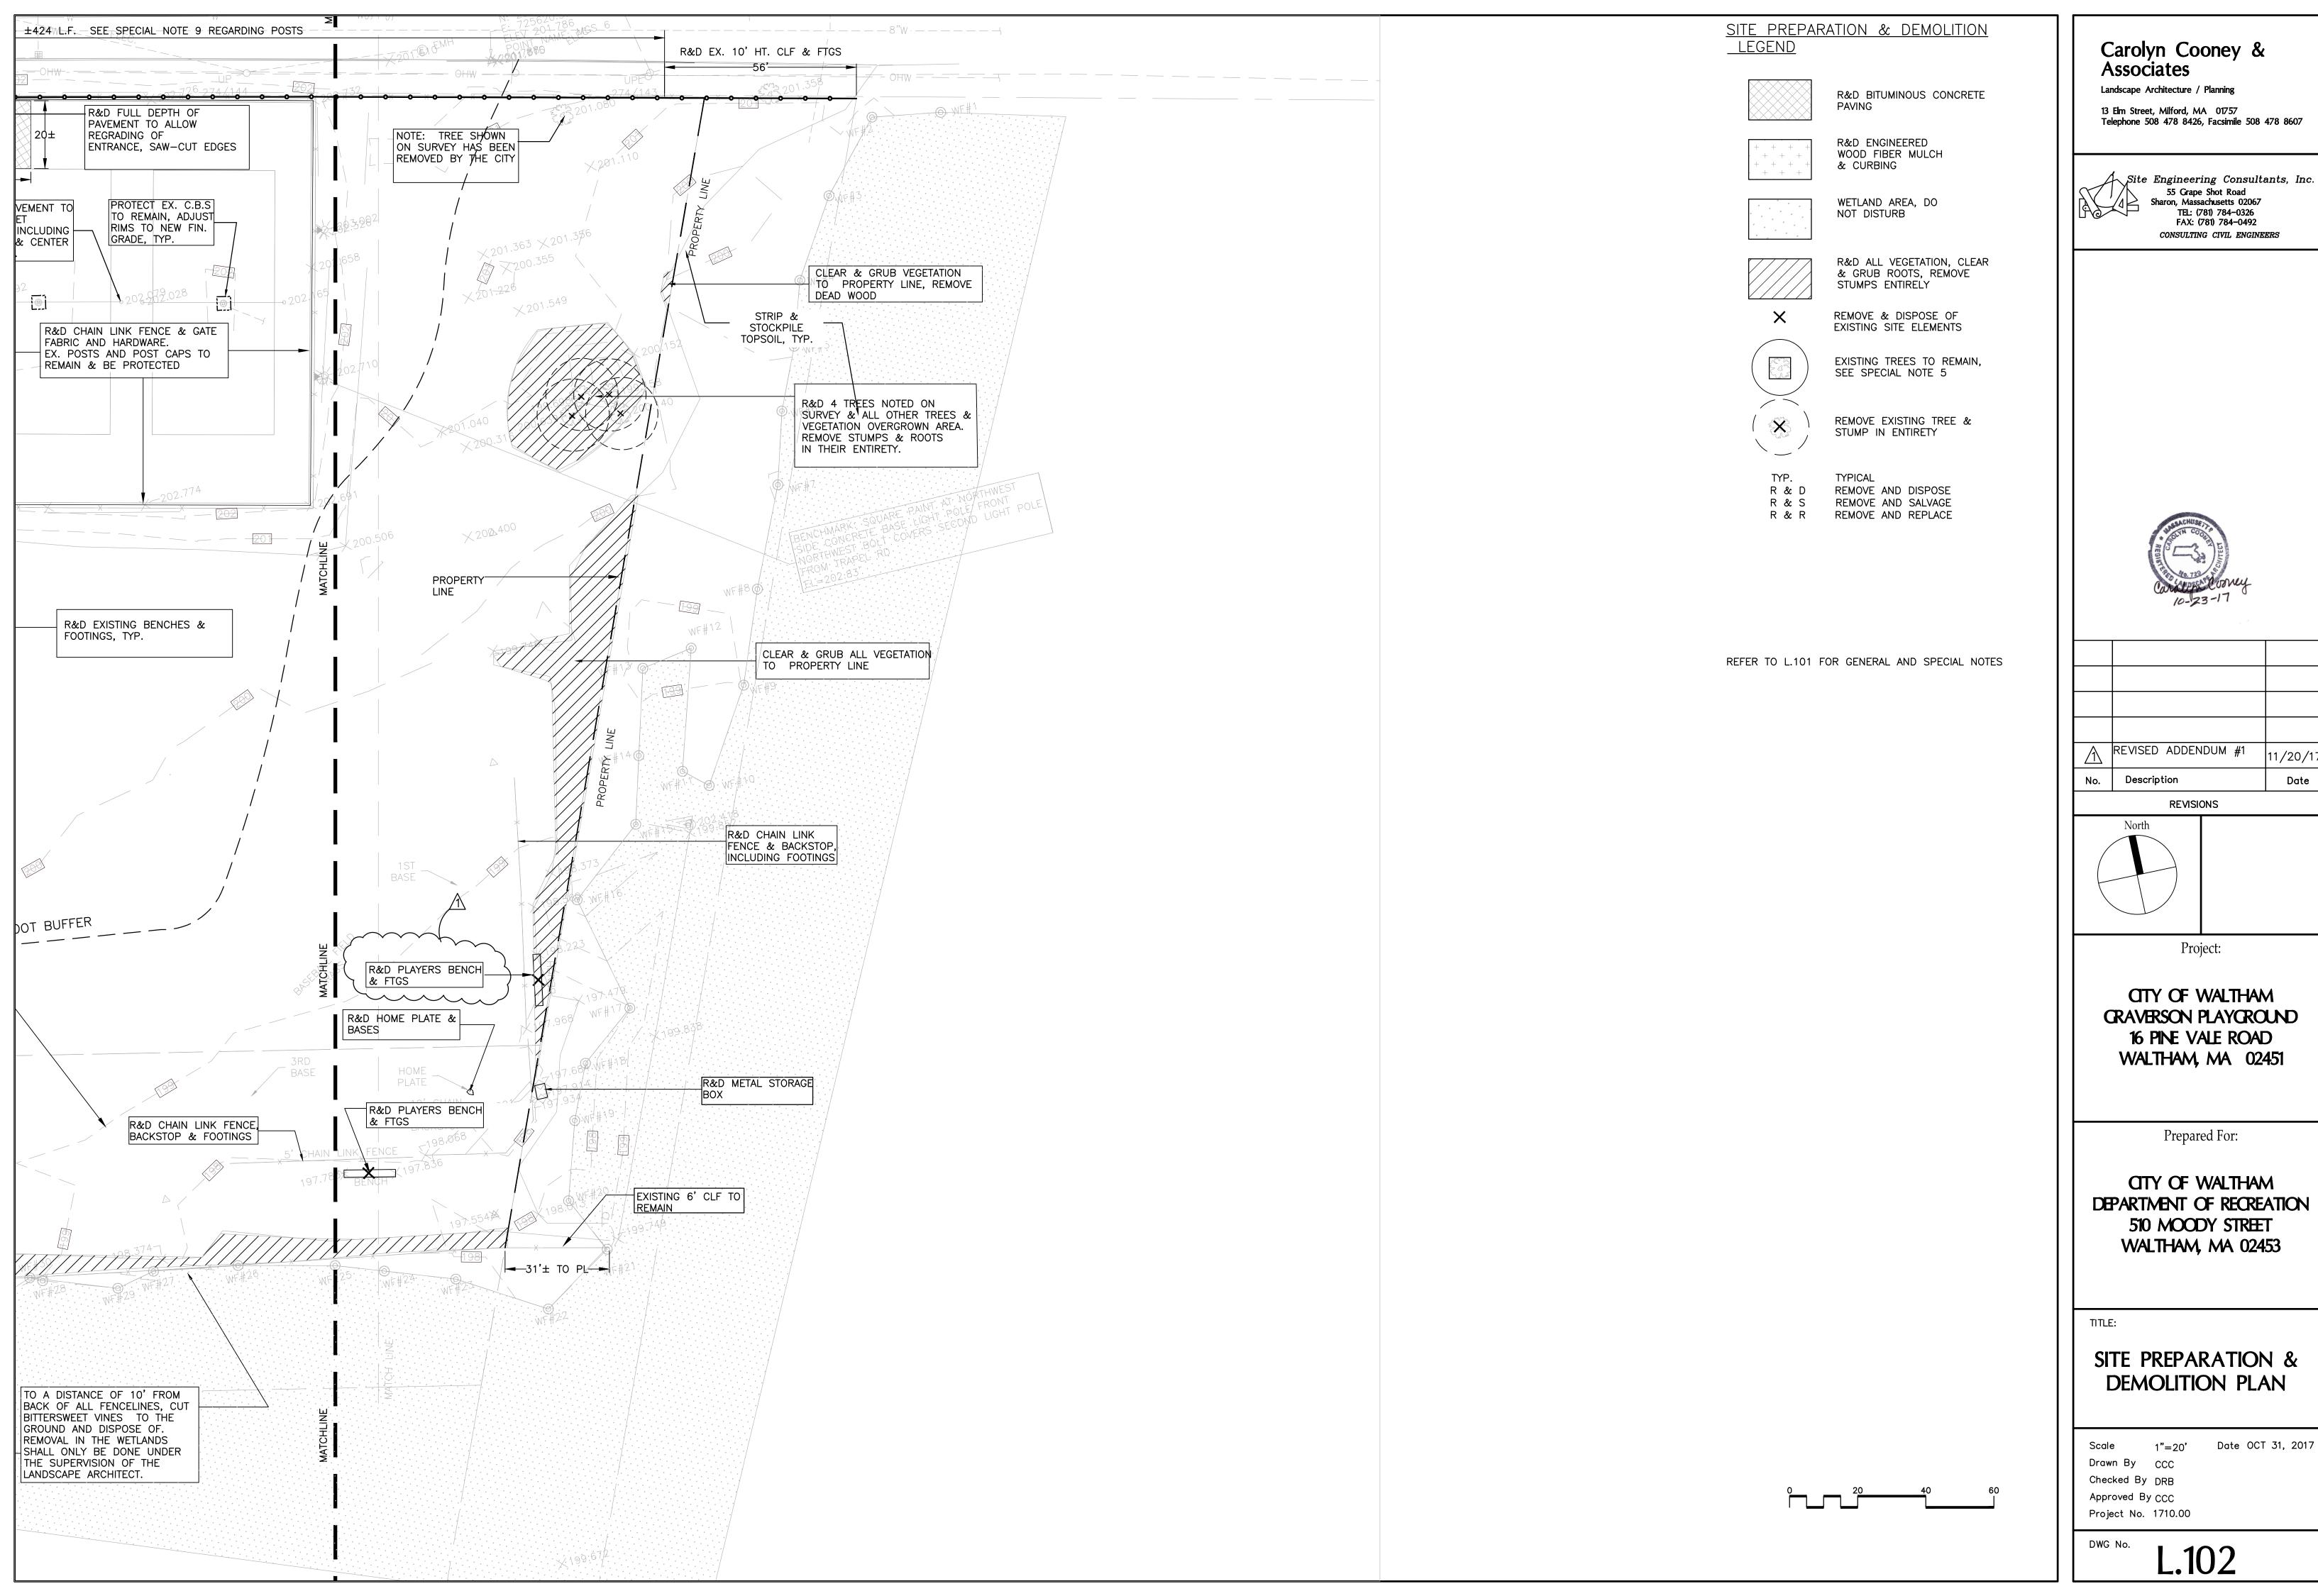

TEL: (781) 784-0326 FAX: (781) 784-0492




11/20/17

CITY OF WALTHAM CRAVERSON PLAYCROUND 16 PINE VALE ROAD WALTHAM, MA 02451

DEPARTMENT OF RECREATION 510 MOODY STREET WALTHAM, MA 02453

SITE PREPARATION & DEMOLITION PLAN

Date OCT 31, 2017

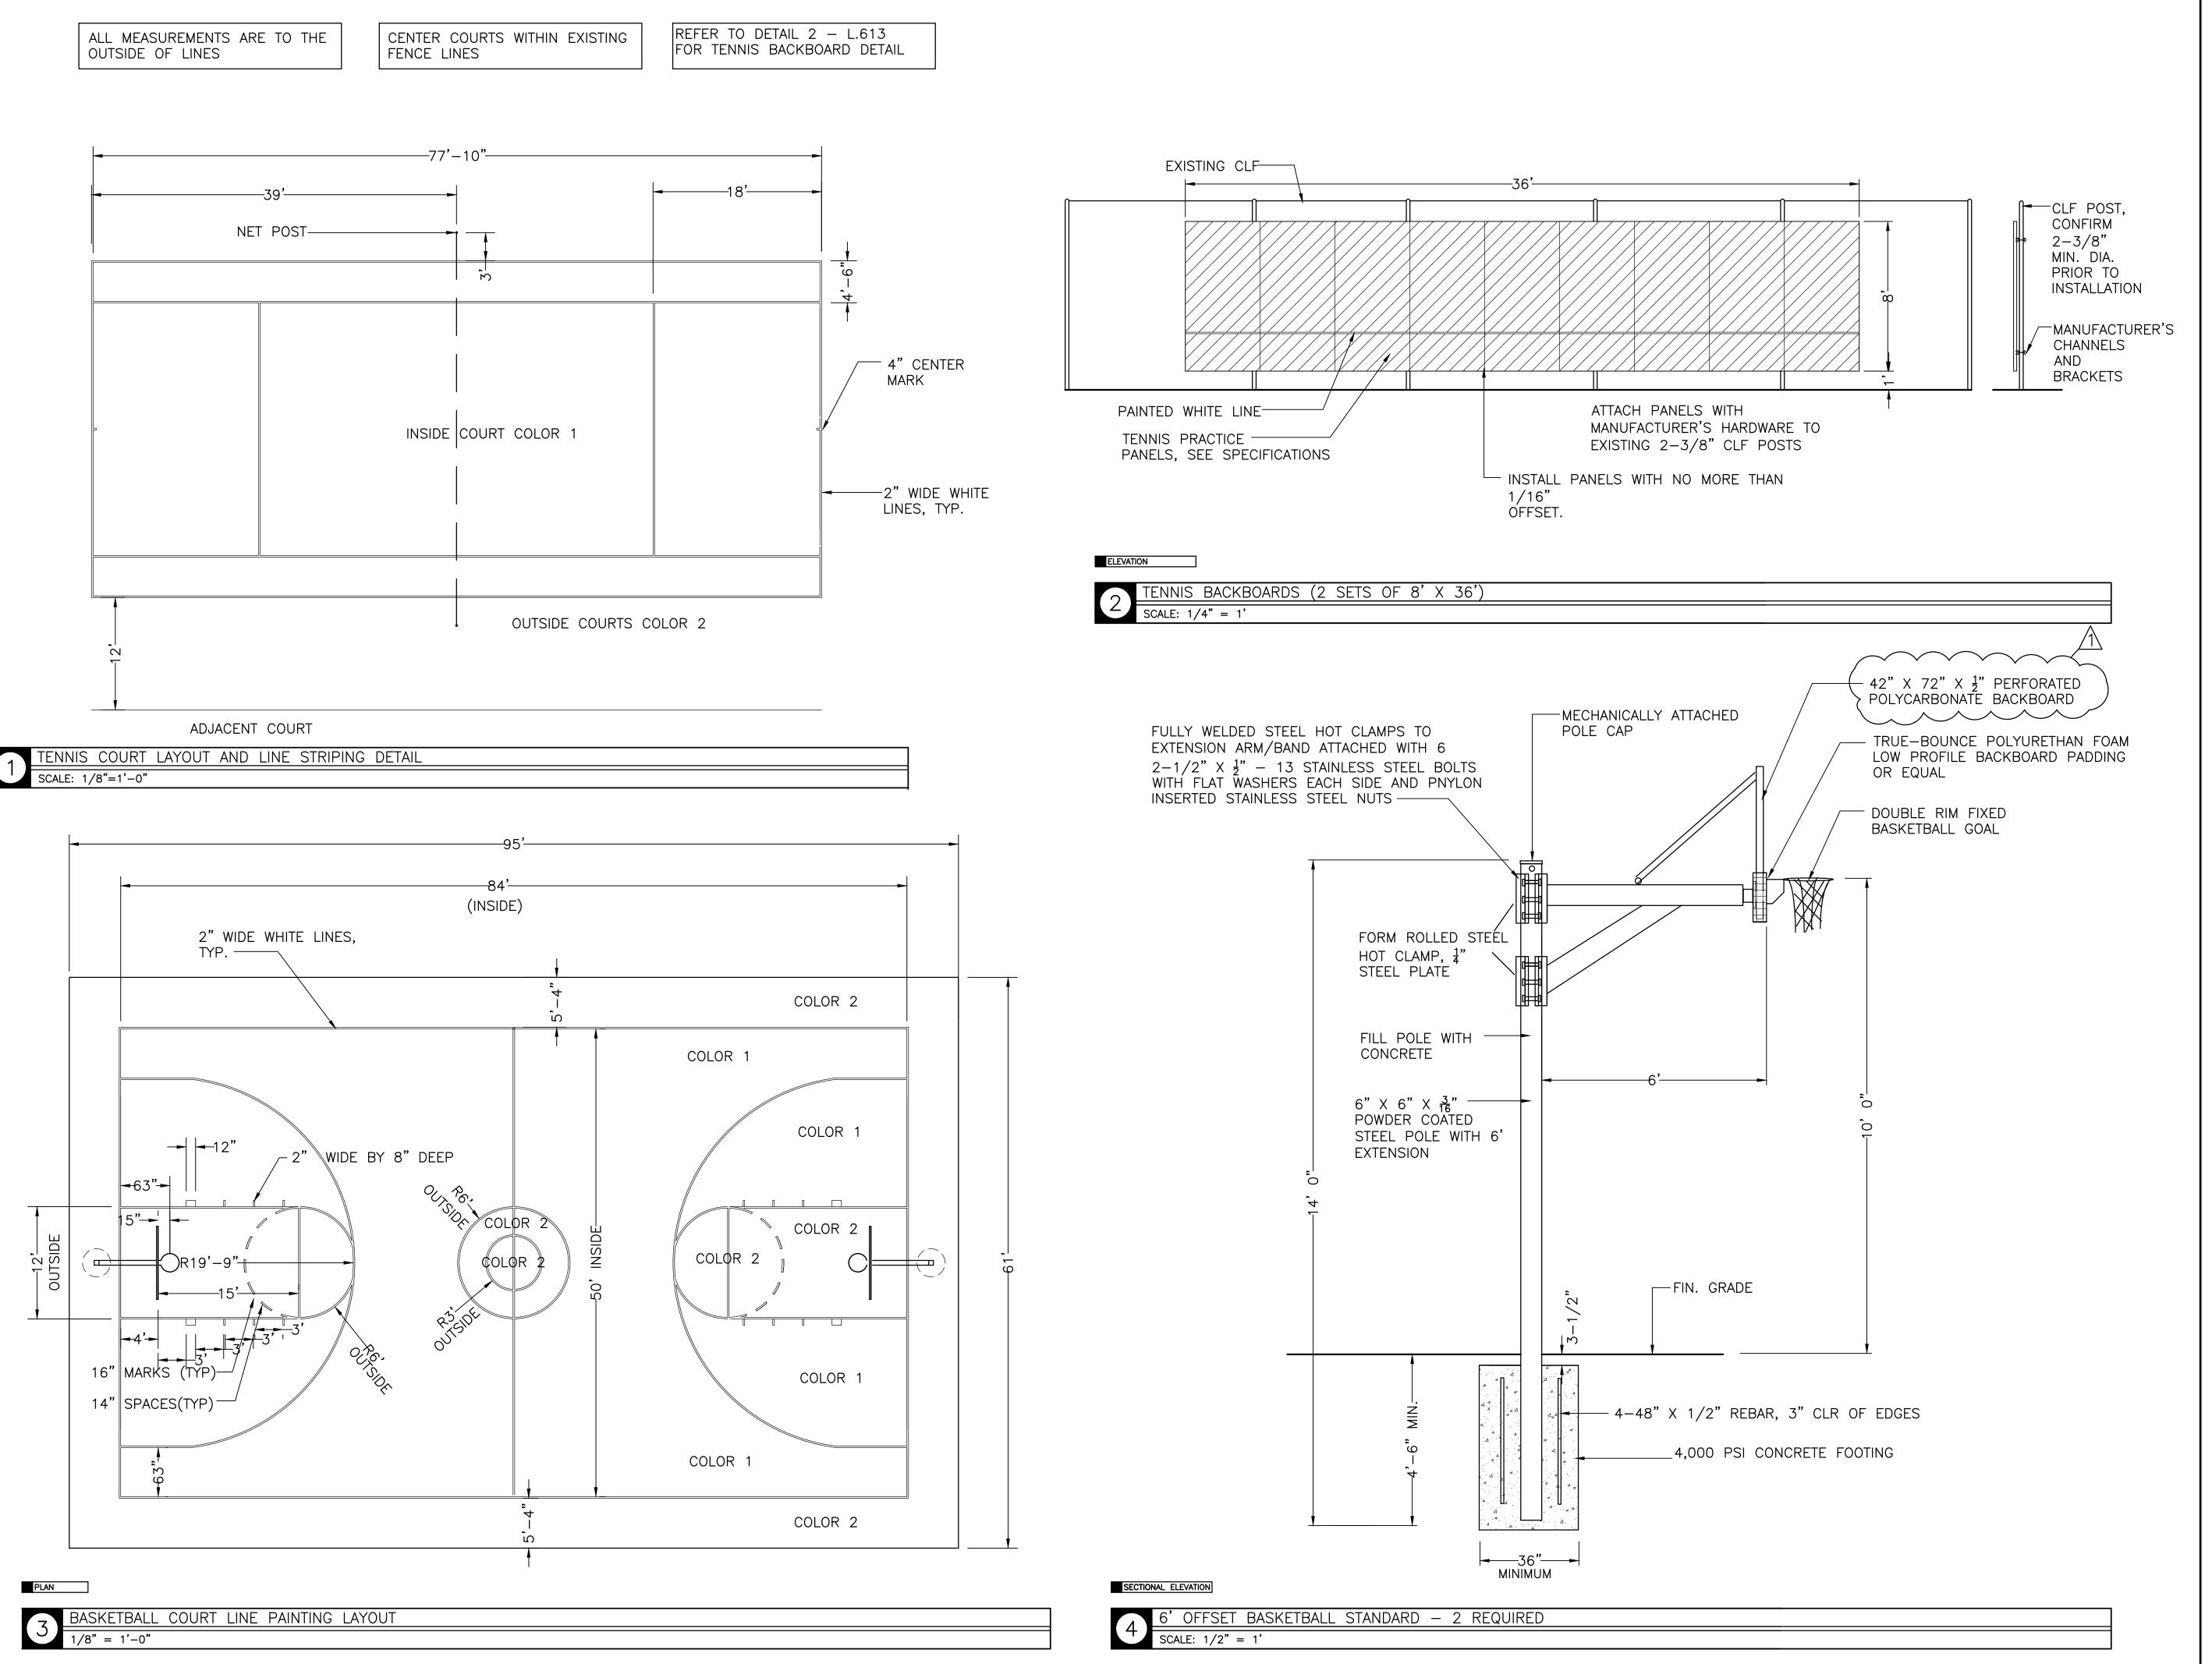

Landscape Architecture / Planning

13 Elm Street, Milford, MA 01757 Telephone 508 478 8426, Facsimile 508 478 8607



Site Engineering Consultants, Inc.
55 Grape Shot Road
Sharon, Massachusetts 02067 TEL: (781) 784-0326 FAX: (781) 784-0492 CONSULTING CIVIL ENGINEERS



REVISED ADDENDUM #1 11/20/17 No. Description Date REVISIONS

Project:


CITY OF WALTHAM CRAVERSON PLAYCROUND 16 PINE VALE ROAD WALTHAM, MA 02451

Prepared For:

CITY OF WALTHAM DEPARTMENT OF RECREATION 510 MOODY STREET WALTHAM, MA 02453

TENNIS/BBALL COURT **DETAILS**

AS NOTED Date OCT 31, 2017 Drawn By CCC Checked By DRB Approved By VH Project No. 1710.00

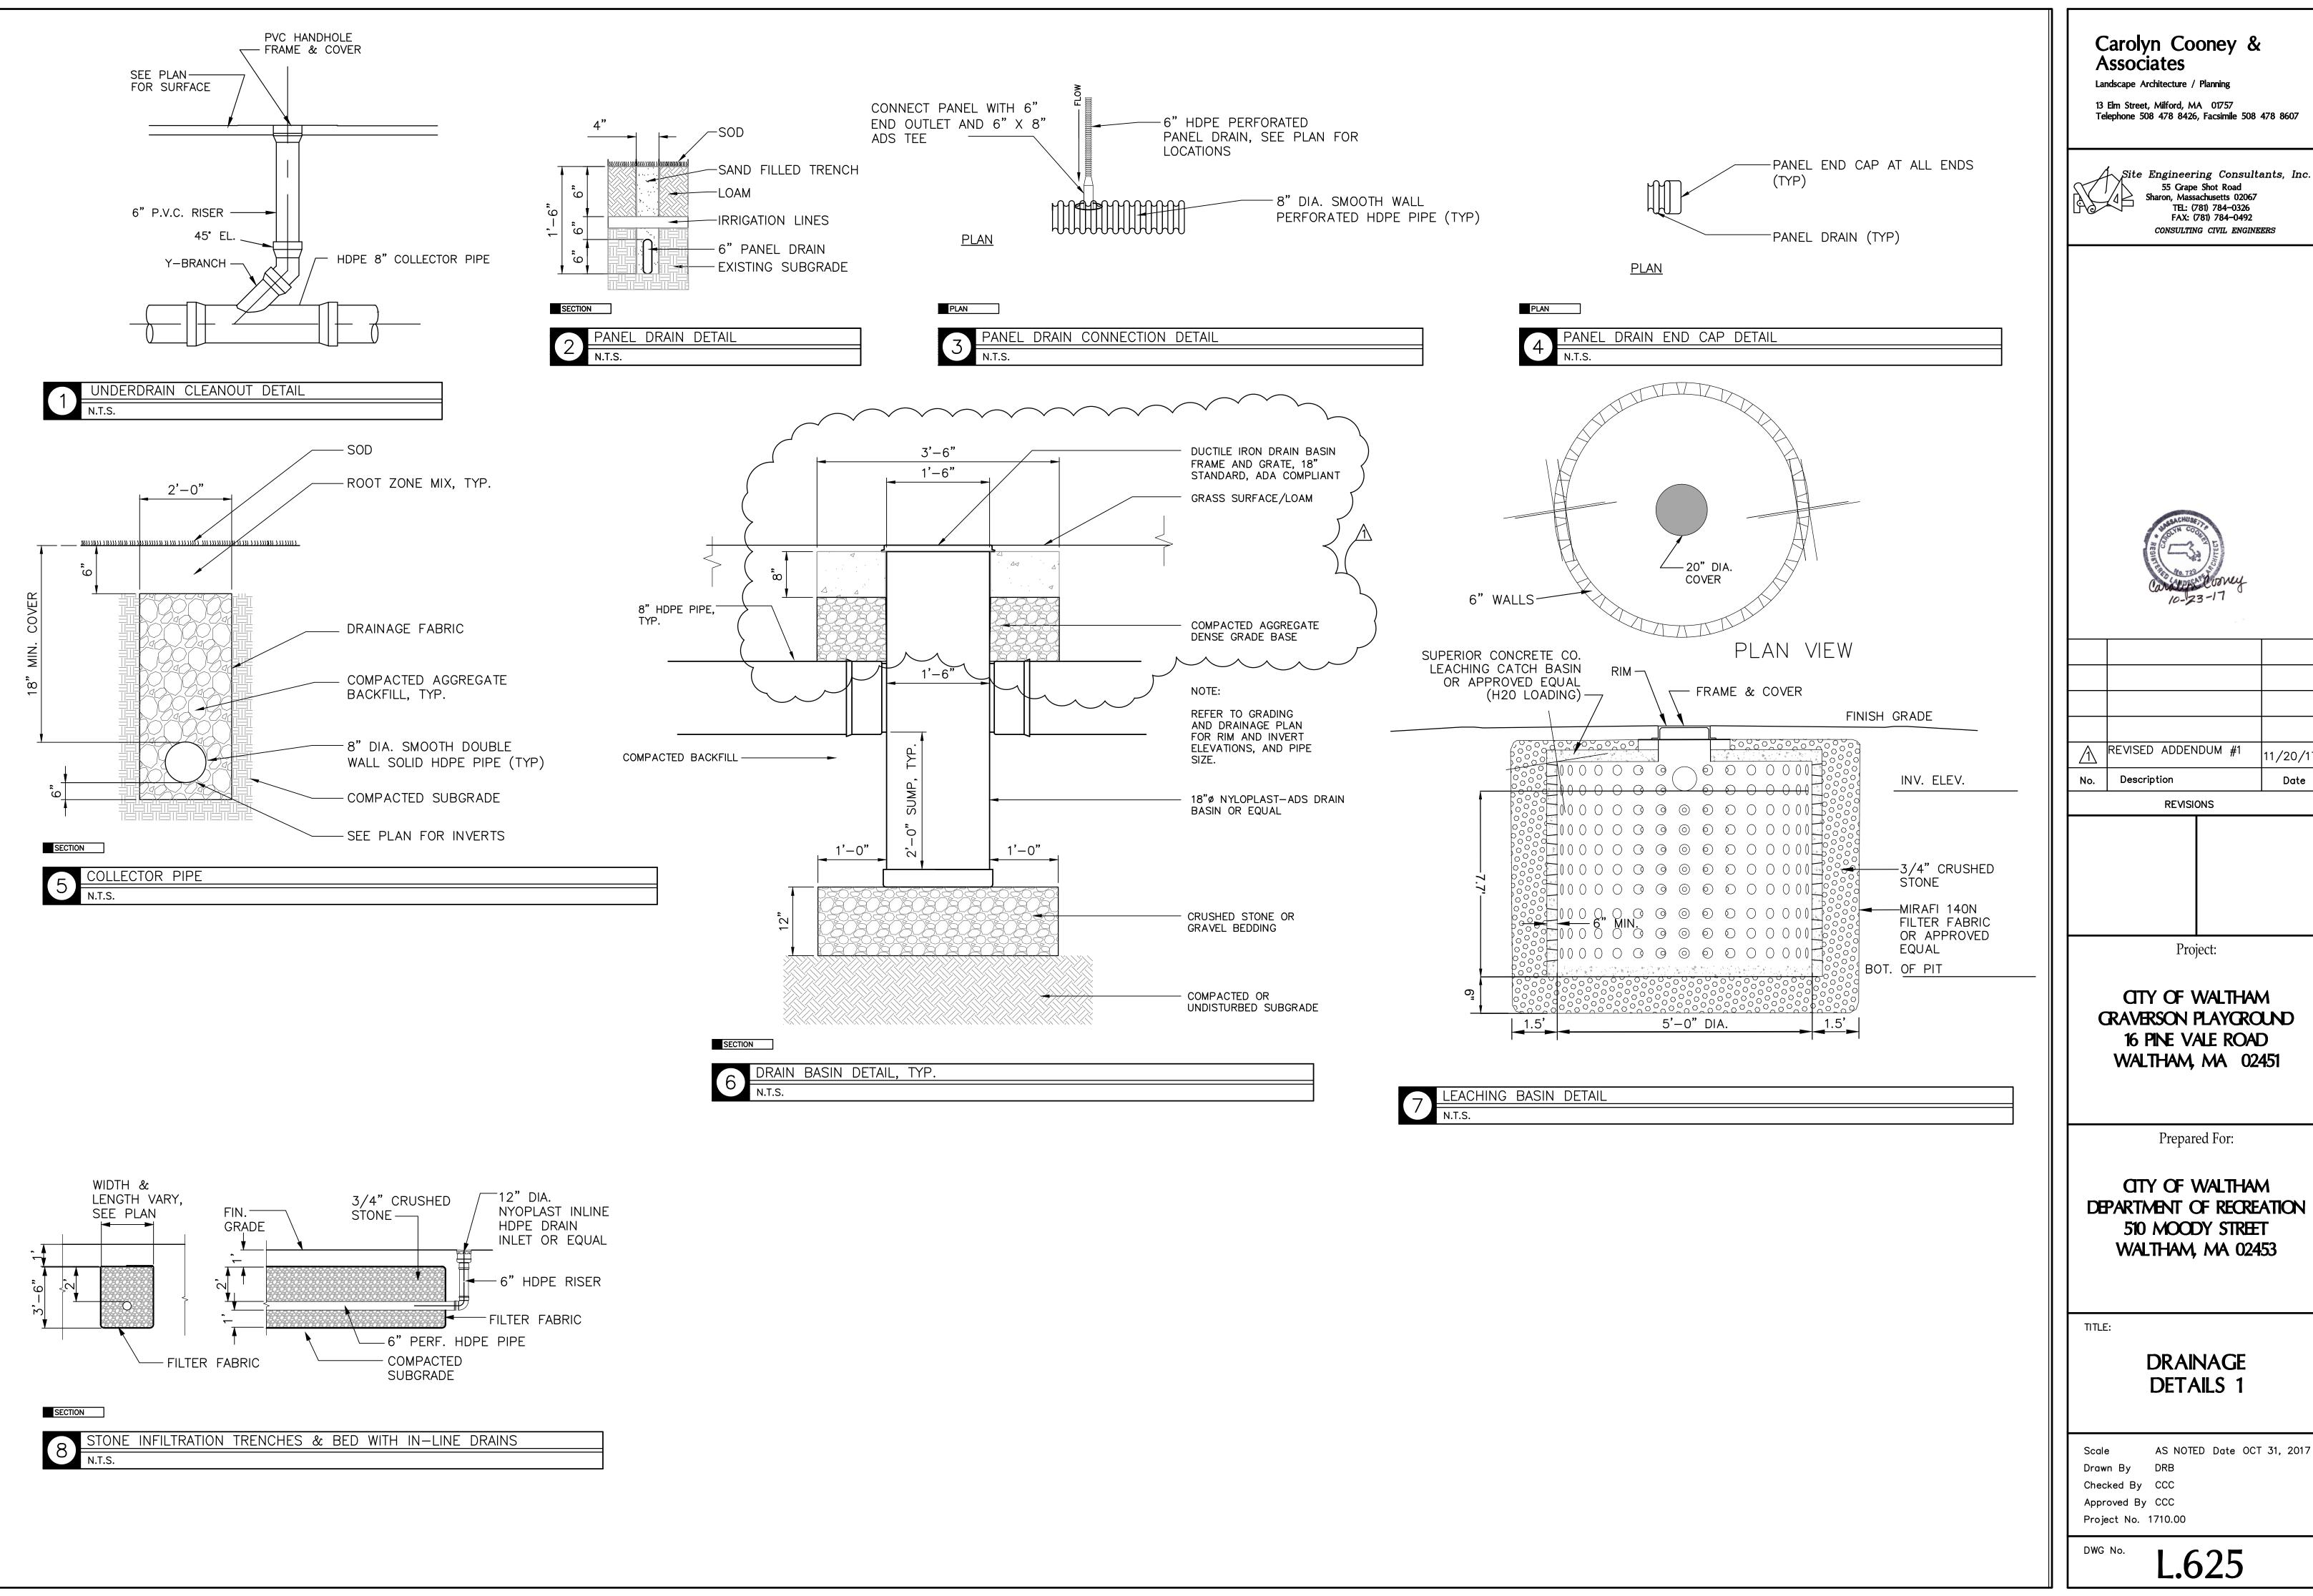

Telephone 508 478 8426, Facsimile 508 478 8607

11/20/17

CRAVERSON PLAYCROUND 16 PINE VALE ROAD WALTHAM, MA 02451

CITY OF WALTHAM DEPARTMENT OF RECREATION 510 MOODY STREET

AS NOTED Date OCT 31, 2017

Construction Documents

Improvements to Elsie Turner Field

421 TRAPELO ROAD

WALTHAM, MASSACHUSETTS 02452

OCTOBER 31, 2017

ELSIE TURNER FIELD 421 Trapelo Rd Locus Plan Flore Mescon 5 off Gancords unpike Swammin Land Contended And Swammin Land Swammin Land Contended And Swammin Land Contended And Swammin Land Contended And Swammin Land Swammin Land Contended And Swammin Land Contended And Swammin Land Swammin Land Contended And Swammin Land Contended And Swammin Land Swammin Land Contended And Swammin Land Swammin Land Swammin Land Contended And Swammin Land Contended And Swammin Land Swammin Land Swammin Land Contended And Swammin Land Swamm

MAYOR JEANNETTE A. McCARTHY CITY OF WALTHAM

CITY OF WALTHAM RECREATION DEPARTMENT
510 MOODY STREET
WALTHAM, MASSACHUSETTS 02453

LANDSCAPE ARCHITECT: CAROLYN COONEY & ASSOCIATES

13 ELM STREET
MILFORD, MASSACHUSETTS 01757
TEL: (508) 478–8426
FAX: (508) 478–8607

SUBCONSULTANTS:
WILLIAMS & SPARAGES, LLC
CIVIL ENGINEERS
189 NORTH MAIN STREET
MIDDLETON, MA 01949
(978) 539–8088

SHEPARD ENGINEERING, INC.
ELECTRICAL CONSULTANTS
1308 GRAFTON STREET
WORCESTER, MA 01604
(508) 757-7793

S-1


Index of Drawings

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SHT 2 OF 2	EXISTING CONDITIONS PLAN
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L.101,L.102,L.103	SITE PREPARATION PLAN
L.201,L.202	MATERIALS PLAN
L.301,L.302	LAYOUT PLAN
L.401,L.402	GRADING & DRAINAGE PLAN
L.451,L.452	UTILITY COORDINATION PLAN
L.501,L.502	PLANTING PLAN
L.601	SITE PREPARATION DETAILS
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L.603	PAVING, CURBING & FLAGPOLE DETAILS
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L.605	FENCING DETAILS
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L.613	EXERCISE EQUIPMENT DETAILS
L.614	DUGOUT SHELTER DETAILS
L.615	SCOREBOARD/SOFTBALL FIELD DETAILS
L.616	FOUL POLE/BLEACHER DETAILS
L.617	FIELD LIGHTING LAYOUT & DETAILS
L.618	SITE FURNITURE DETAILS 1
L.619	SITE FURNITUTE DETAILS 2
L.620	SHADE SHELTER DETAILS
L.621	PARKING LOT SIGNAGE/STRIPING
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ES-1A, E-1B	SITE PLAN: ELECTRICAL
ES-2	ELECTRICAL DETAILS
C-1	DRAINAGE DETAILS

RETAINING WALL DETAILS

Survey
GREEN INTERNATIONAL AFFILIATES, INC.
CIVIL & STRUCTURAL ENGINEERS
WESTFORD, MA

Supplemental Survey:
ALPHA SURVEYING & ENGINEERING, INC.
695 WAREHAM STREET
MIDDLEBOROUGH, MA 02346
(508) 295-5505

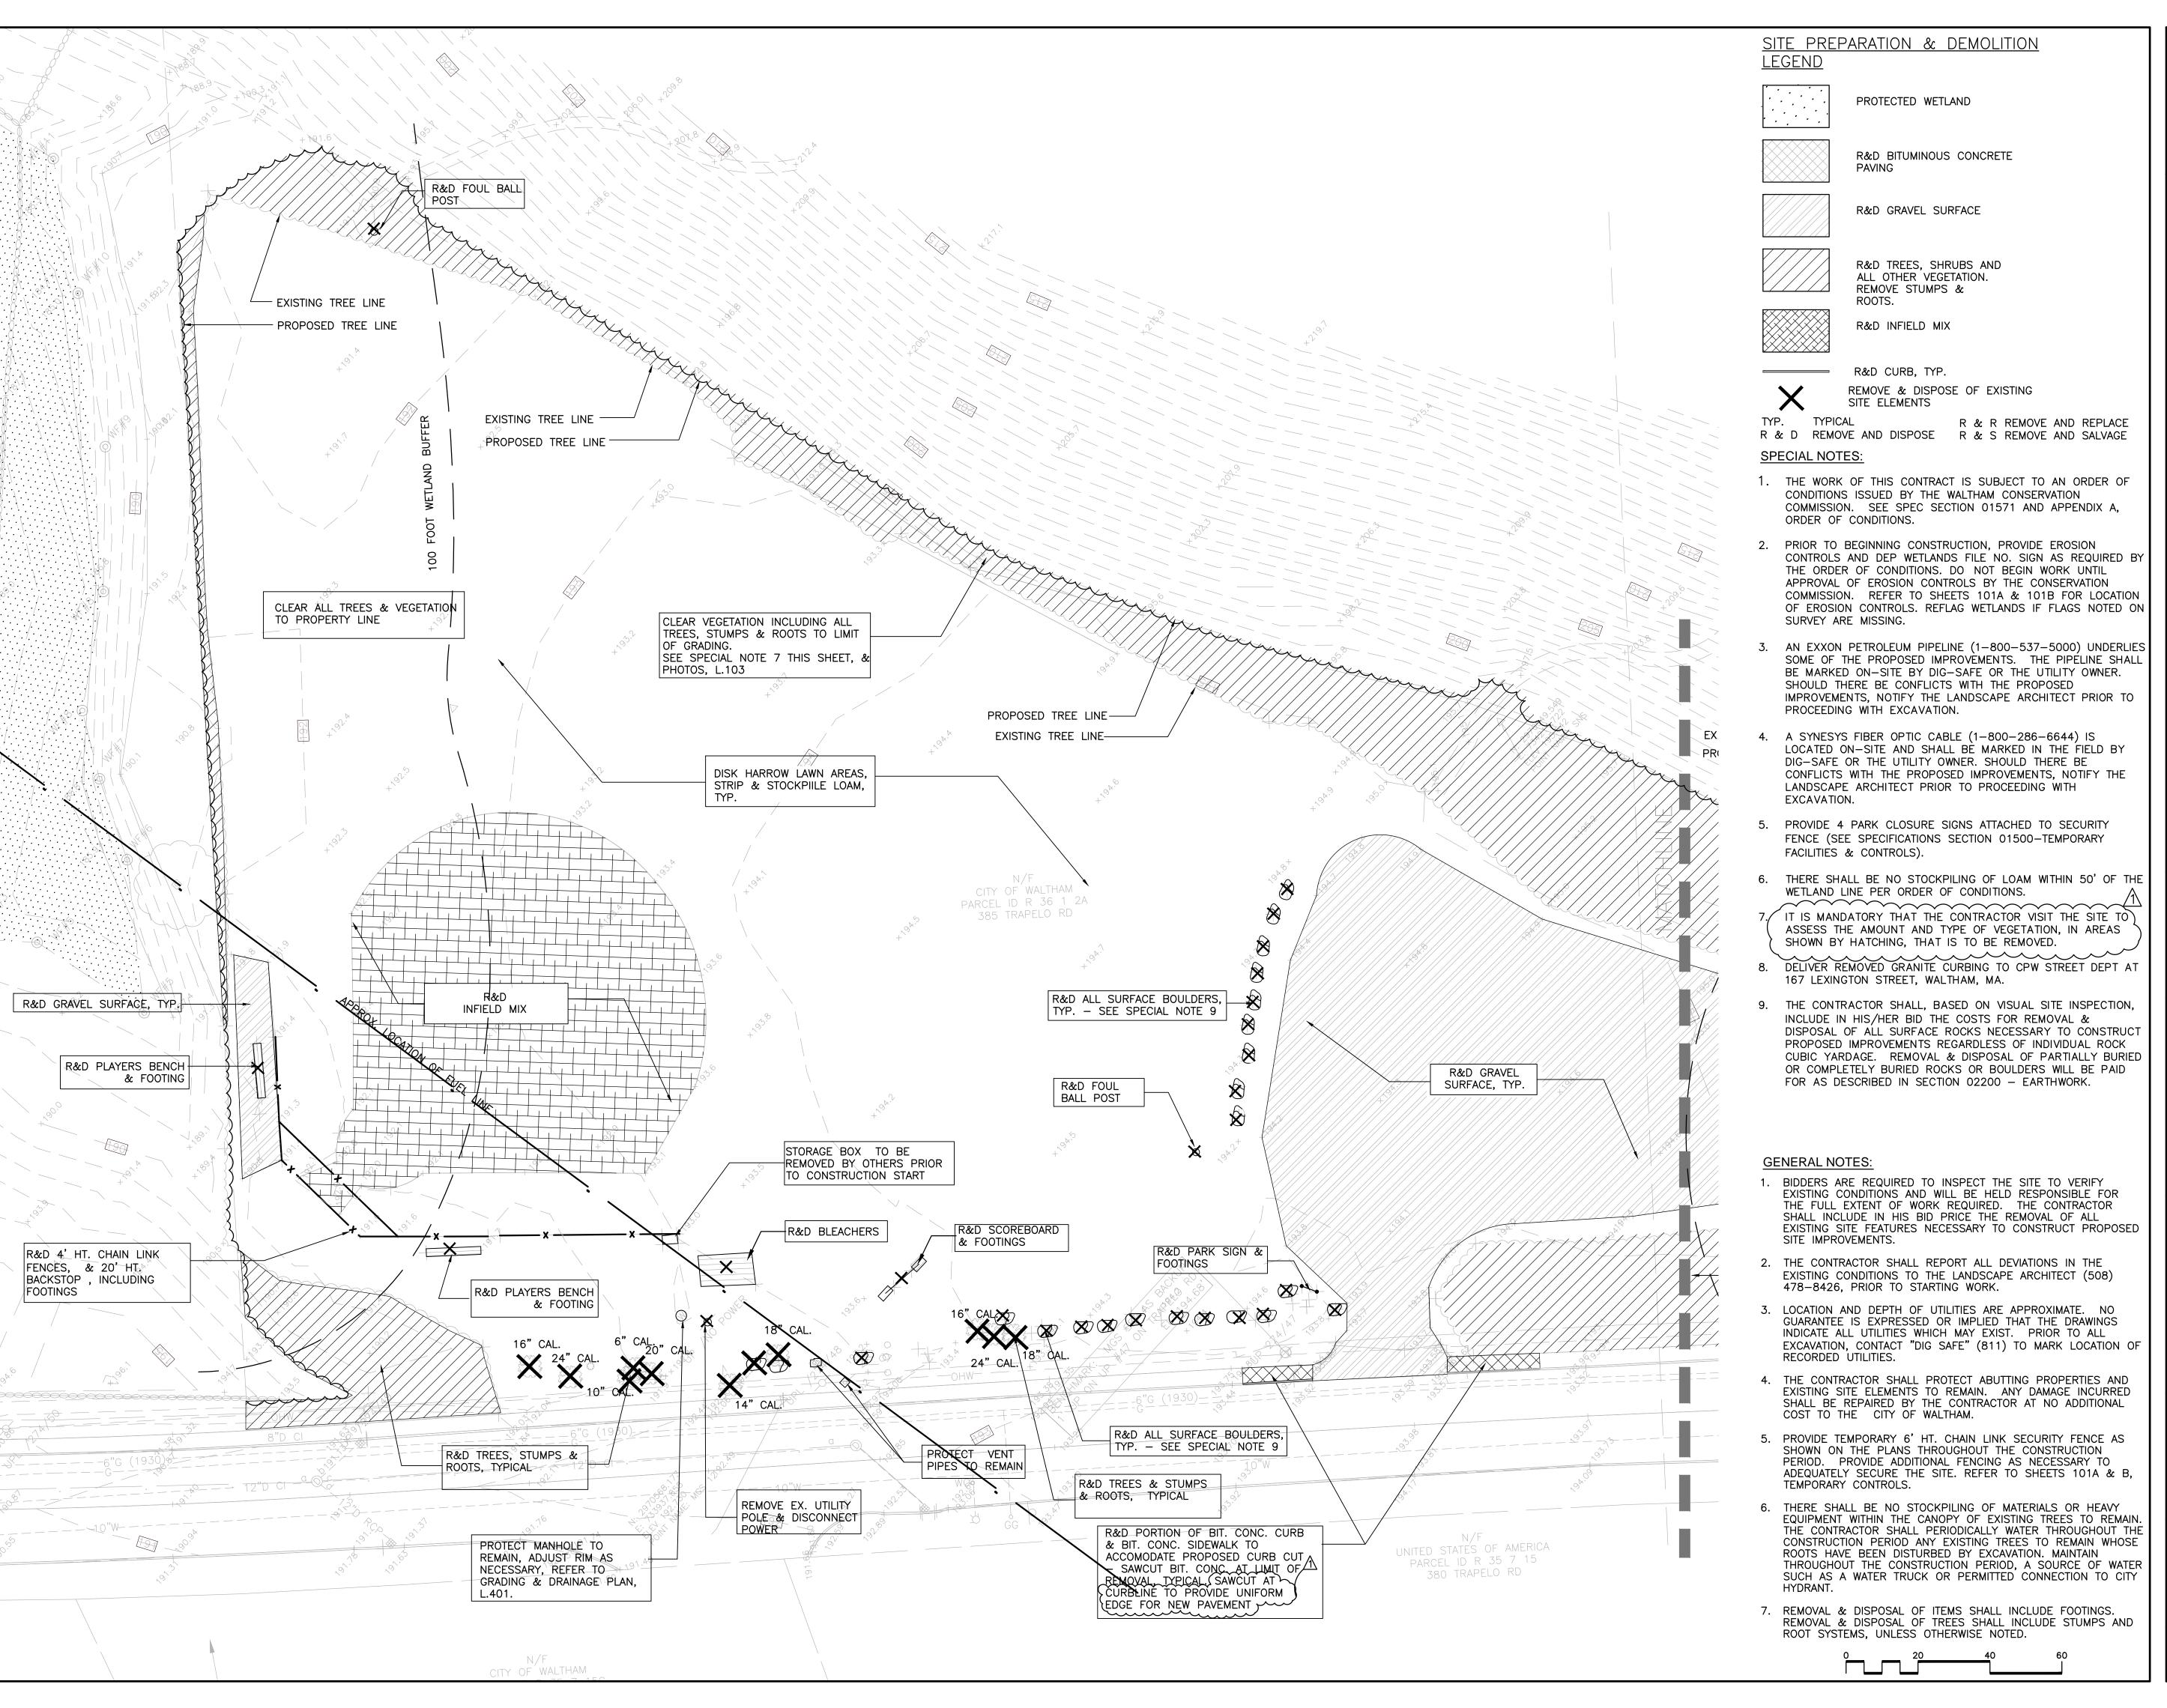


Landscape Architecture / Planning 13 Elm Street, Milford, MA 01757 Telephone 508 478 8426, Facsimile 508 478 8607



REVISED ADDENDUM #1 ELEVATIONS 11/20/17 Description No.

REVISIONS

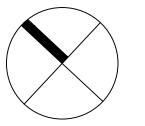

Project:

CITY OF WALTHAM ELSIE TURNER FIELD 421 TRAPELO ROAD WALTHAM, MA 02452

Prepared For:


CITY OF WALTHAM DEPARTMENT OF RECREATION 510 MOODY STREET WALTHAM, MA 02453

SITE PREPARATION **PLAN**

Date OCT. 31, 2017 1"=20' Drawn By CCC

Checked By DRB Approved By CCC Project No. 1710.00

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REVISIONS

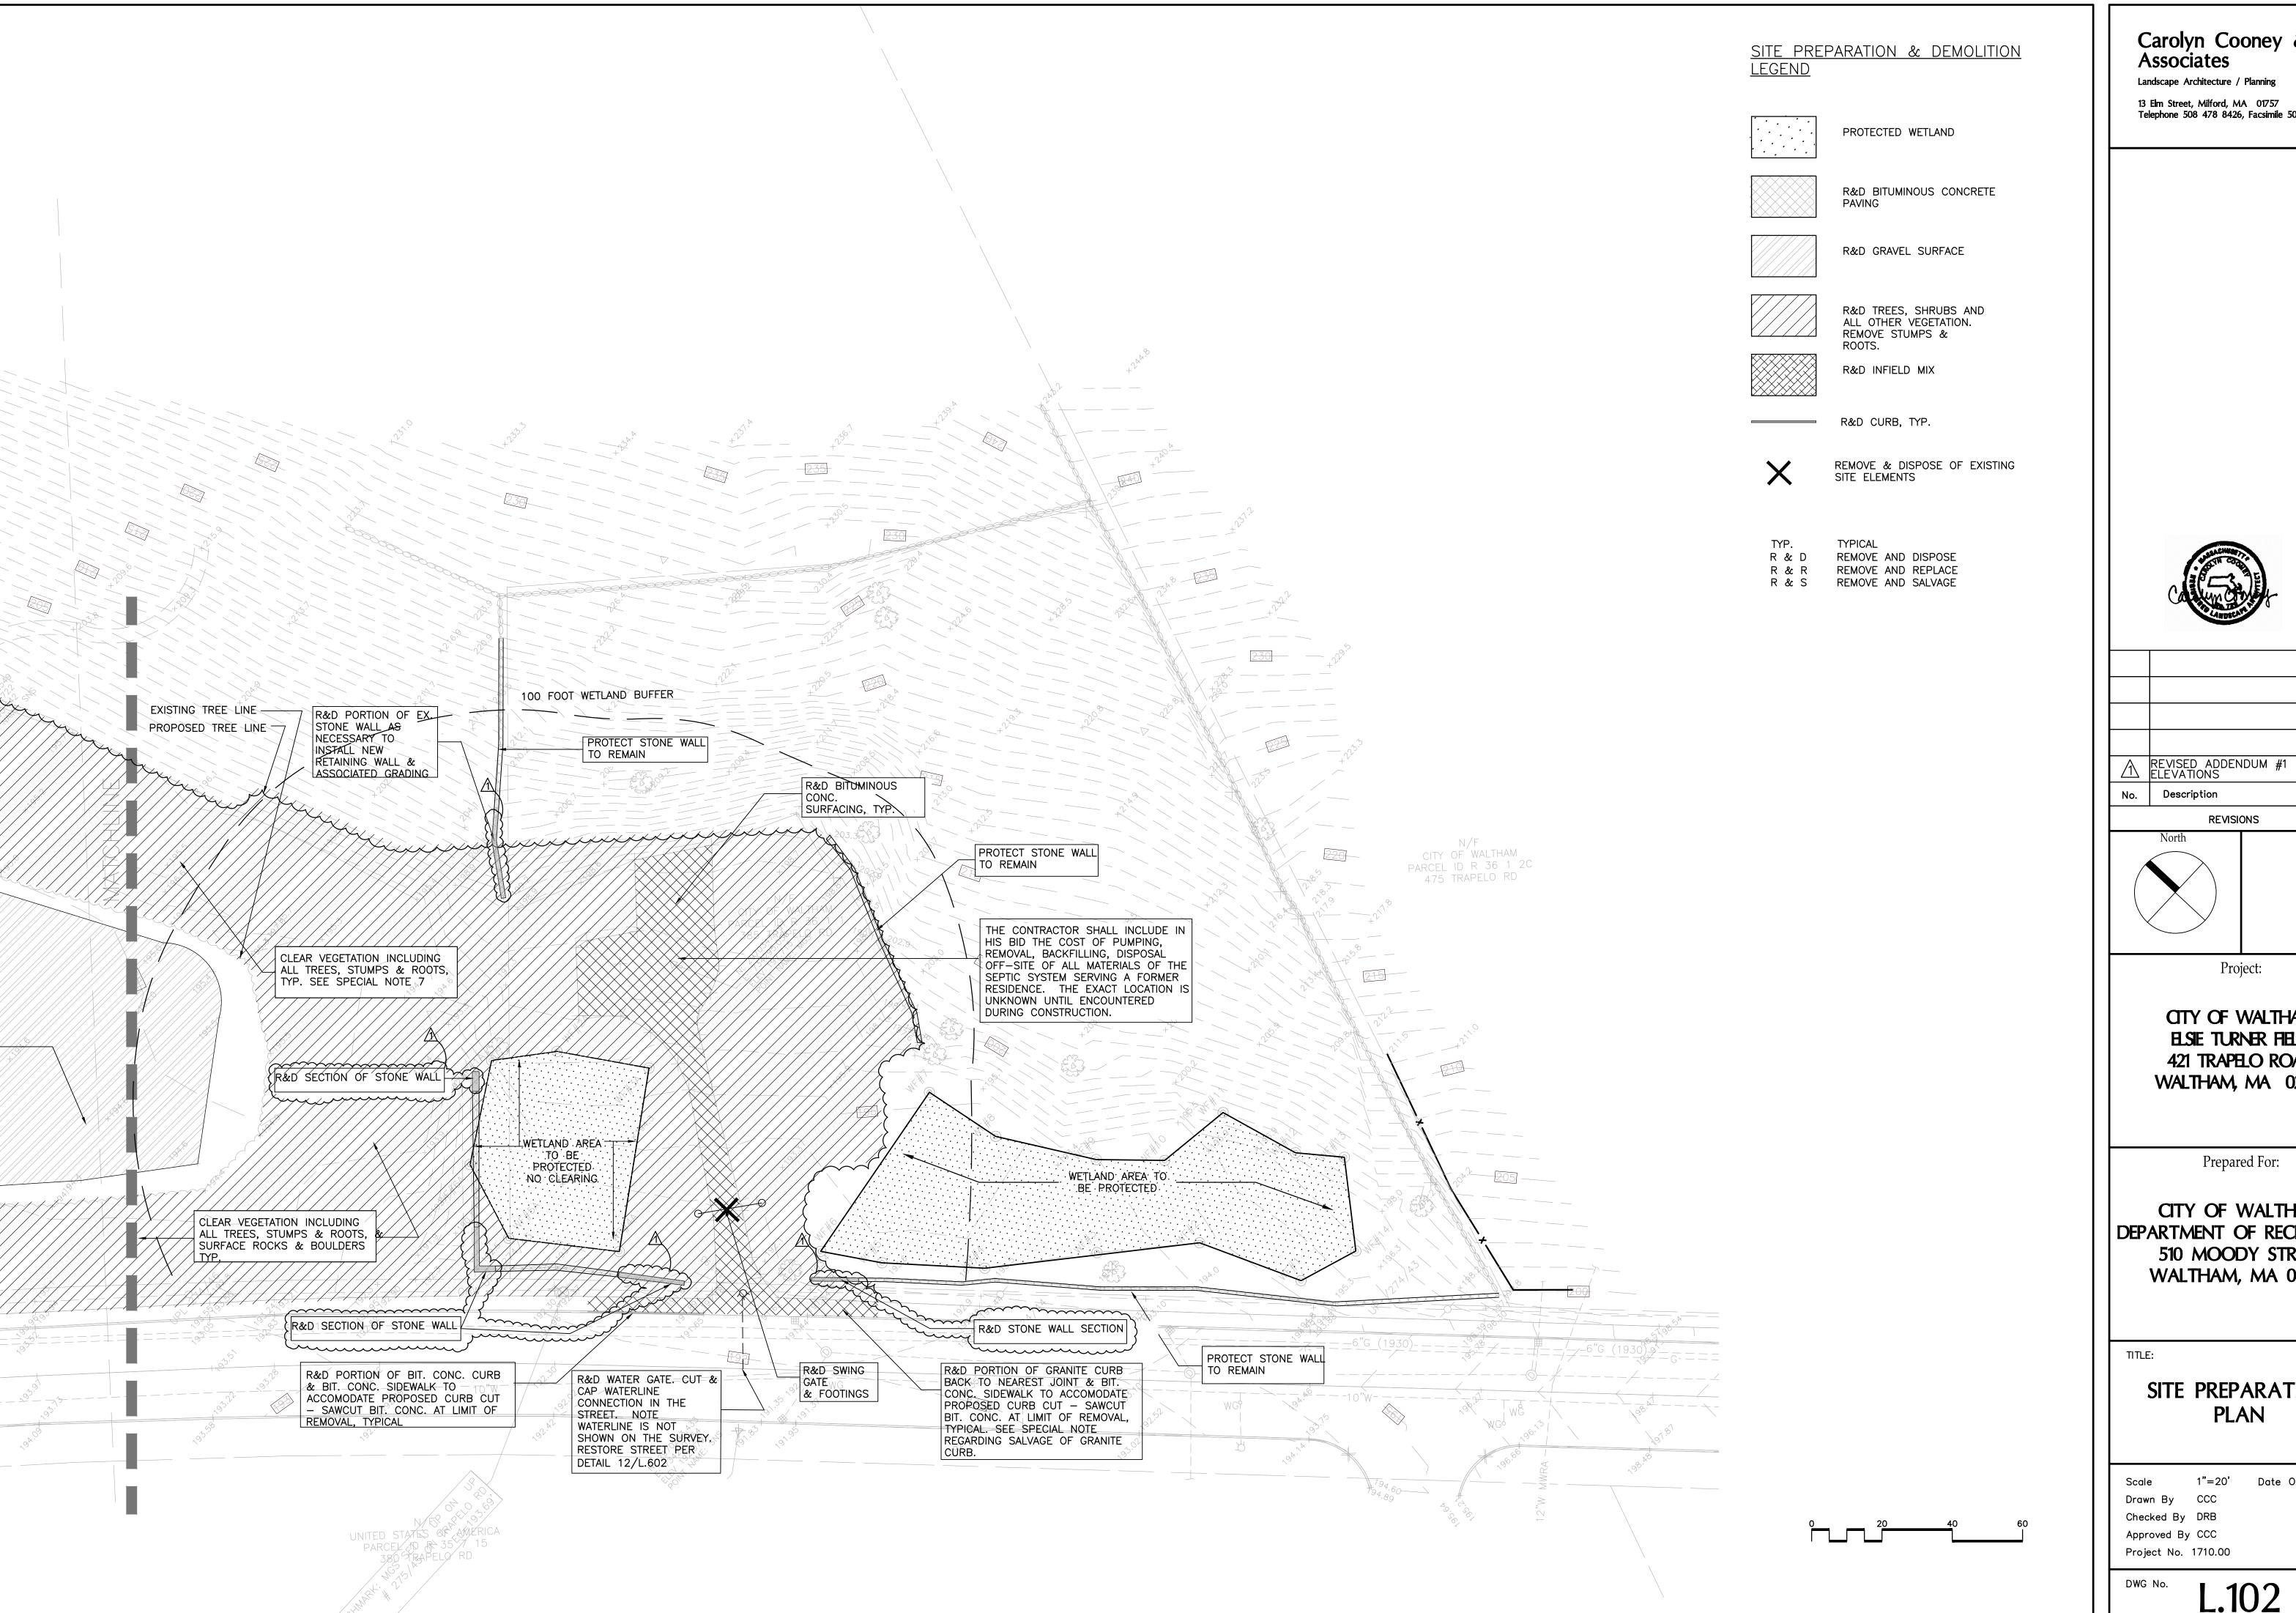Description

11/20/17

Project:

CITY OF WALTHAM ELSIE TURNER FIELD 421 TRAPELO ROAD WALTHAM, MA 02452


Prepared For:

CITY OF WALTHAM | DEPARTMENT OF RECREATION | 510 MOODY STREET WALTHAM, MA 02453

SITE PREPARATION **PLAN**

1"=20' Date OCT. 31, 2017 Drawn By CCC

Checked By DRB Approved By CCC Project No. 1710.00

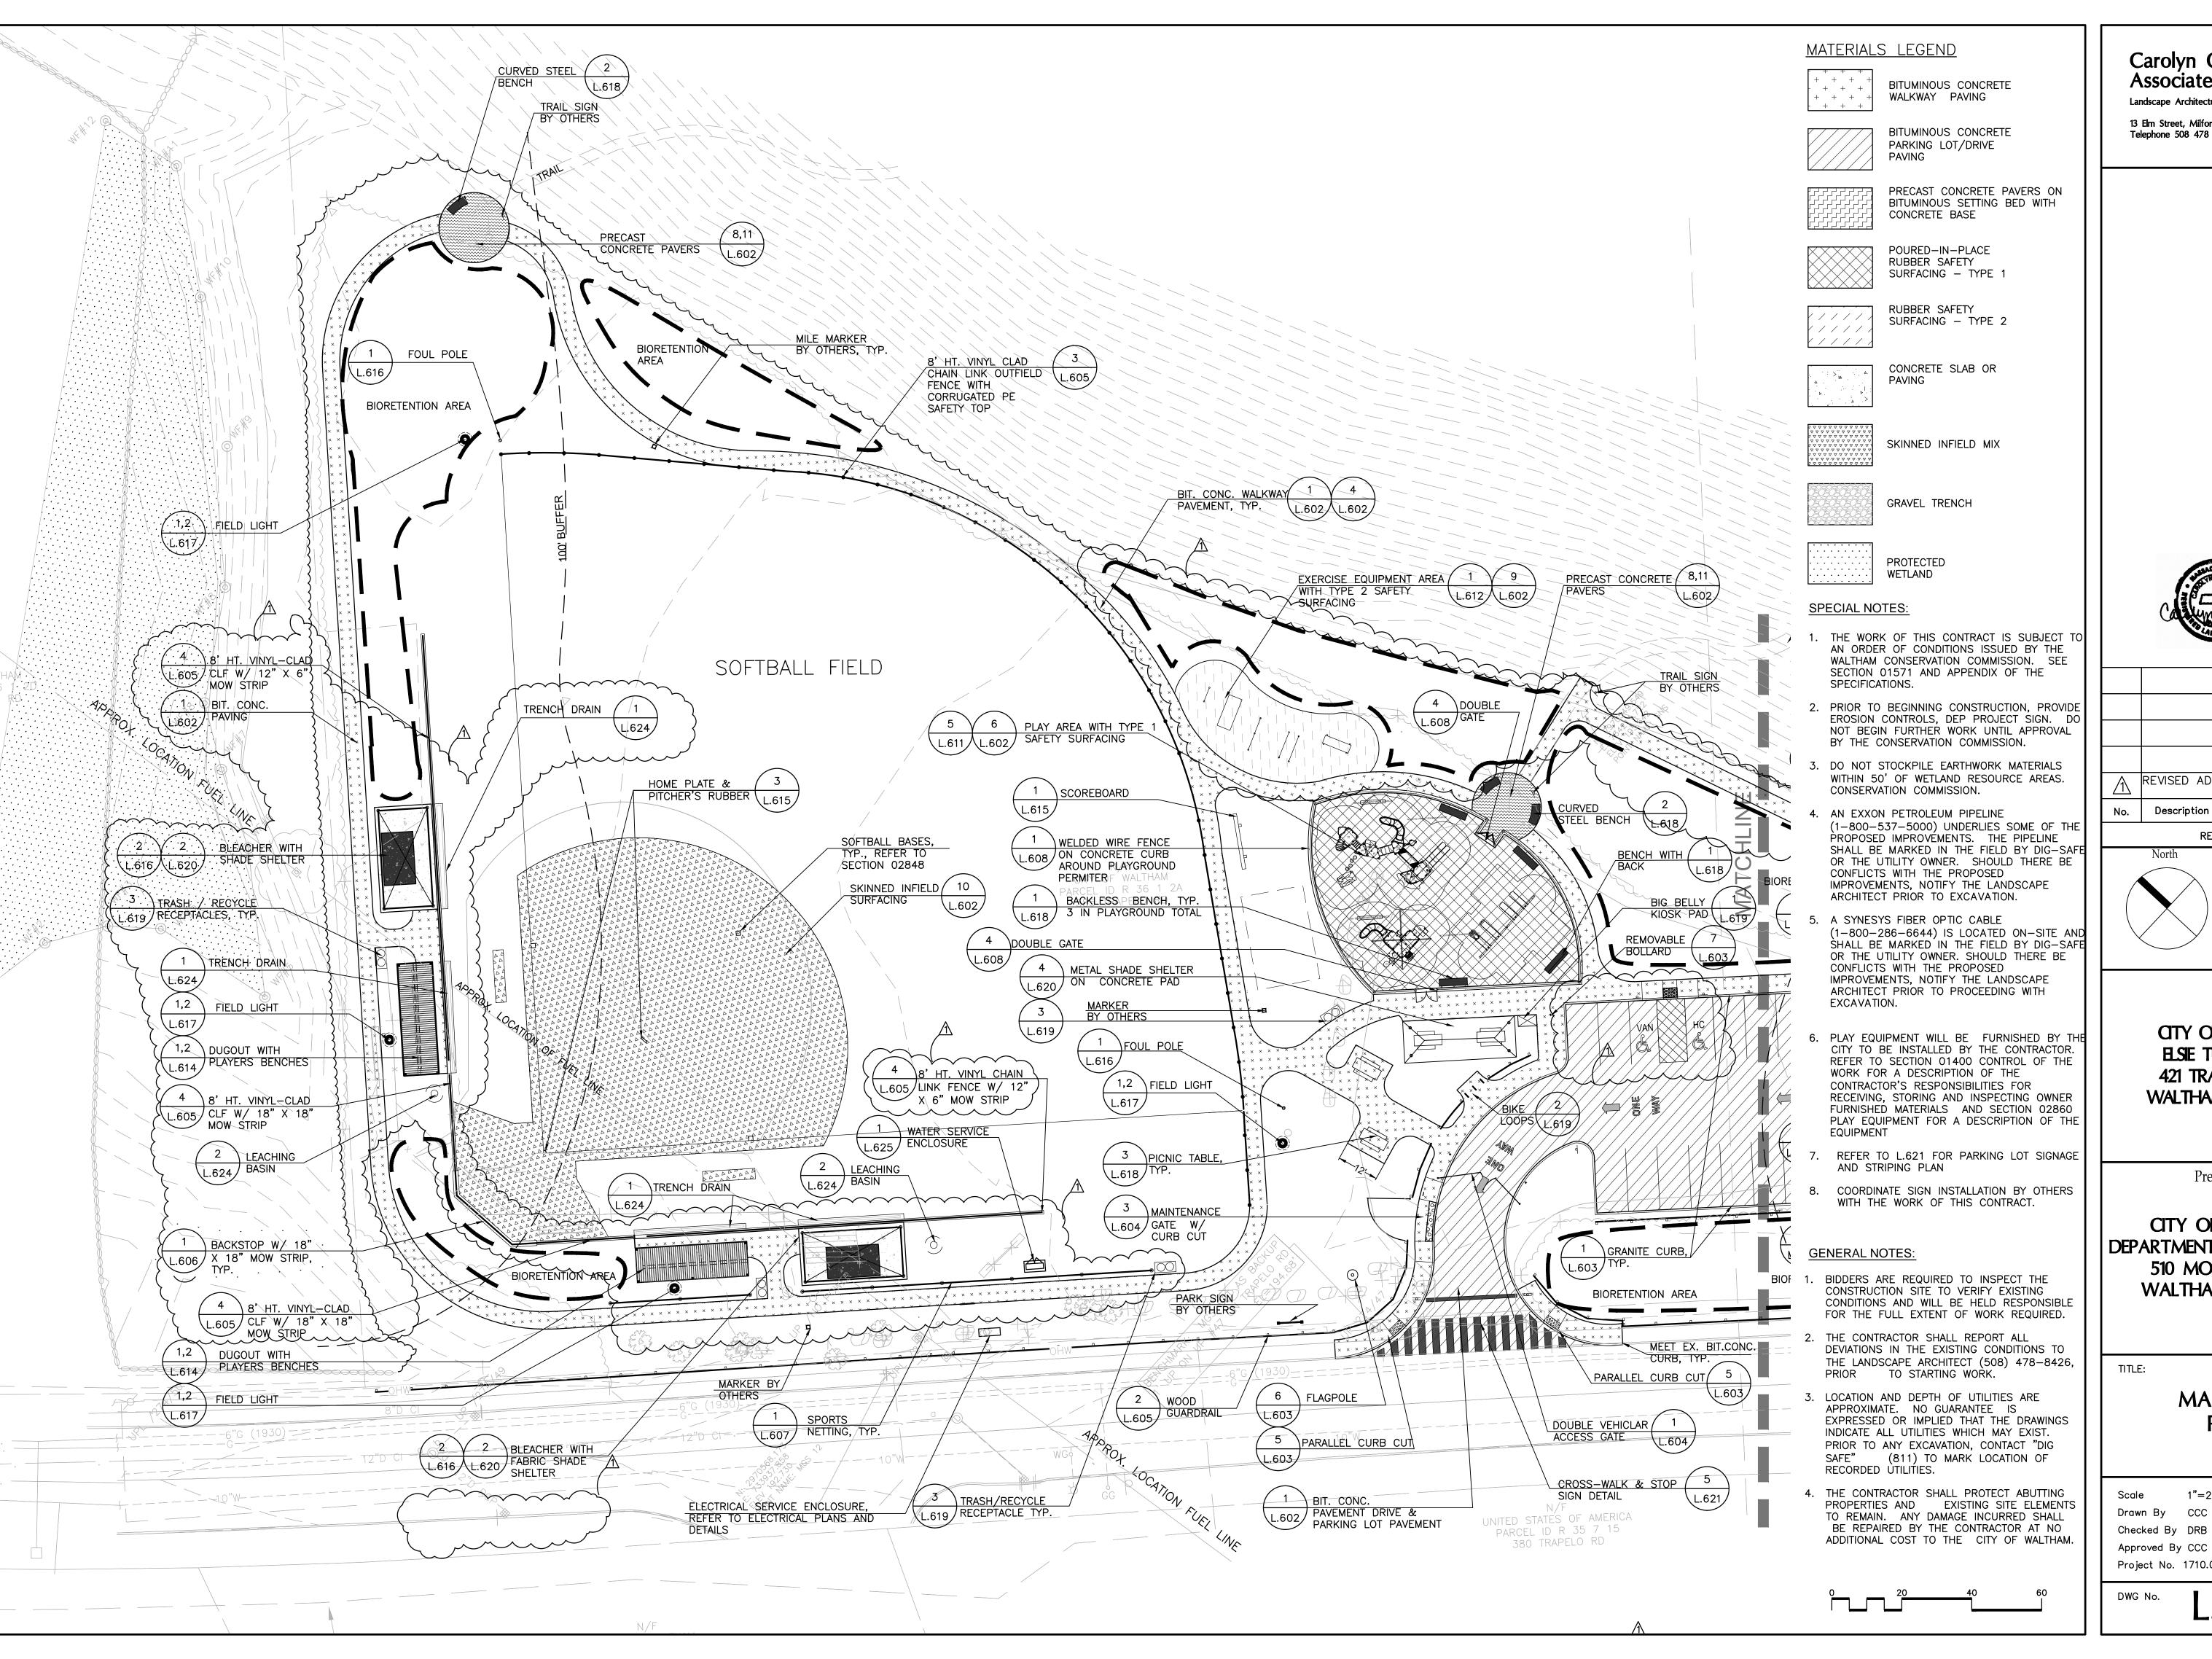


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Â	REVISED ADDENDUM #1	11/20/17

REVISIONS



Project:

CITY OF WALTHAM ELSIE TURNER FIELD 421 TRAPELO ROAD WALTHAM, MA 02452

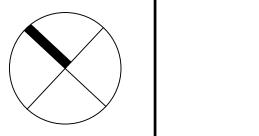
Prepared For:

CITY OF WALTHAM DEPARTMENT OF RECREATION 510 MOODY STREET WALTHAM, MA 02453


MATERIALS PLAN

1"=20' Date OCT. 31, 2017 Drawn By CCC

Approved By CCC Project No. 1710.00

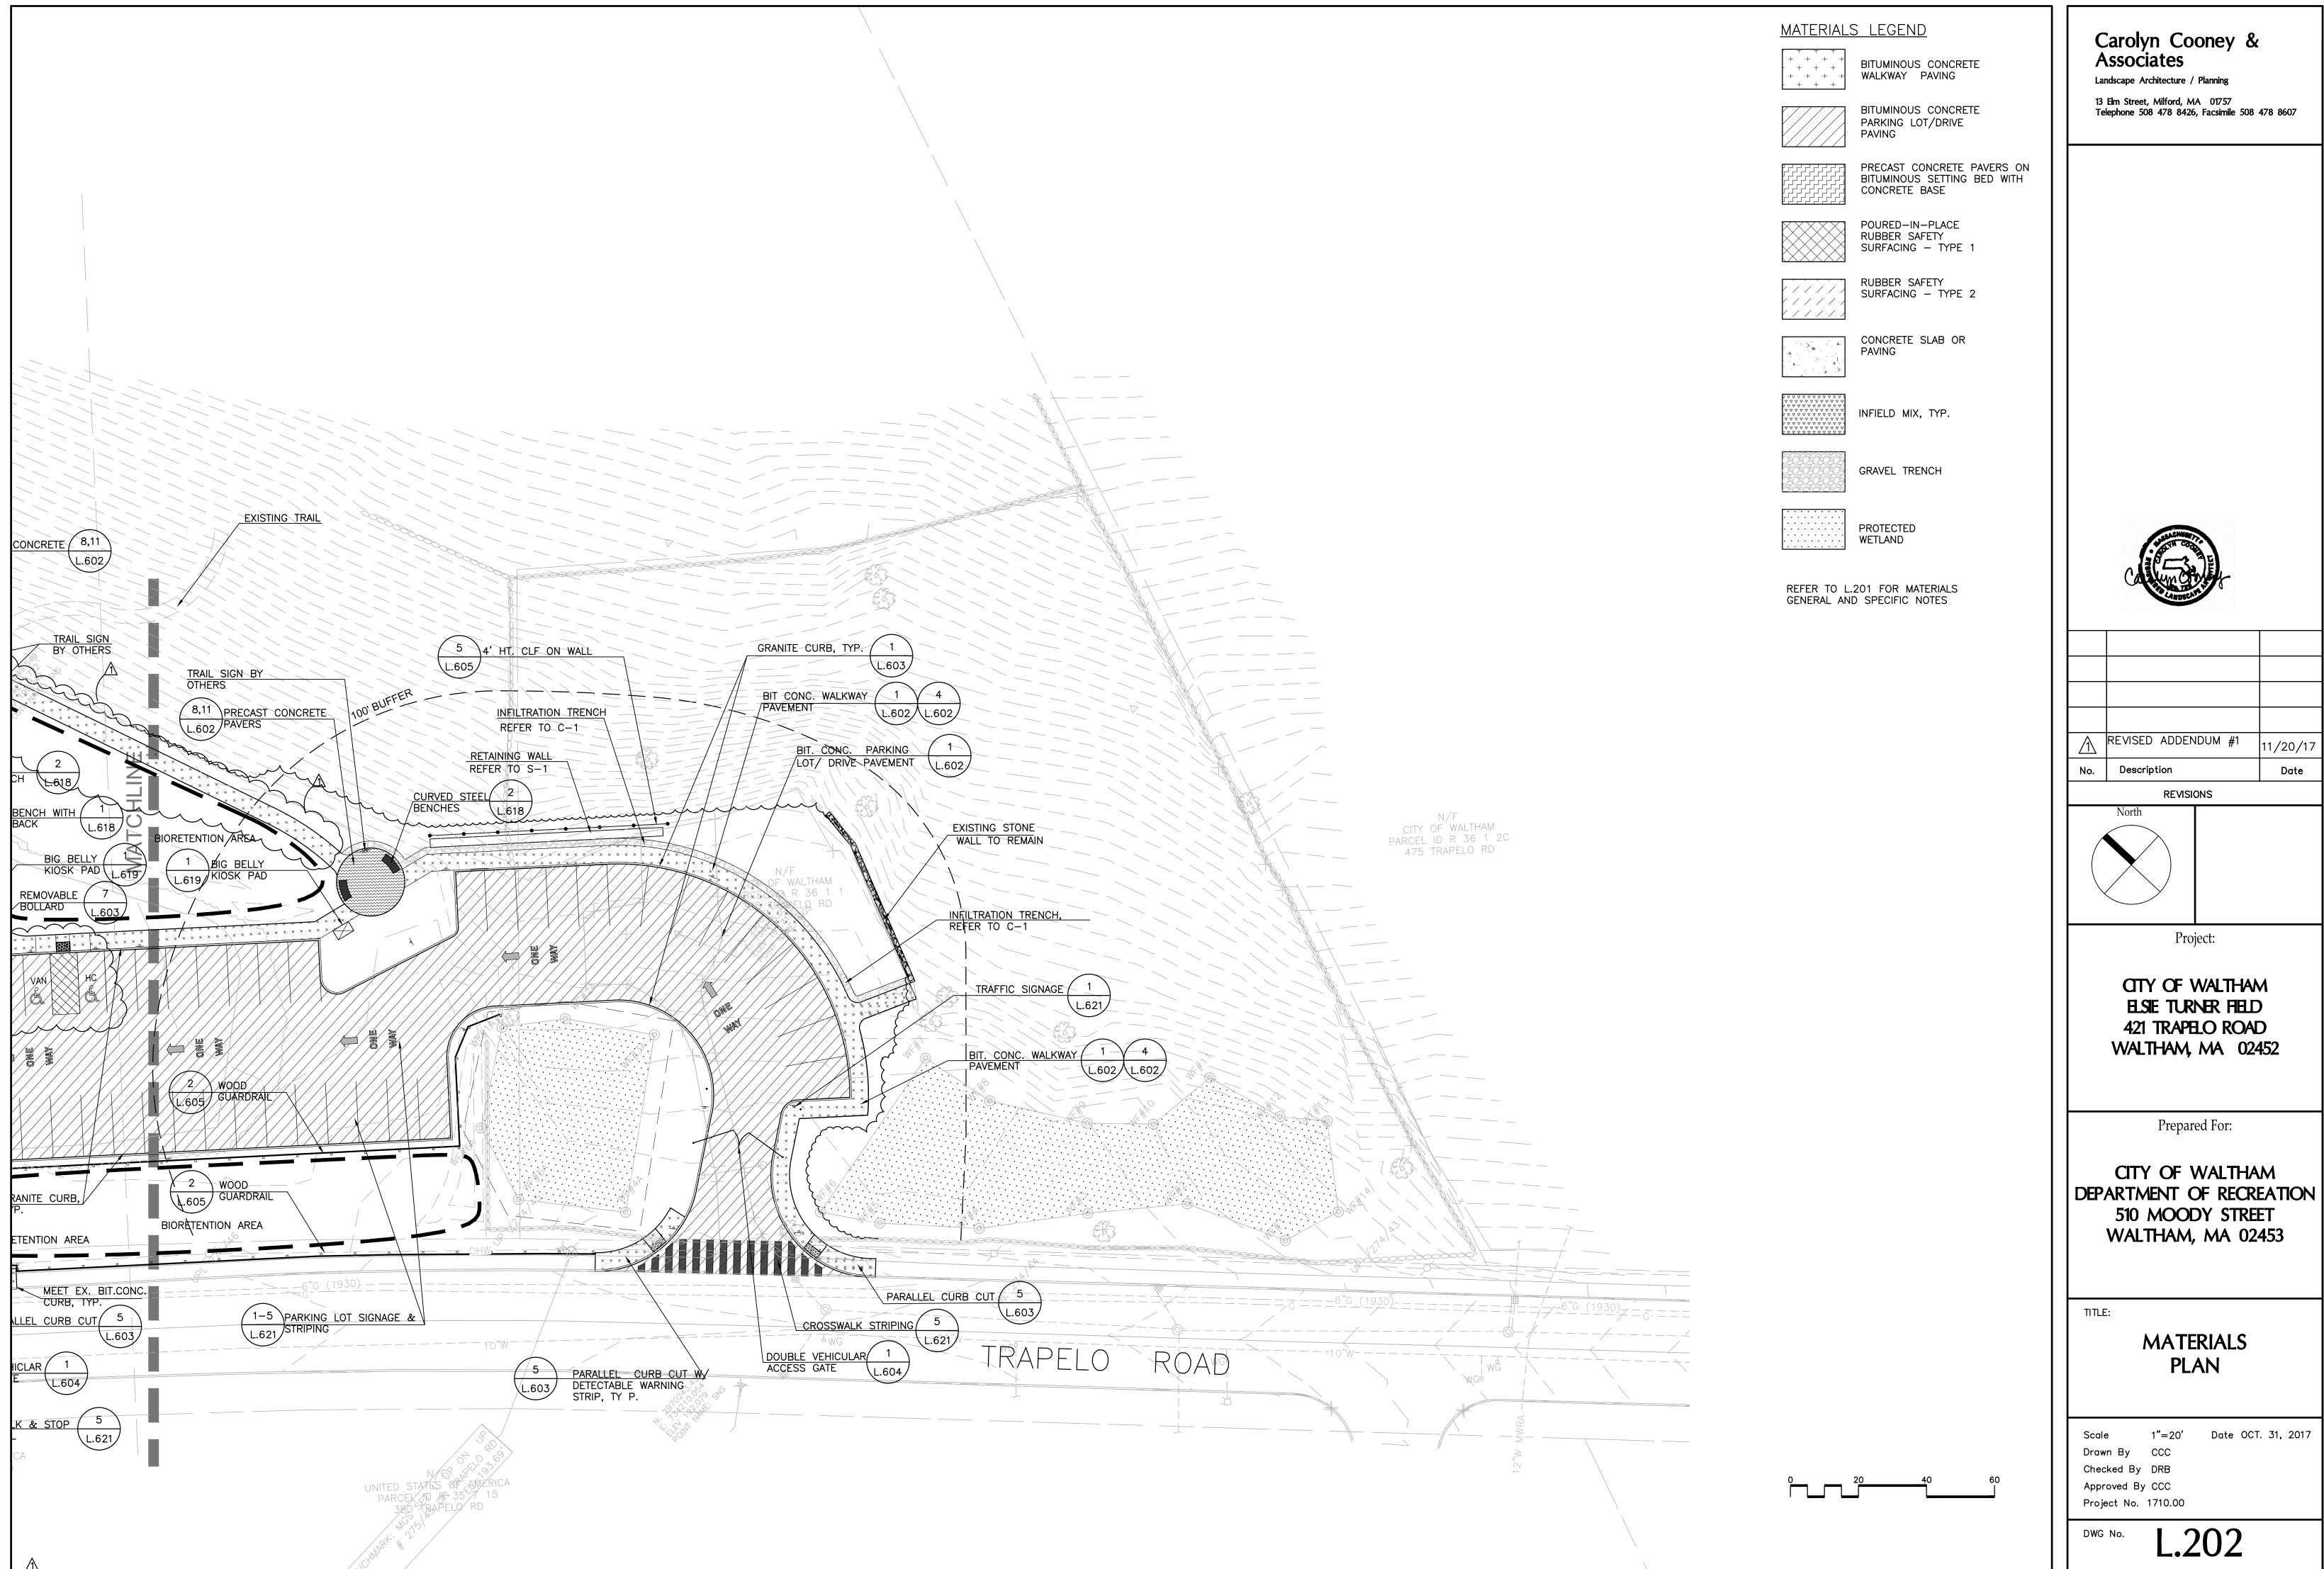

1"=20' Date OCT. 31, 2017

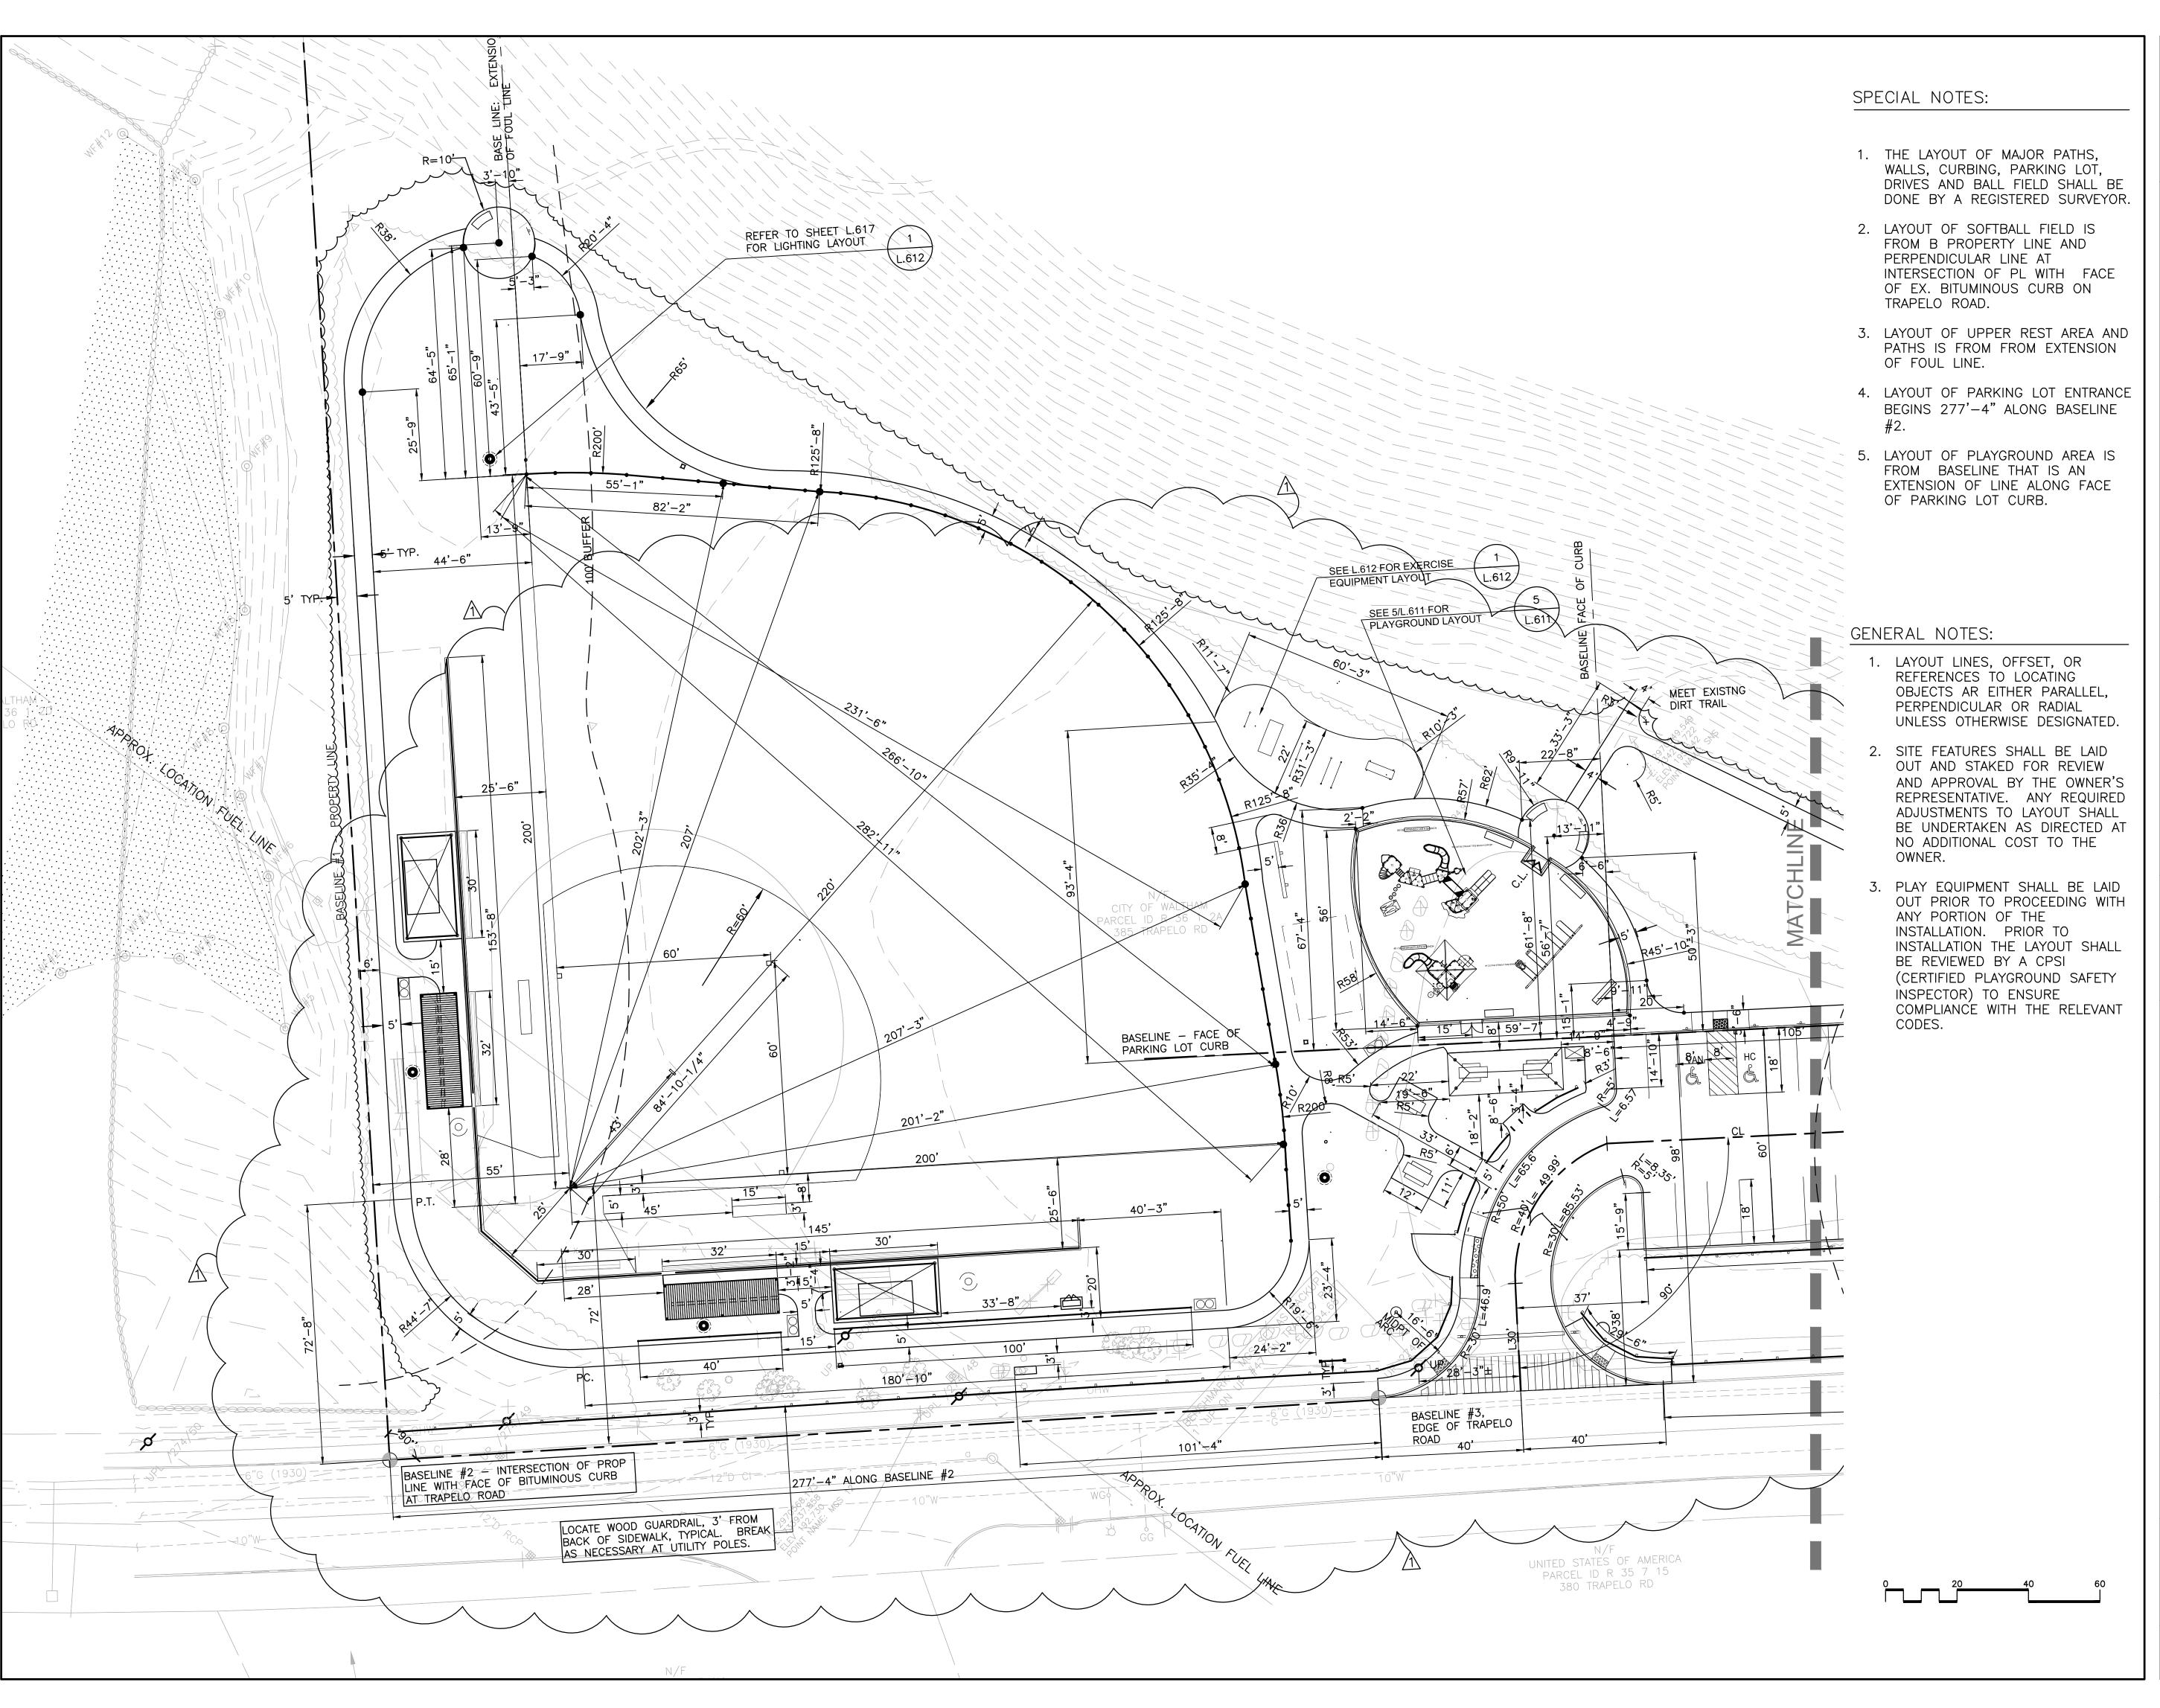

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REVISED ADDENDUM #1 11/20/17
No. Description Date

REVISIONS

North

Project:

CITY OF WALTHAM ELSIE TURNER FIELD 421 TRAPELO ROAD WALTHAM, MA 02452

Prepared For:

CITY OF WALTHAM
DEPARTMENT OF RECREATION
510 MOODY STREET
WALTHAM, MA 02453


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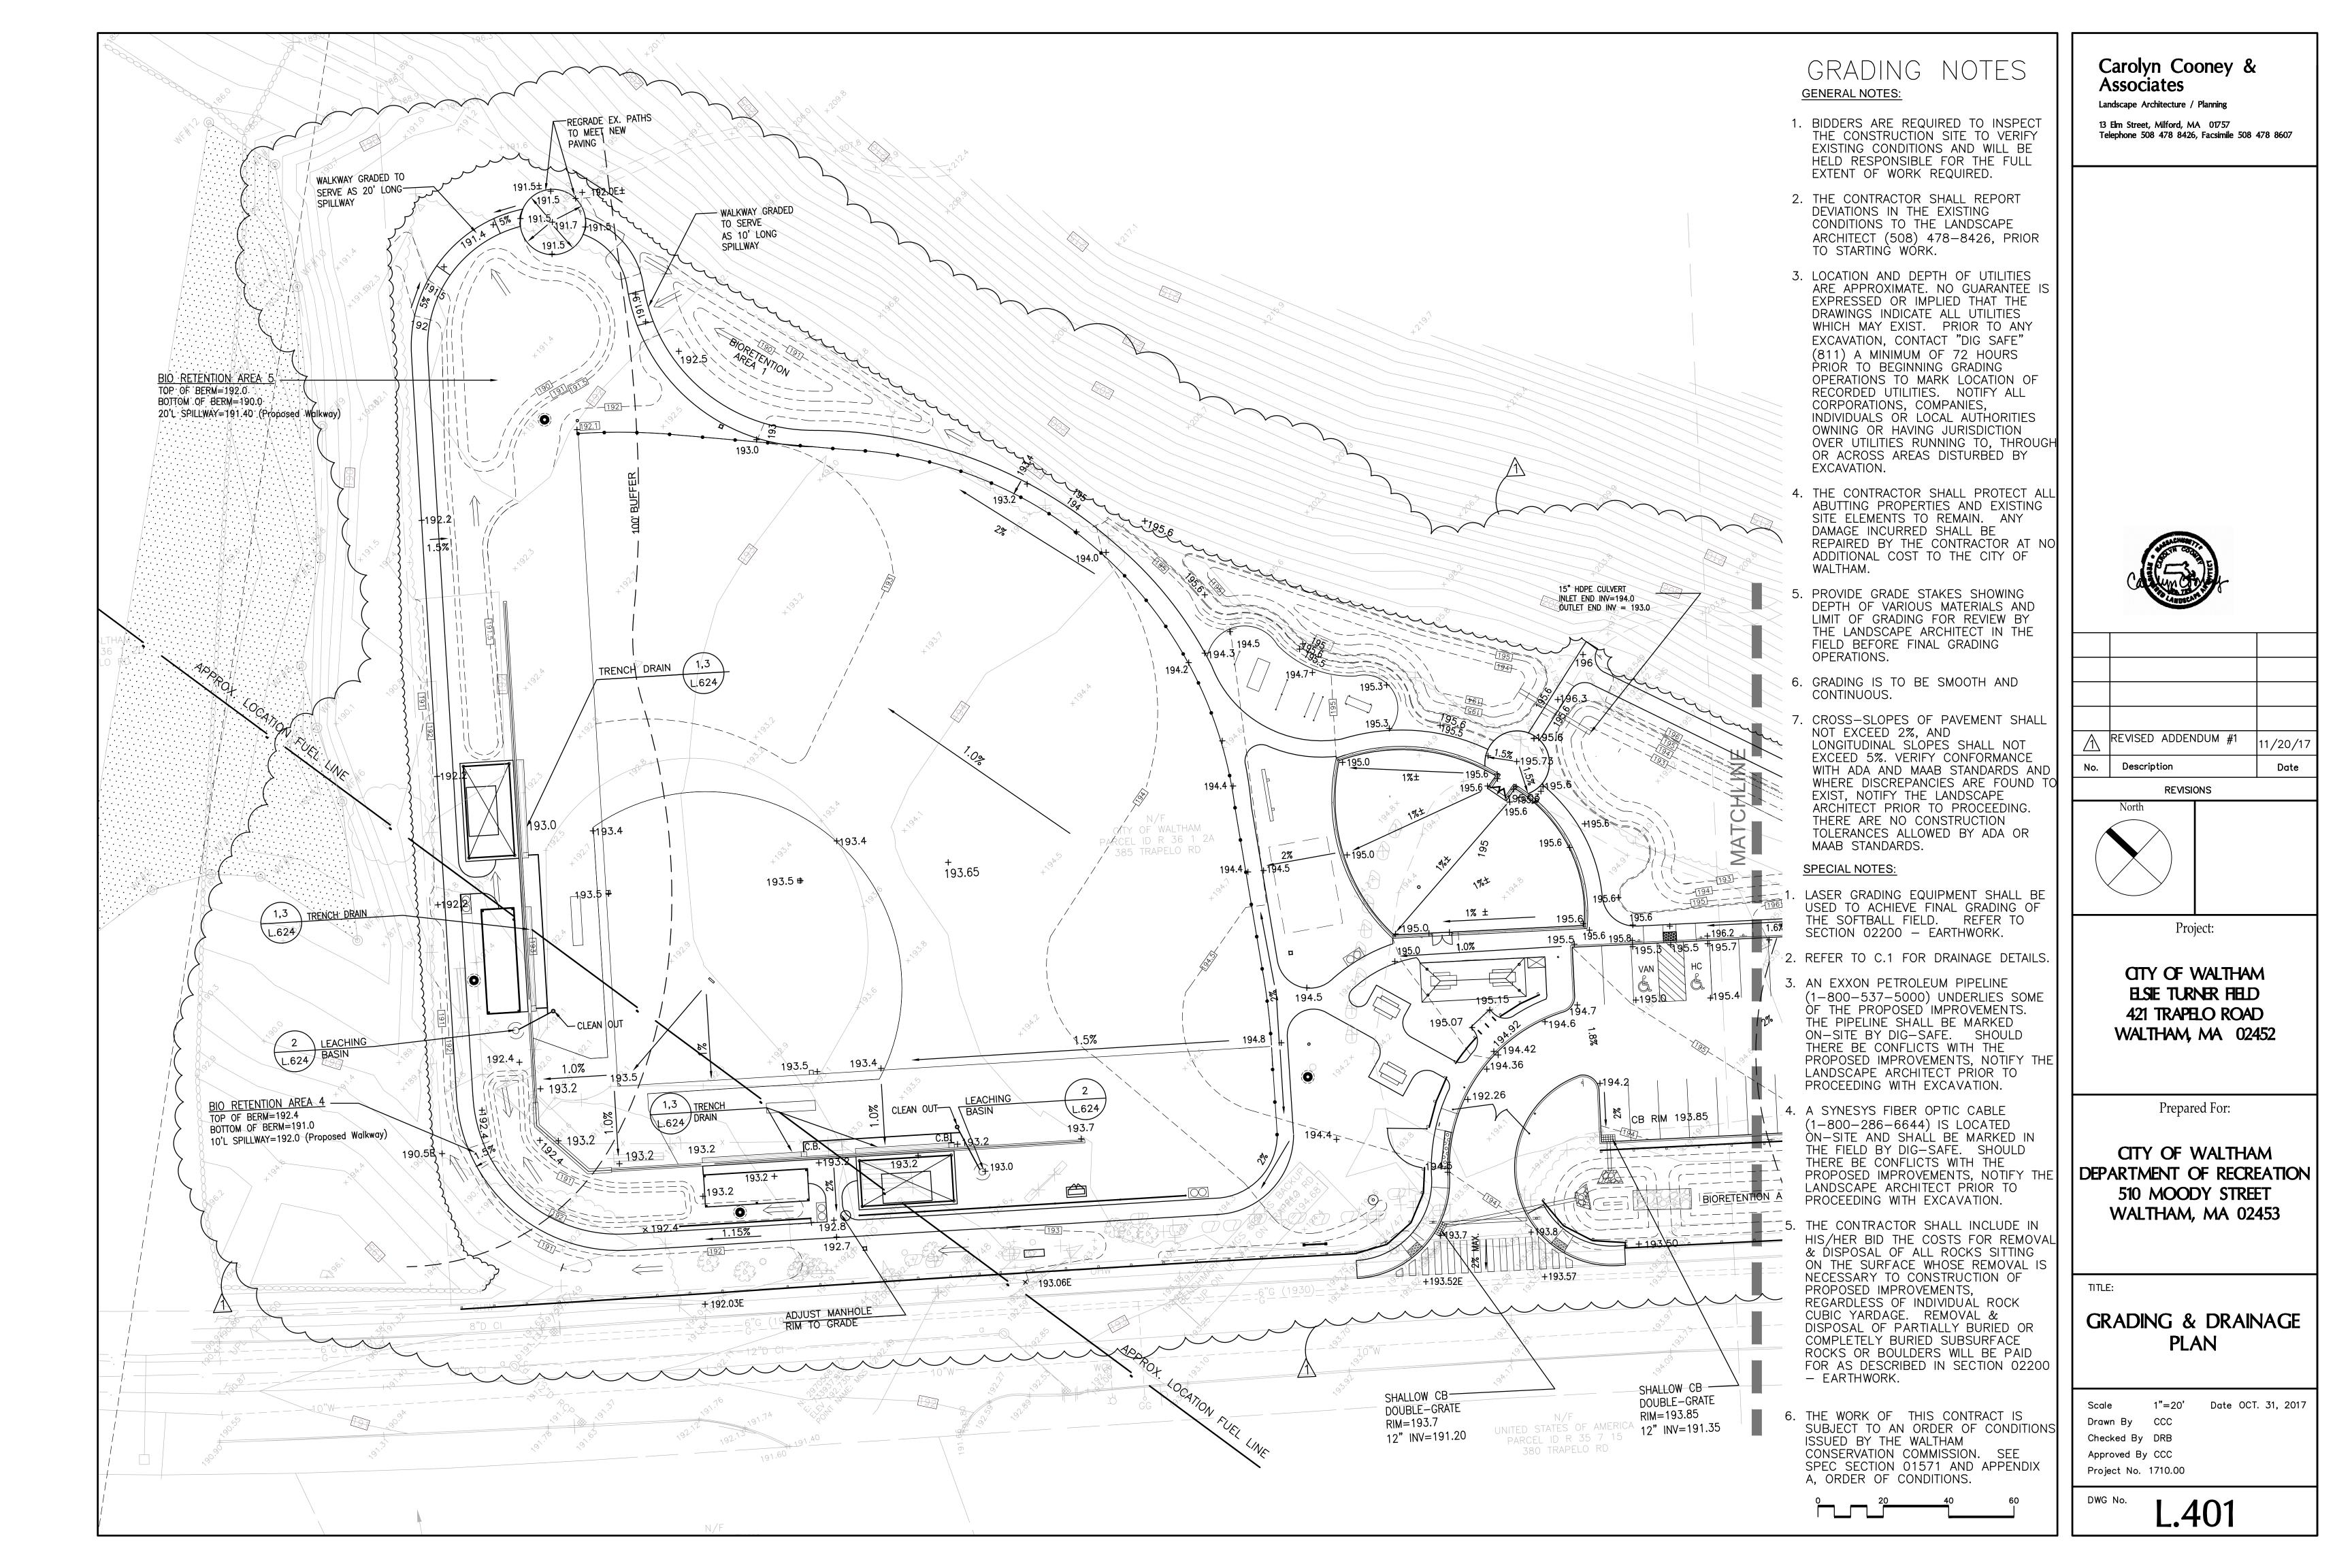
LAYOUT PLAN


Scale 1"=20' Date OCT. 31, 2017
Drawn By CCC
Checked By DRB
Approved By CCC


No.

Project No. 1710.00



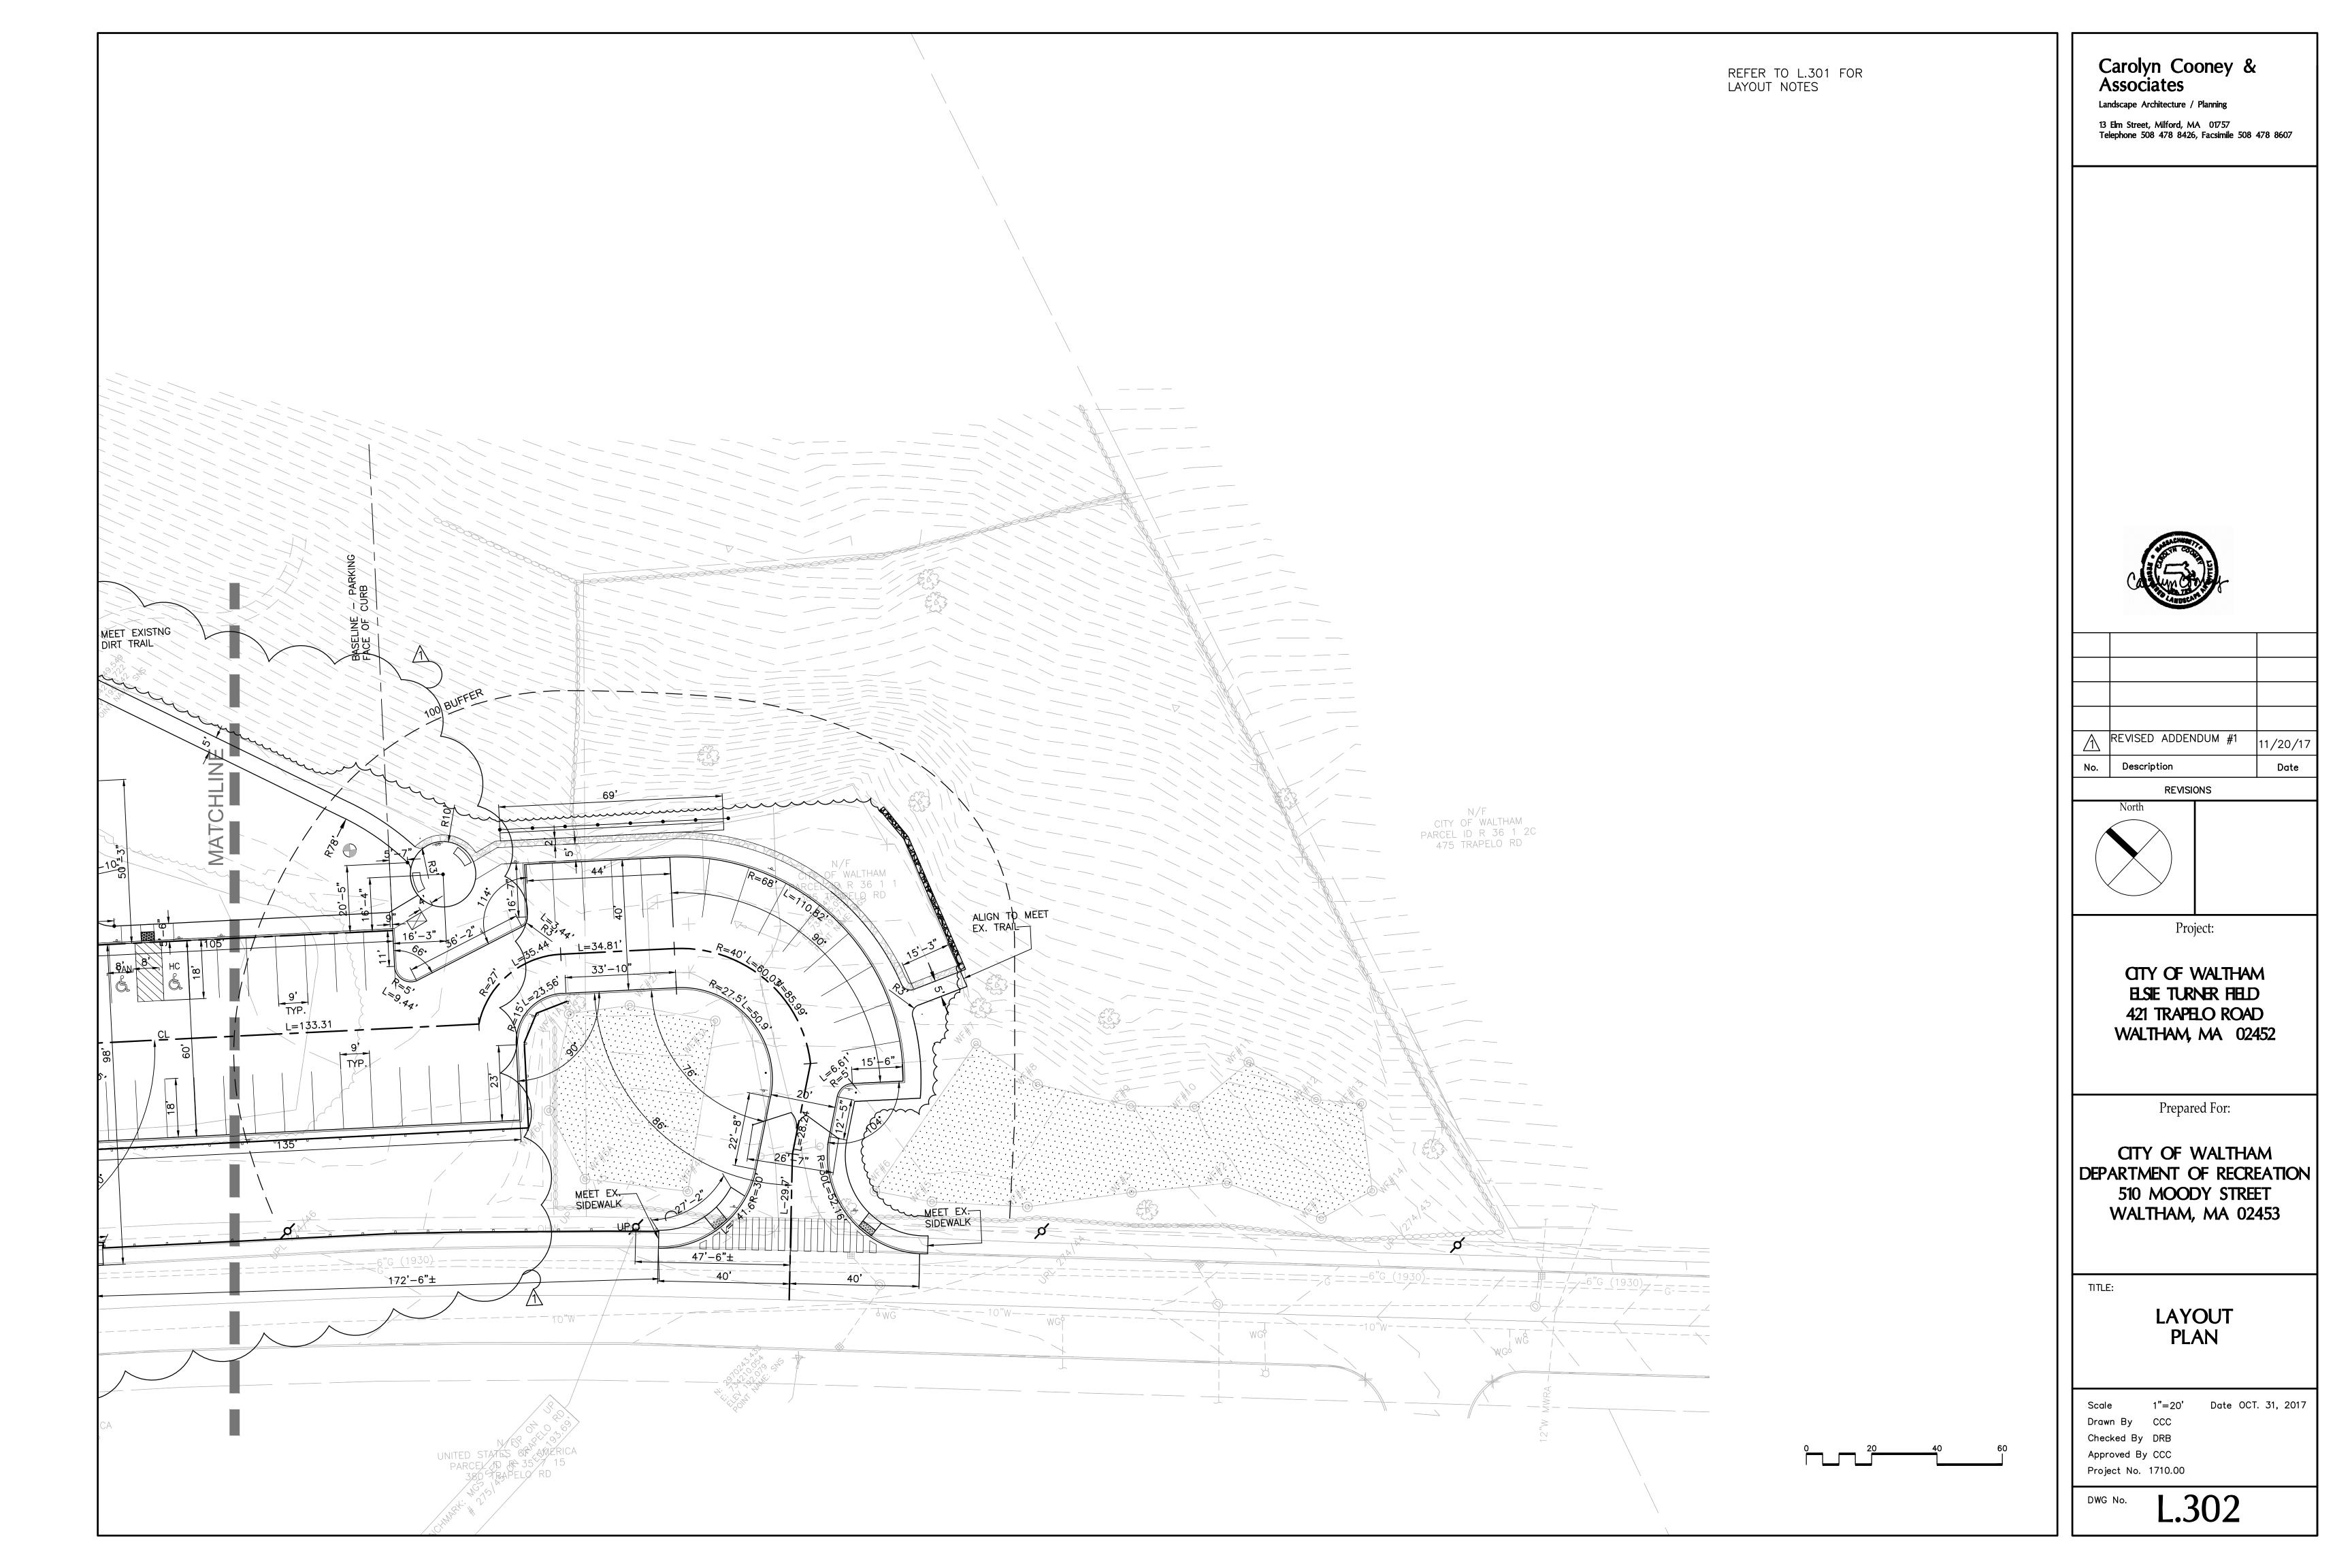

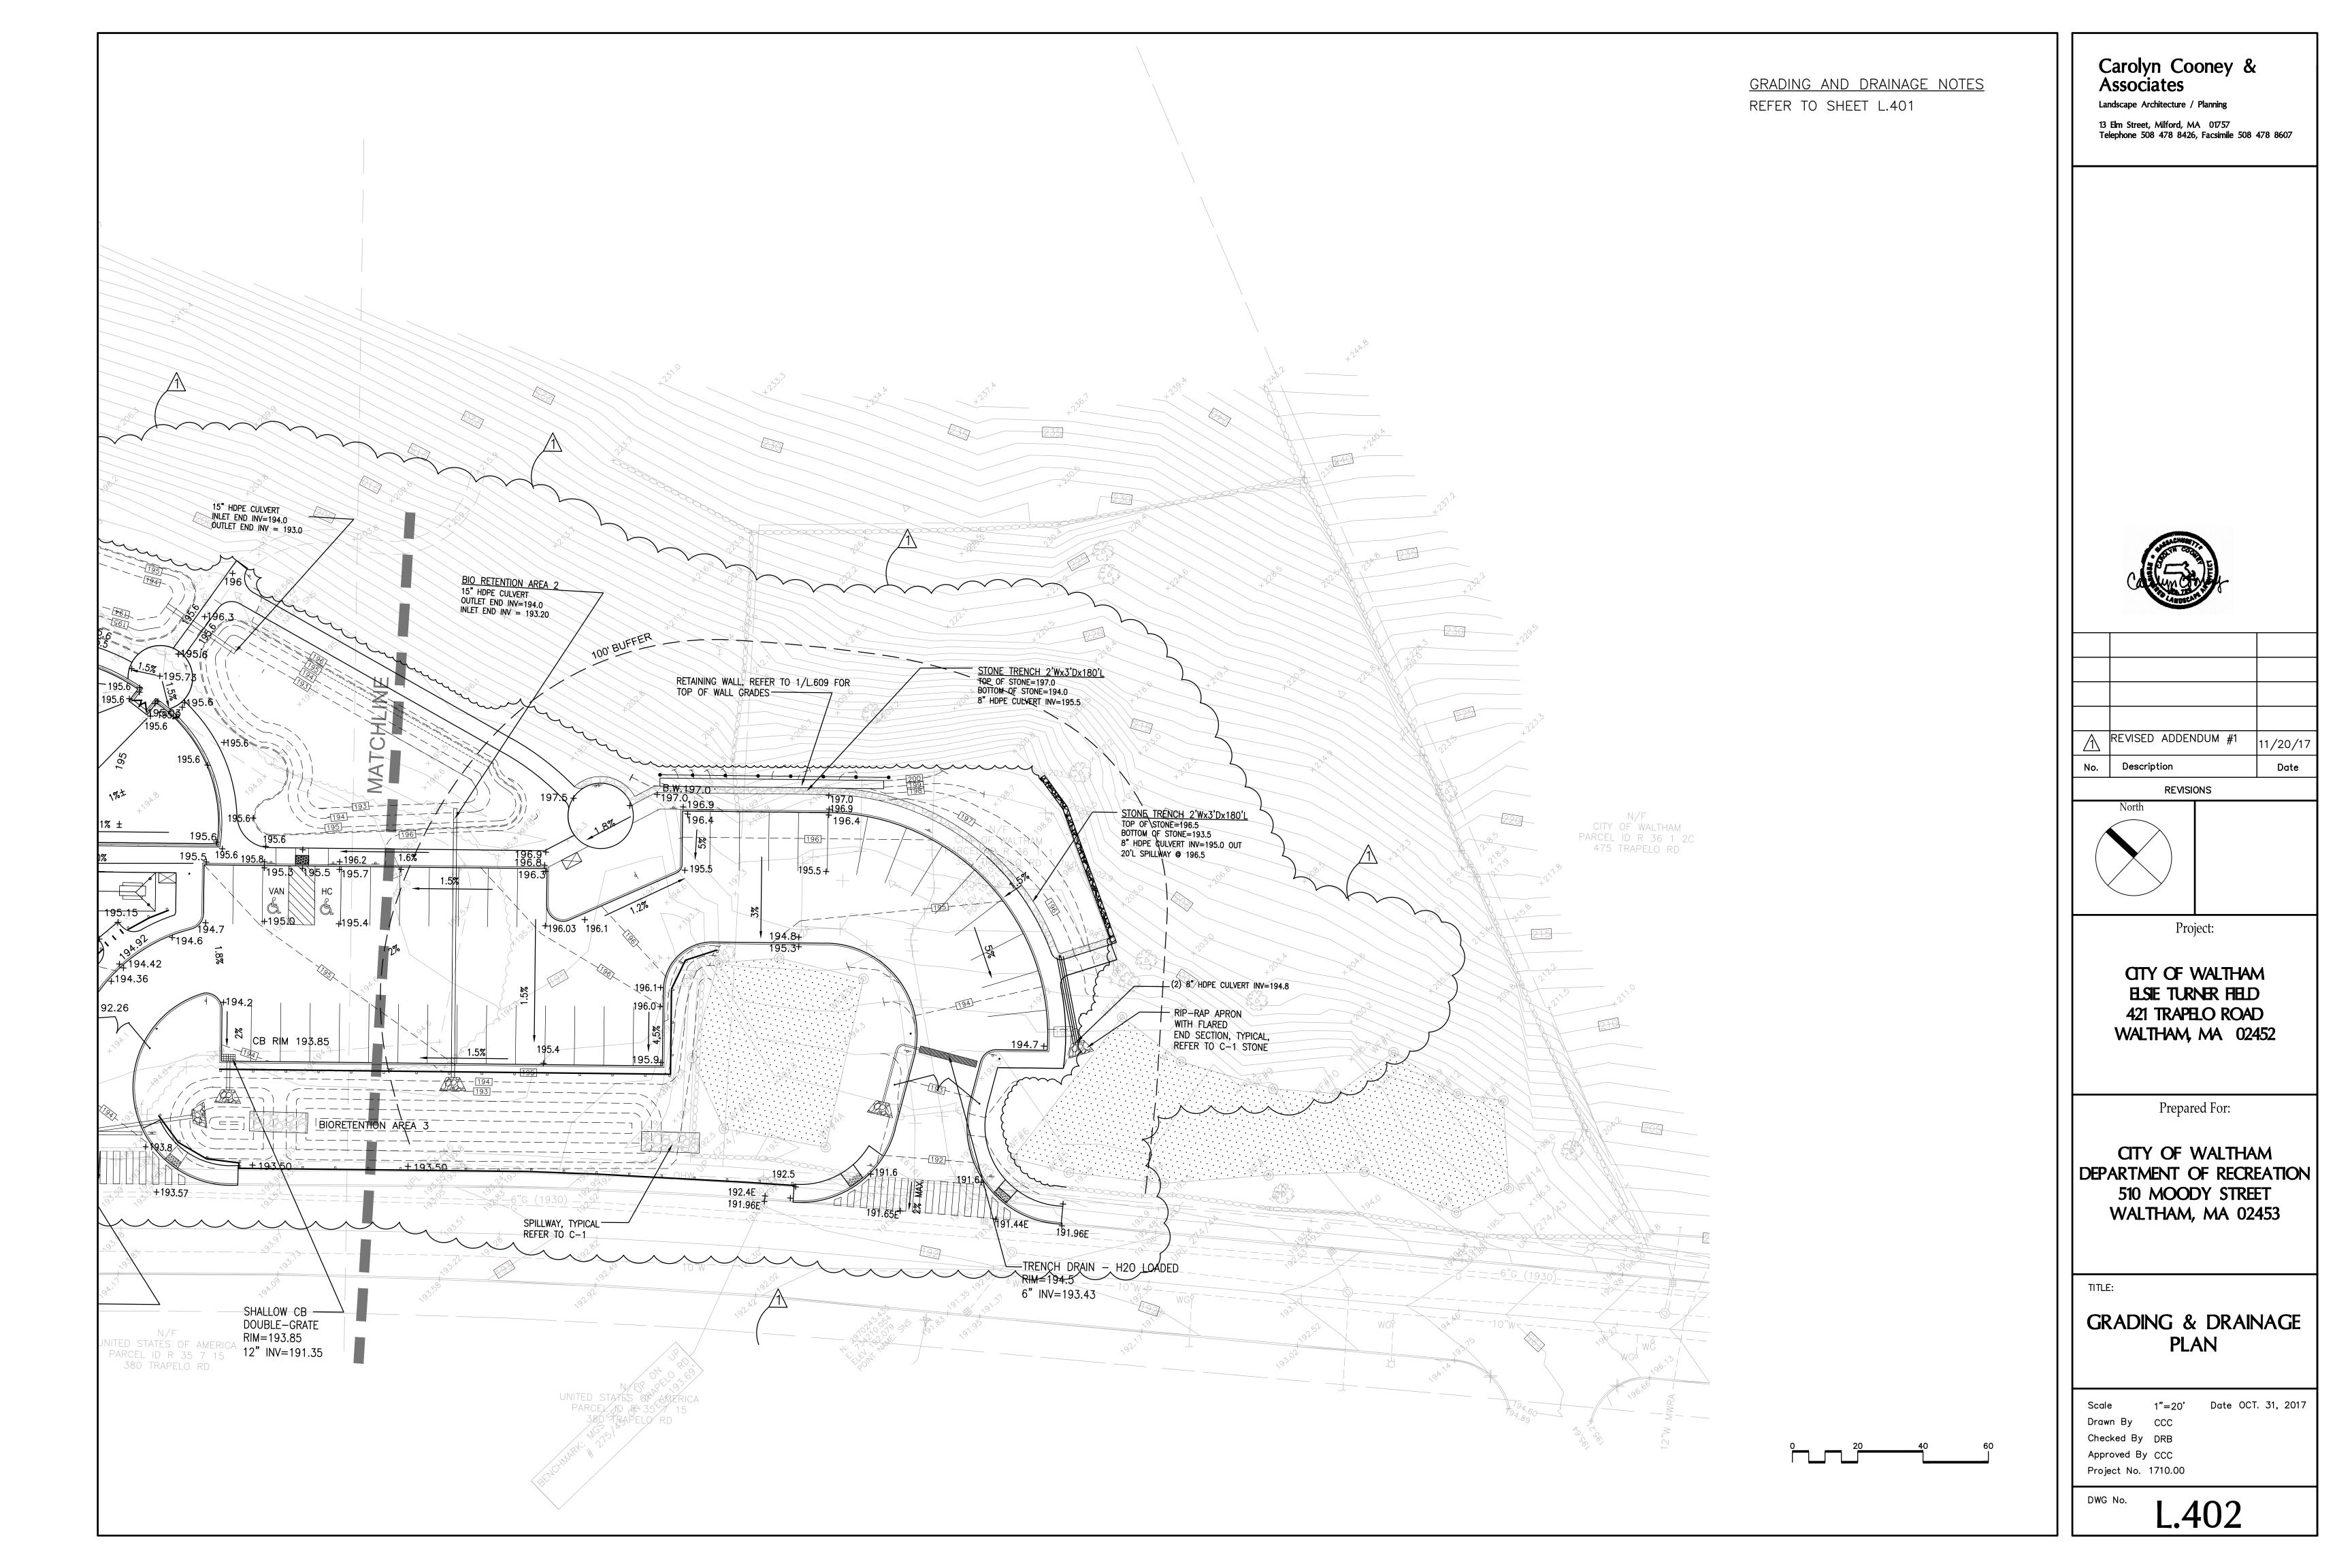

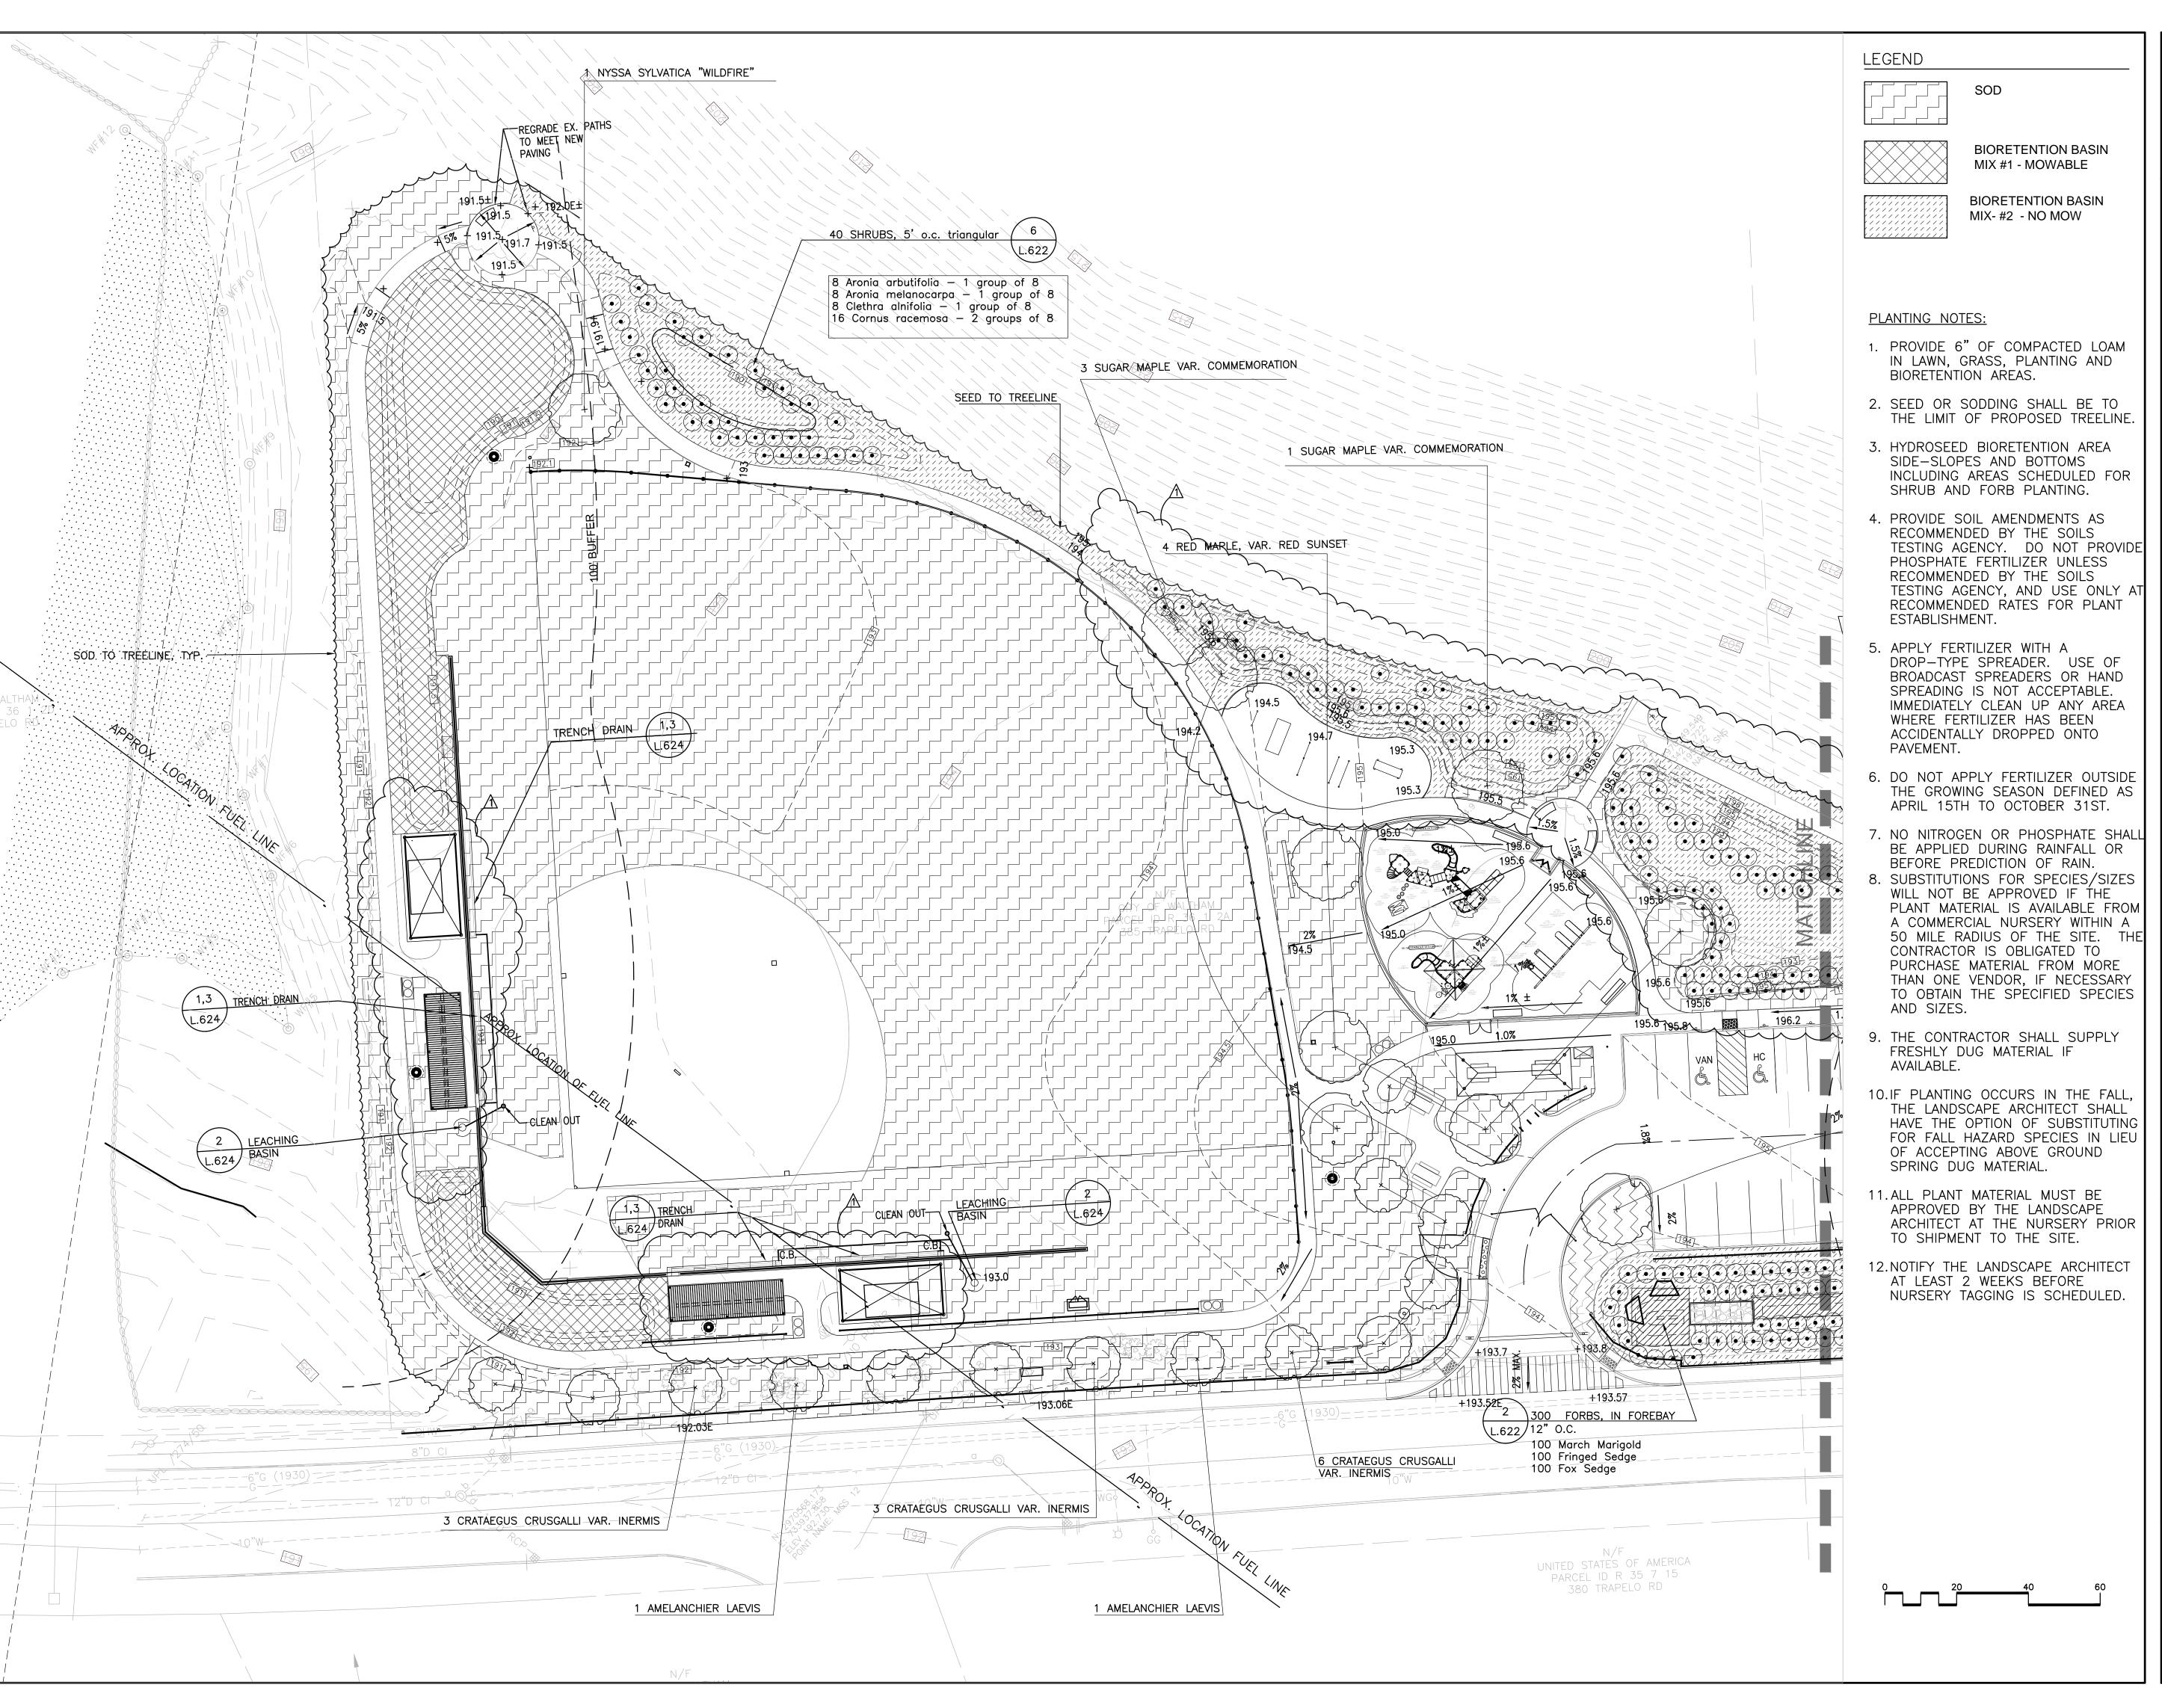


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REVISED ADDENDUM #1 ELEVATIONS 11/20/17 Description

REVISIONS



Project:

CITY OF WALTHAM ELSIE TURNER FIELD 421 TRAPELO ROAD WALTHAM, MA 02452

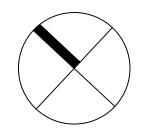Prepared For:


CITY OF WALTHAM DEPARTMENT OF RECREATION 510 MOODY STREET WALTHAM, MA 02453

PLANTING PLAN

1"=20' Date OCT. 31, 2017 Drawn By CCC

Checked By DRB Approved By CCC Project No. 1710.00

DWG No.

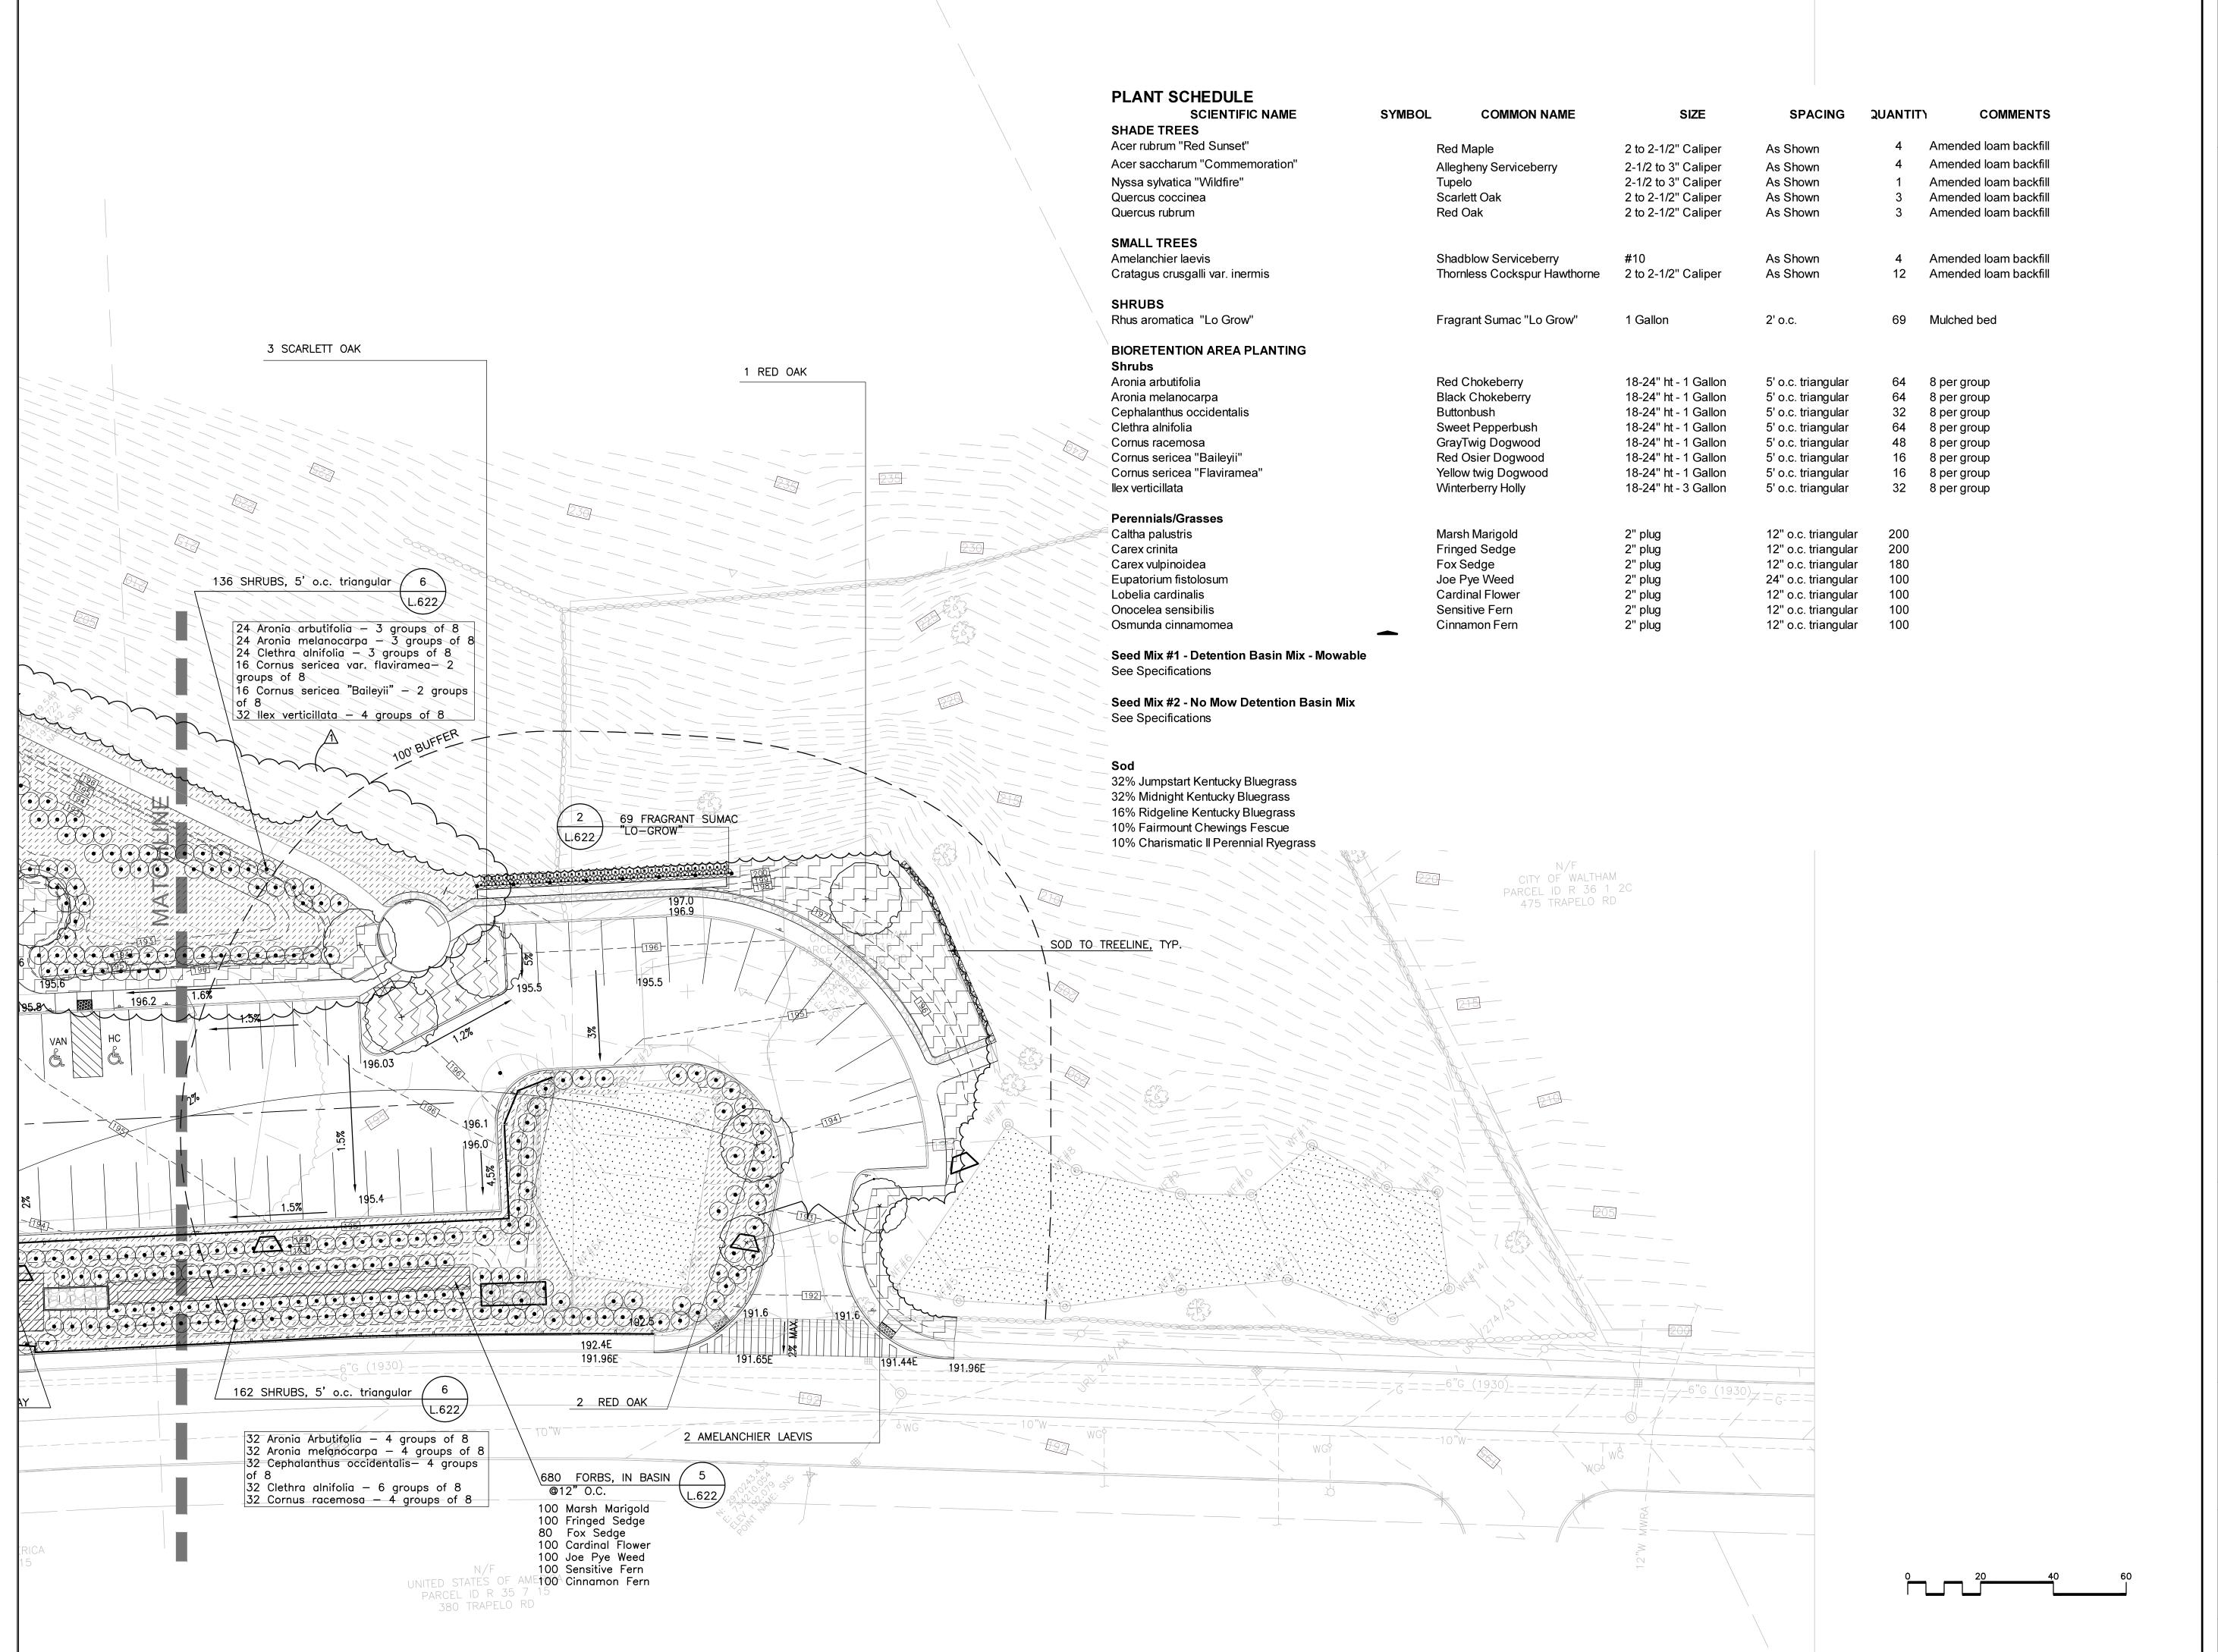

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REVISIONS

11/20/17

REVISED ADDENDUM #1 ELEVATIONS

Description

Project:

CITY OF WALTHAM ELSIE TURNER FIELD 421 TRAPELO ROAD WALTHAM, MA 02452

Prepared For:

CITY OF WALTHAM
DEPARTMENT OF RECREATION
510 MOODY STREET
WALTHAM, MA 02453

TITLE


PLANTING PLAN


Scale 1"=20' Date OCT. 31, 2017

Drawn By CCC

Checked By DRB
Approved By CCC
Project No. 1710.00

No. I FO

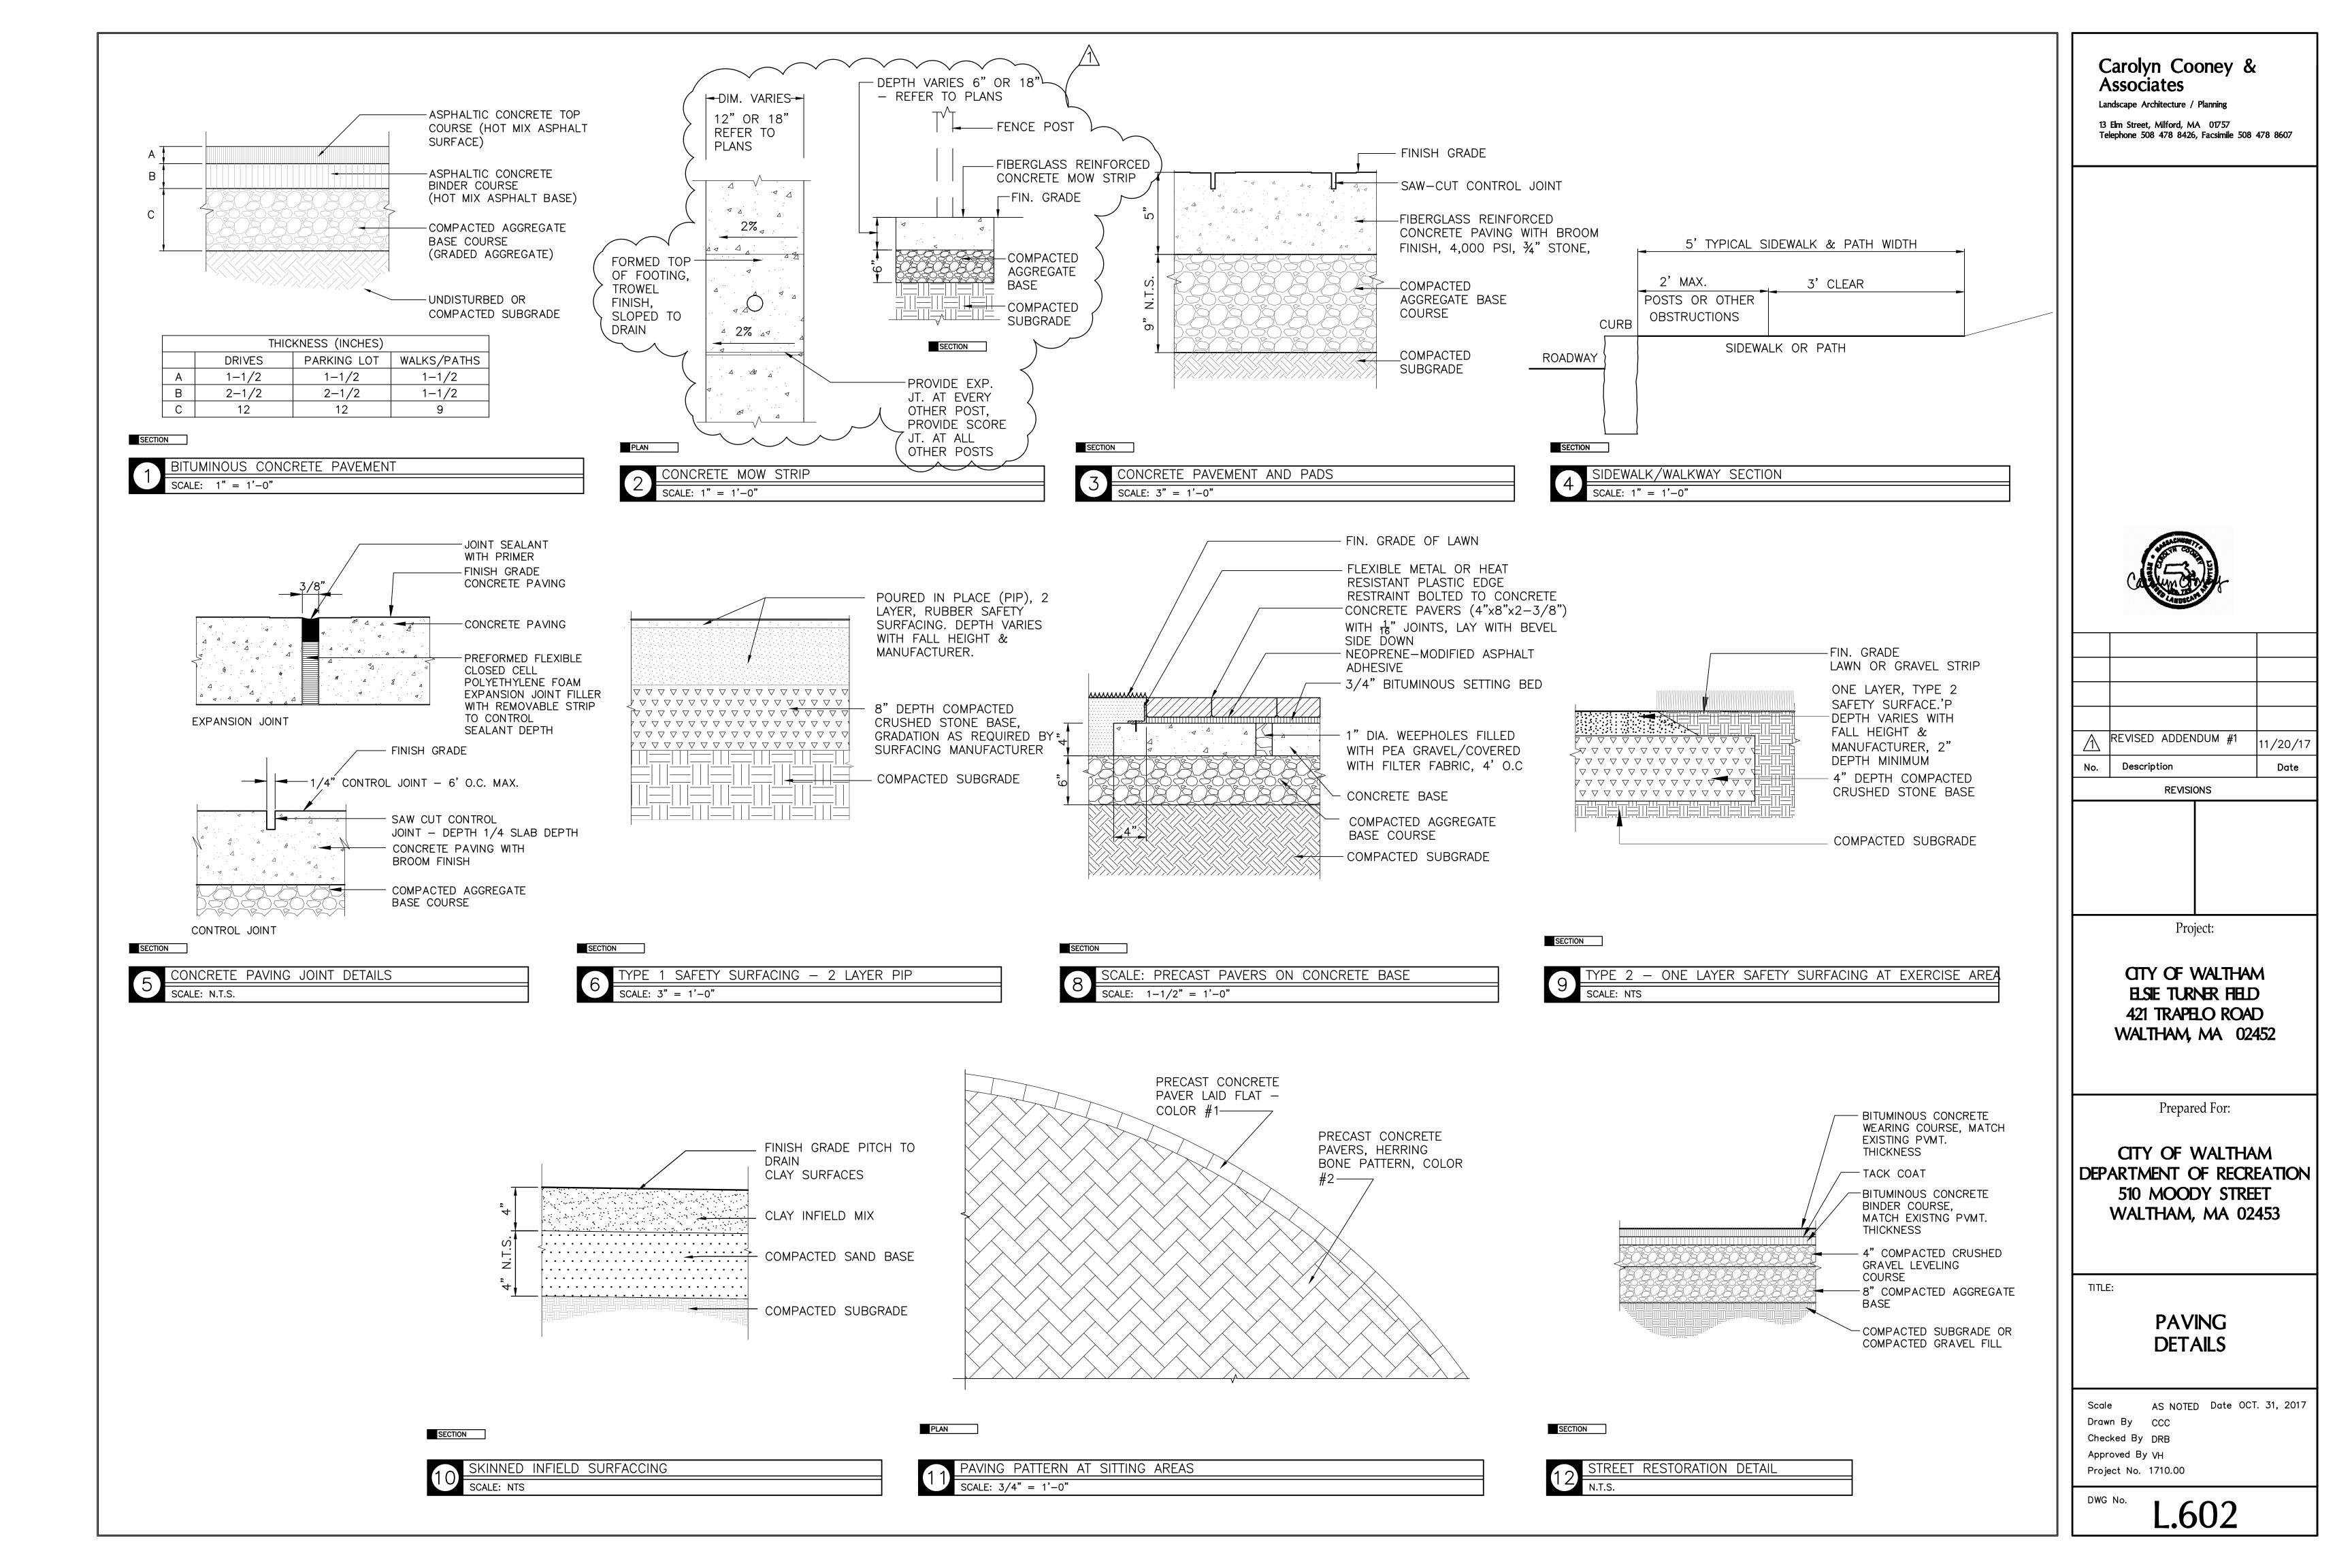

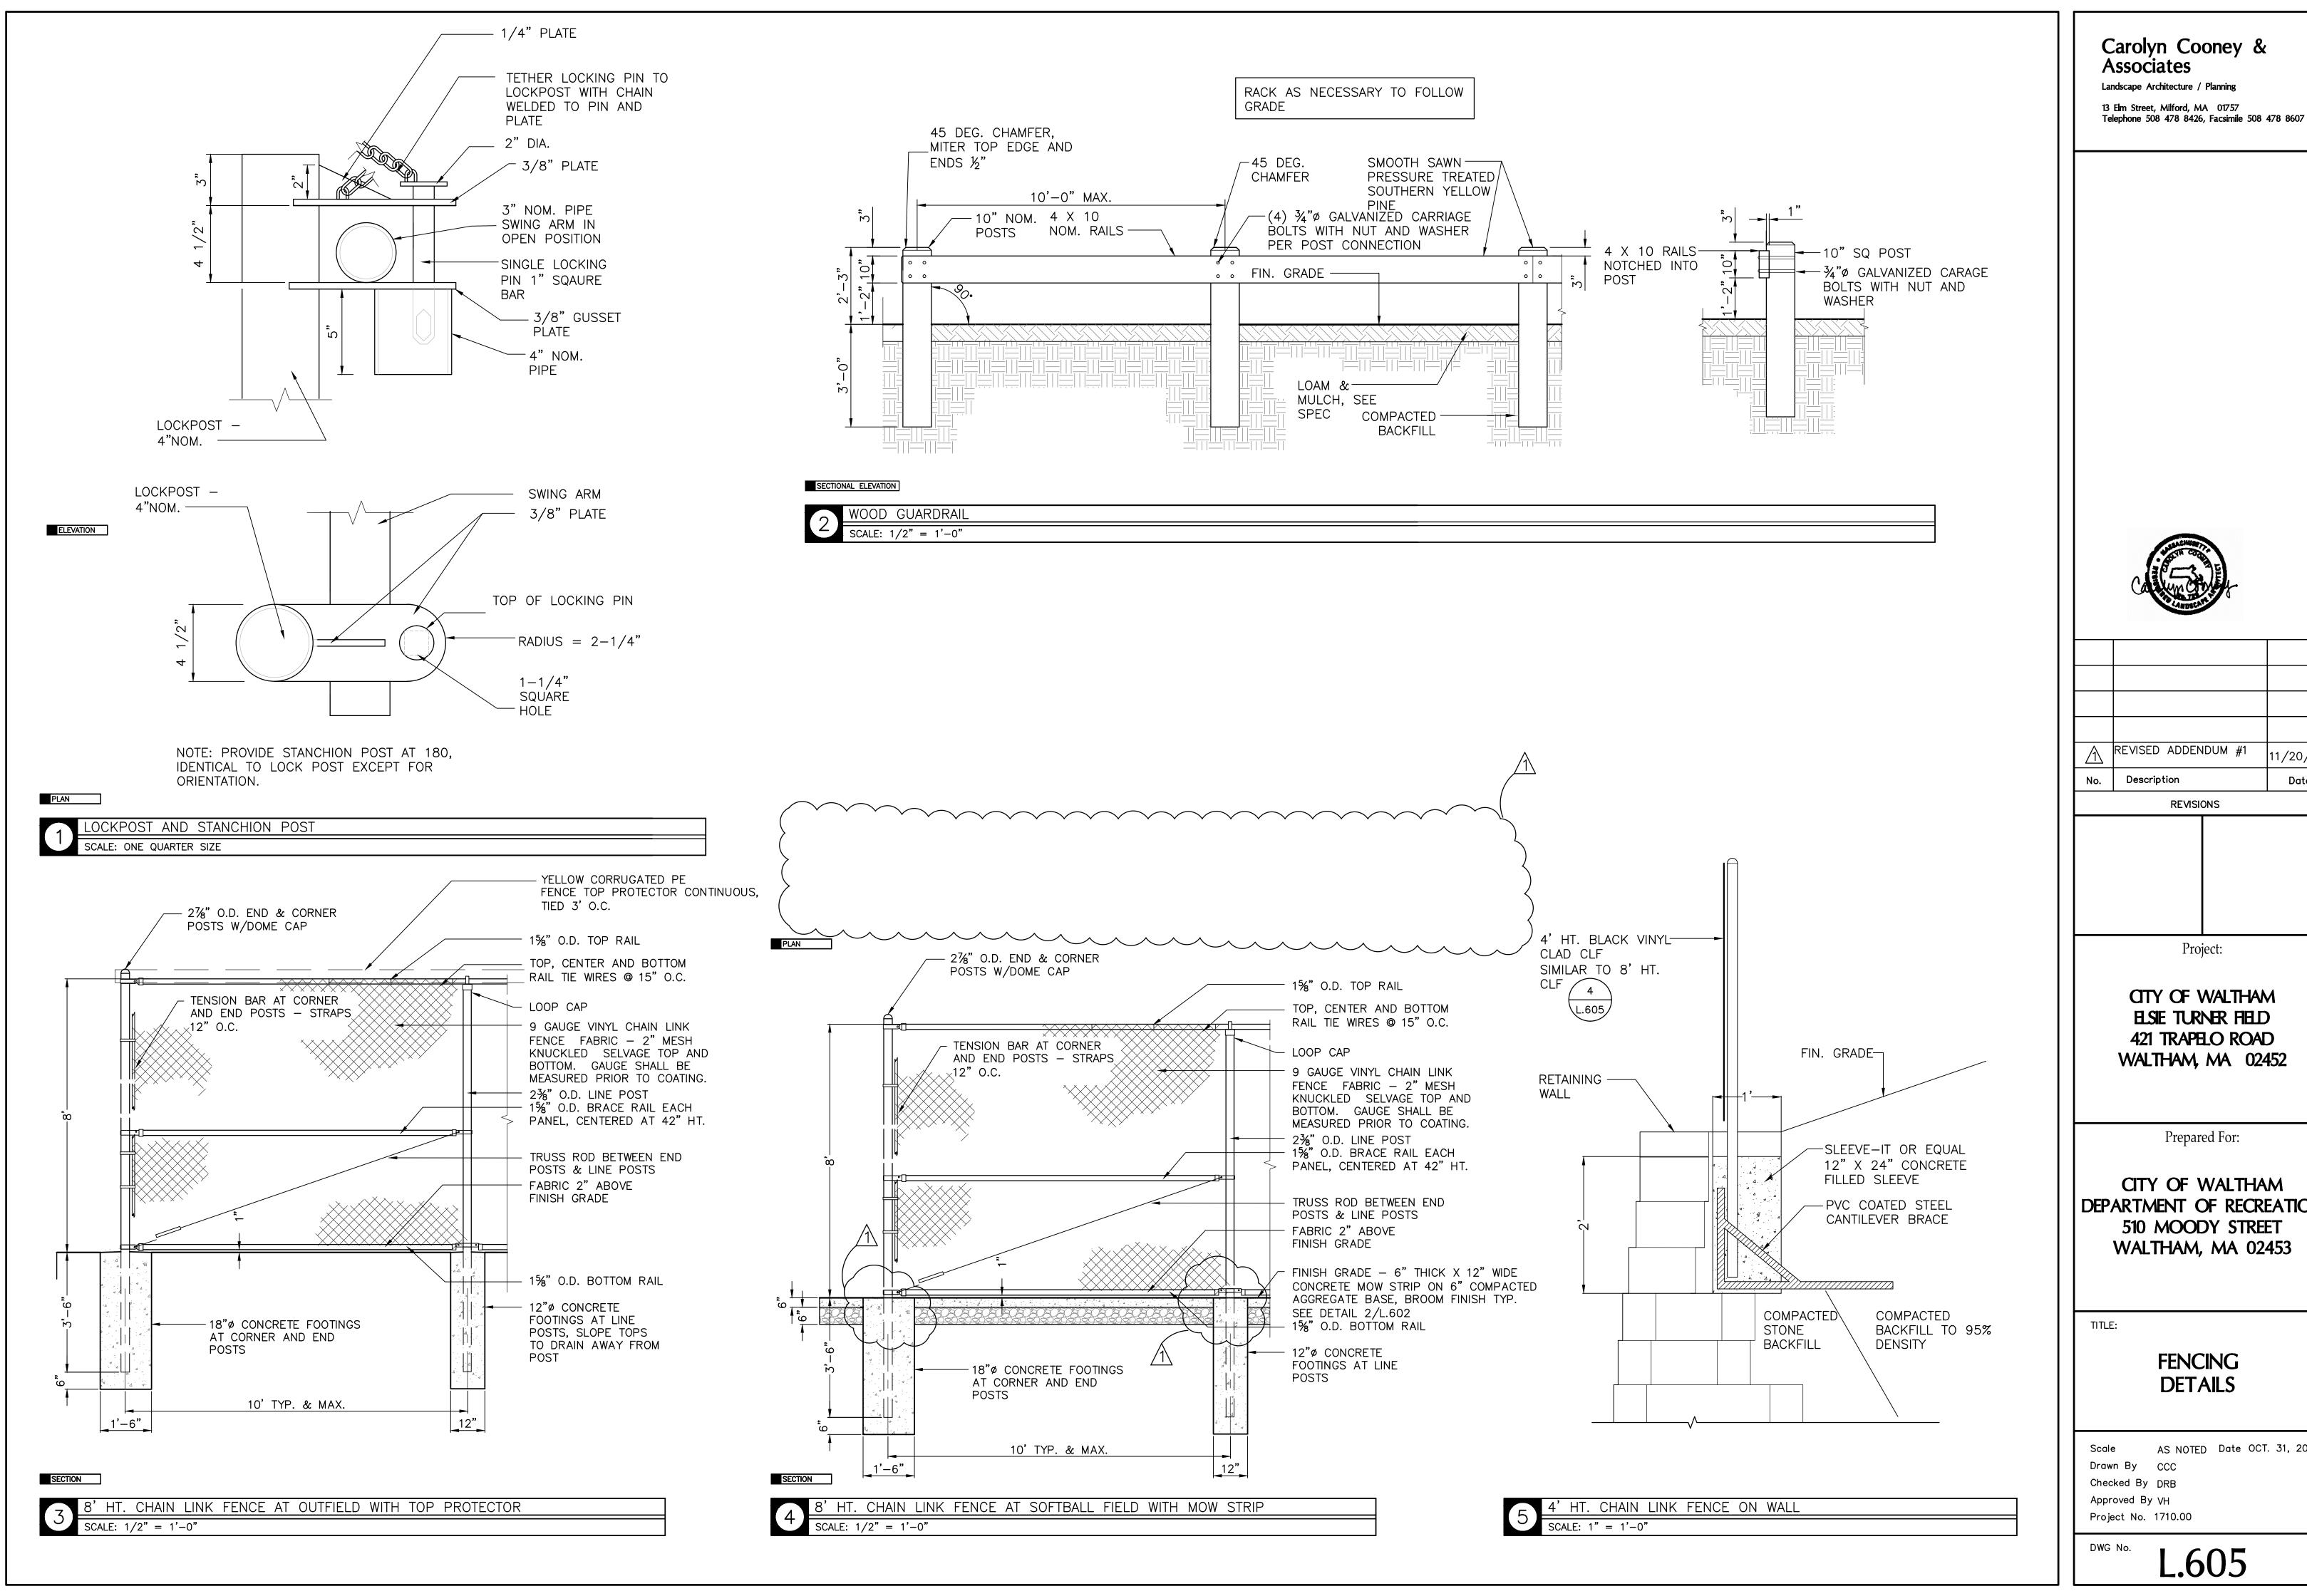

Carolyn Cooney &

13 Elm Street, Milford, MA 01757

REVISED ADDENDUM #1 11/20/17 REVISIONS


CITY OF WALTHAM ELSIE TURNER FIELD 421 TRAPELO ROAD WALTHAM, MA 02452

Prepared For:


CITY OF WALTHAM | DEPARTMENT OF RECREATION | 510 MOODY STREET WALTHAM, MA 02453


> **FENCING DETAILS**

AS NOTED Date OCT. 31, 2017

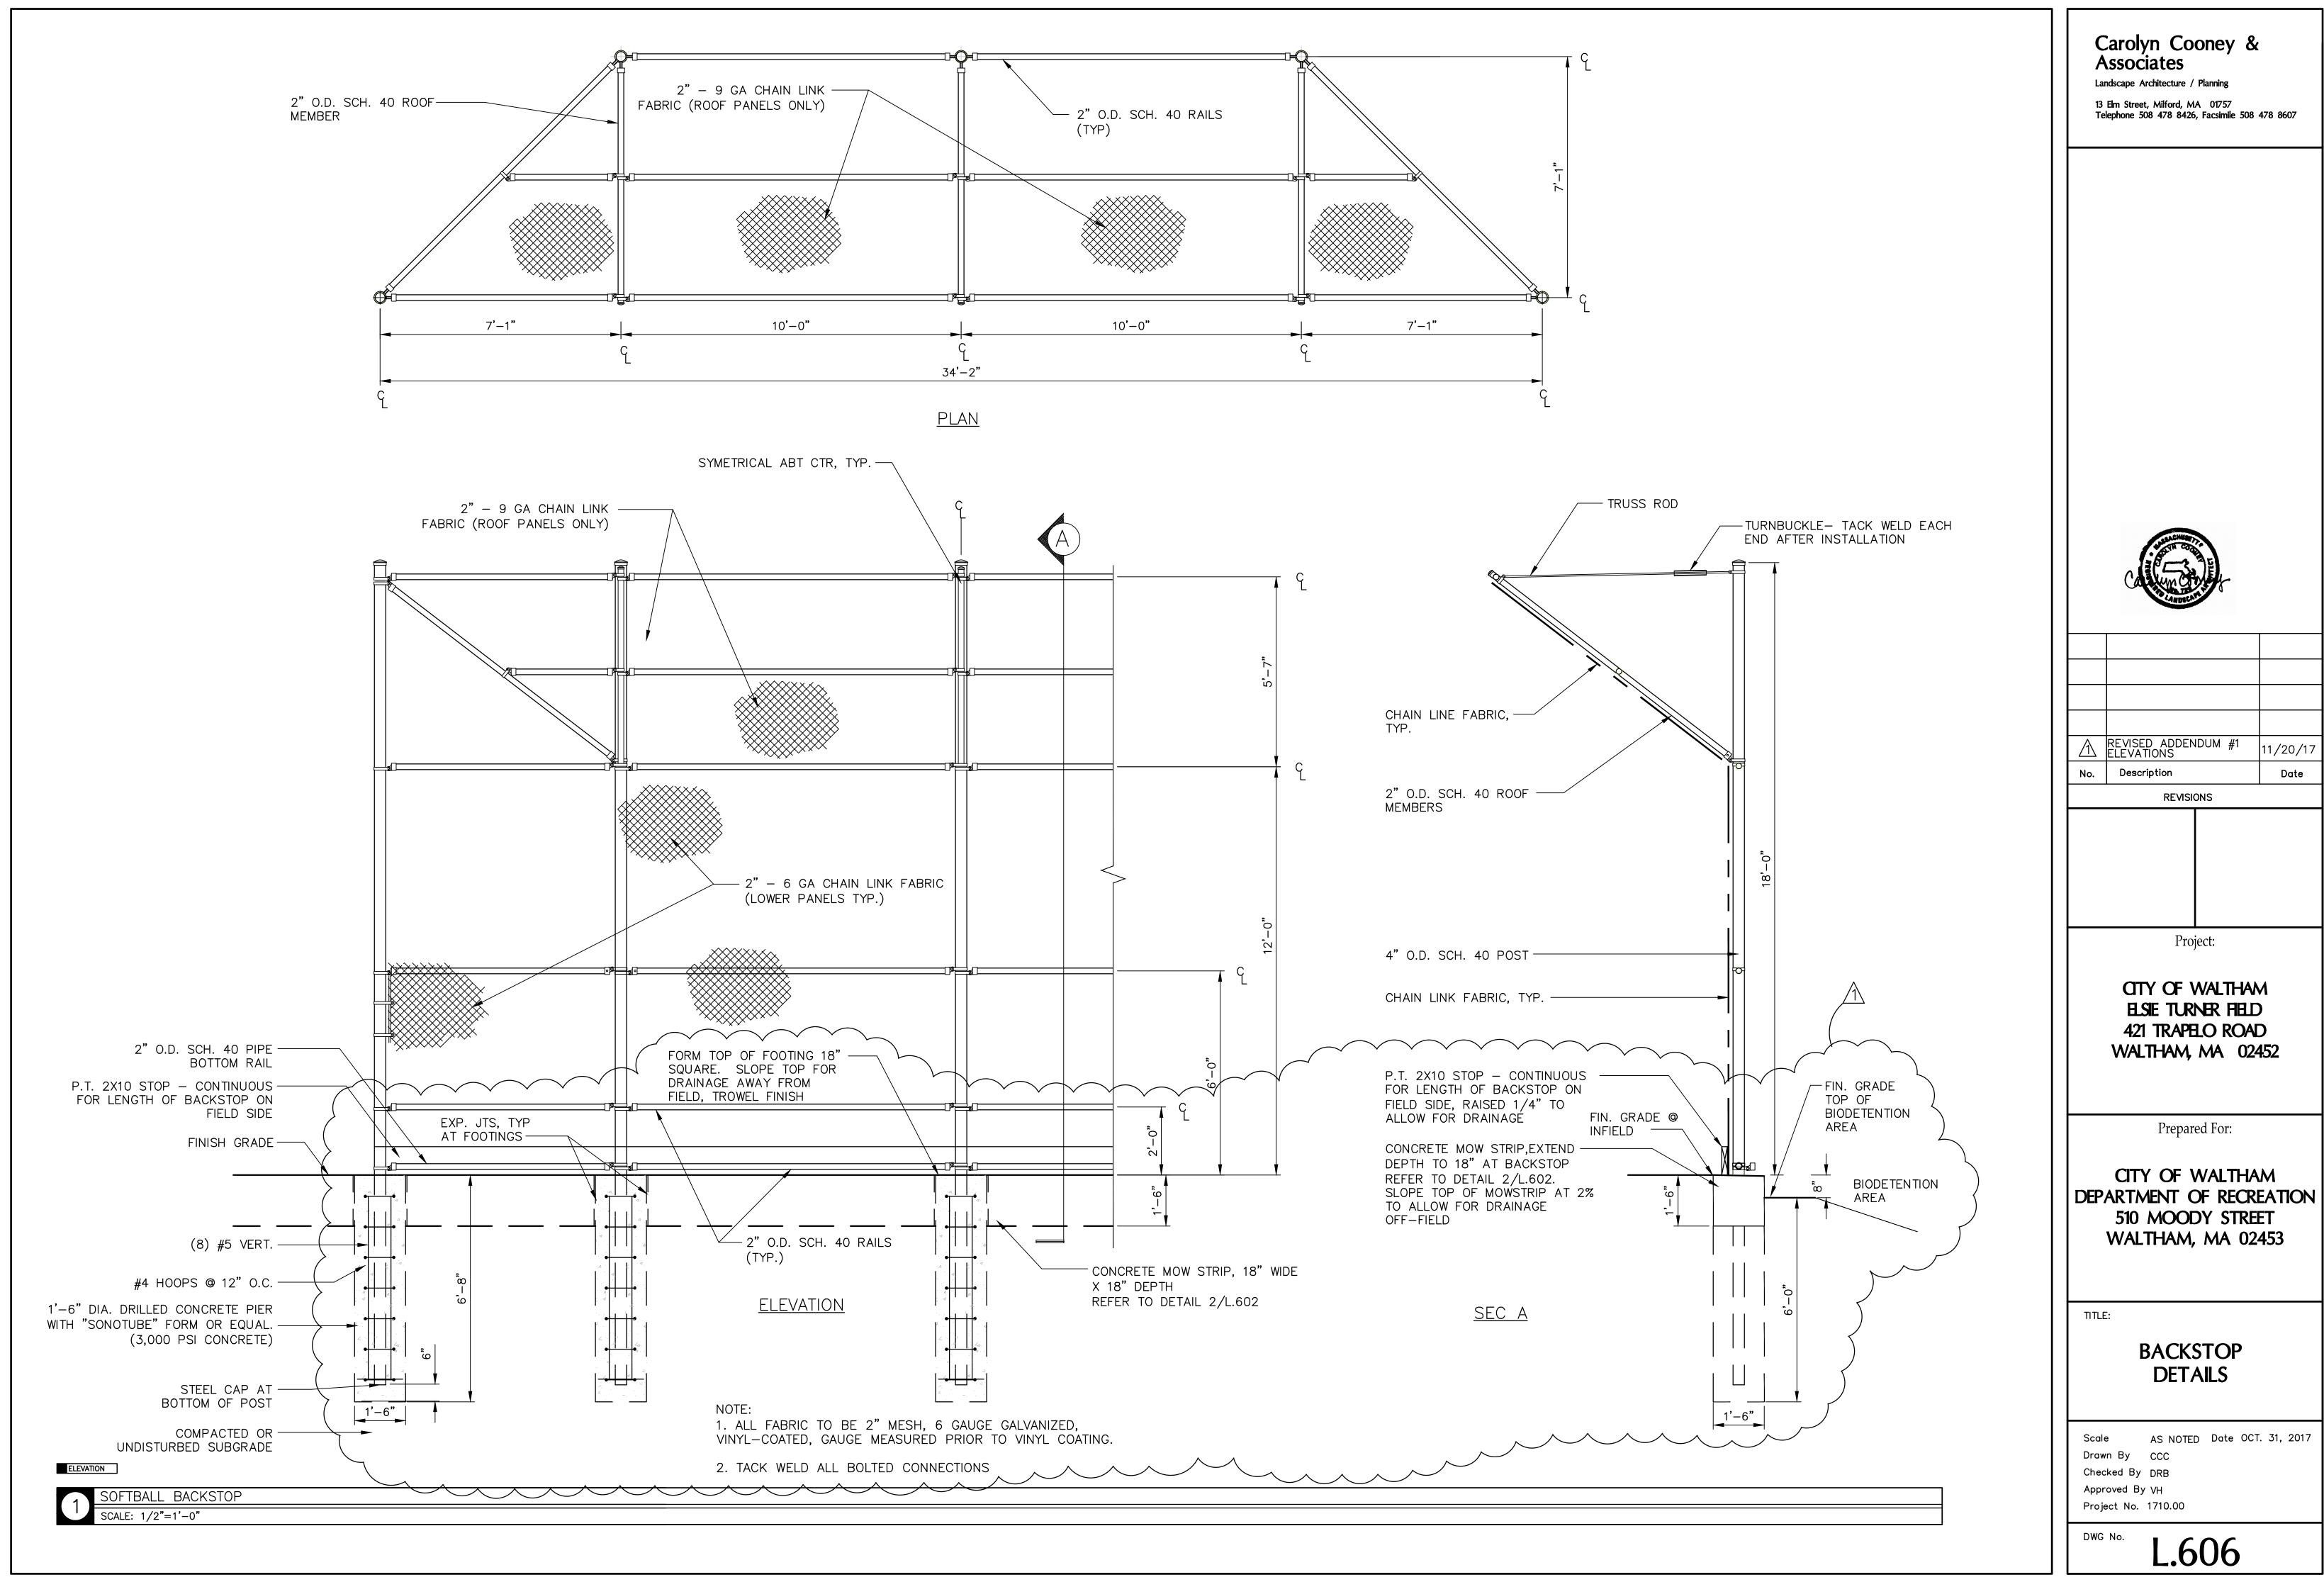

11/20/17

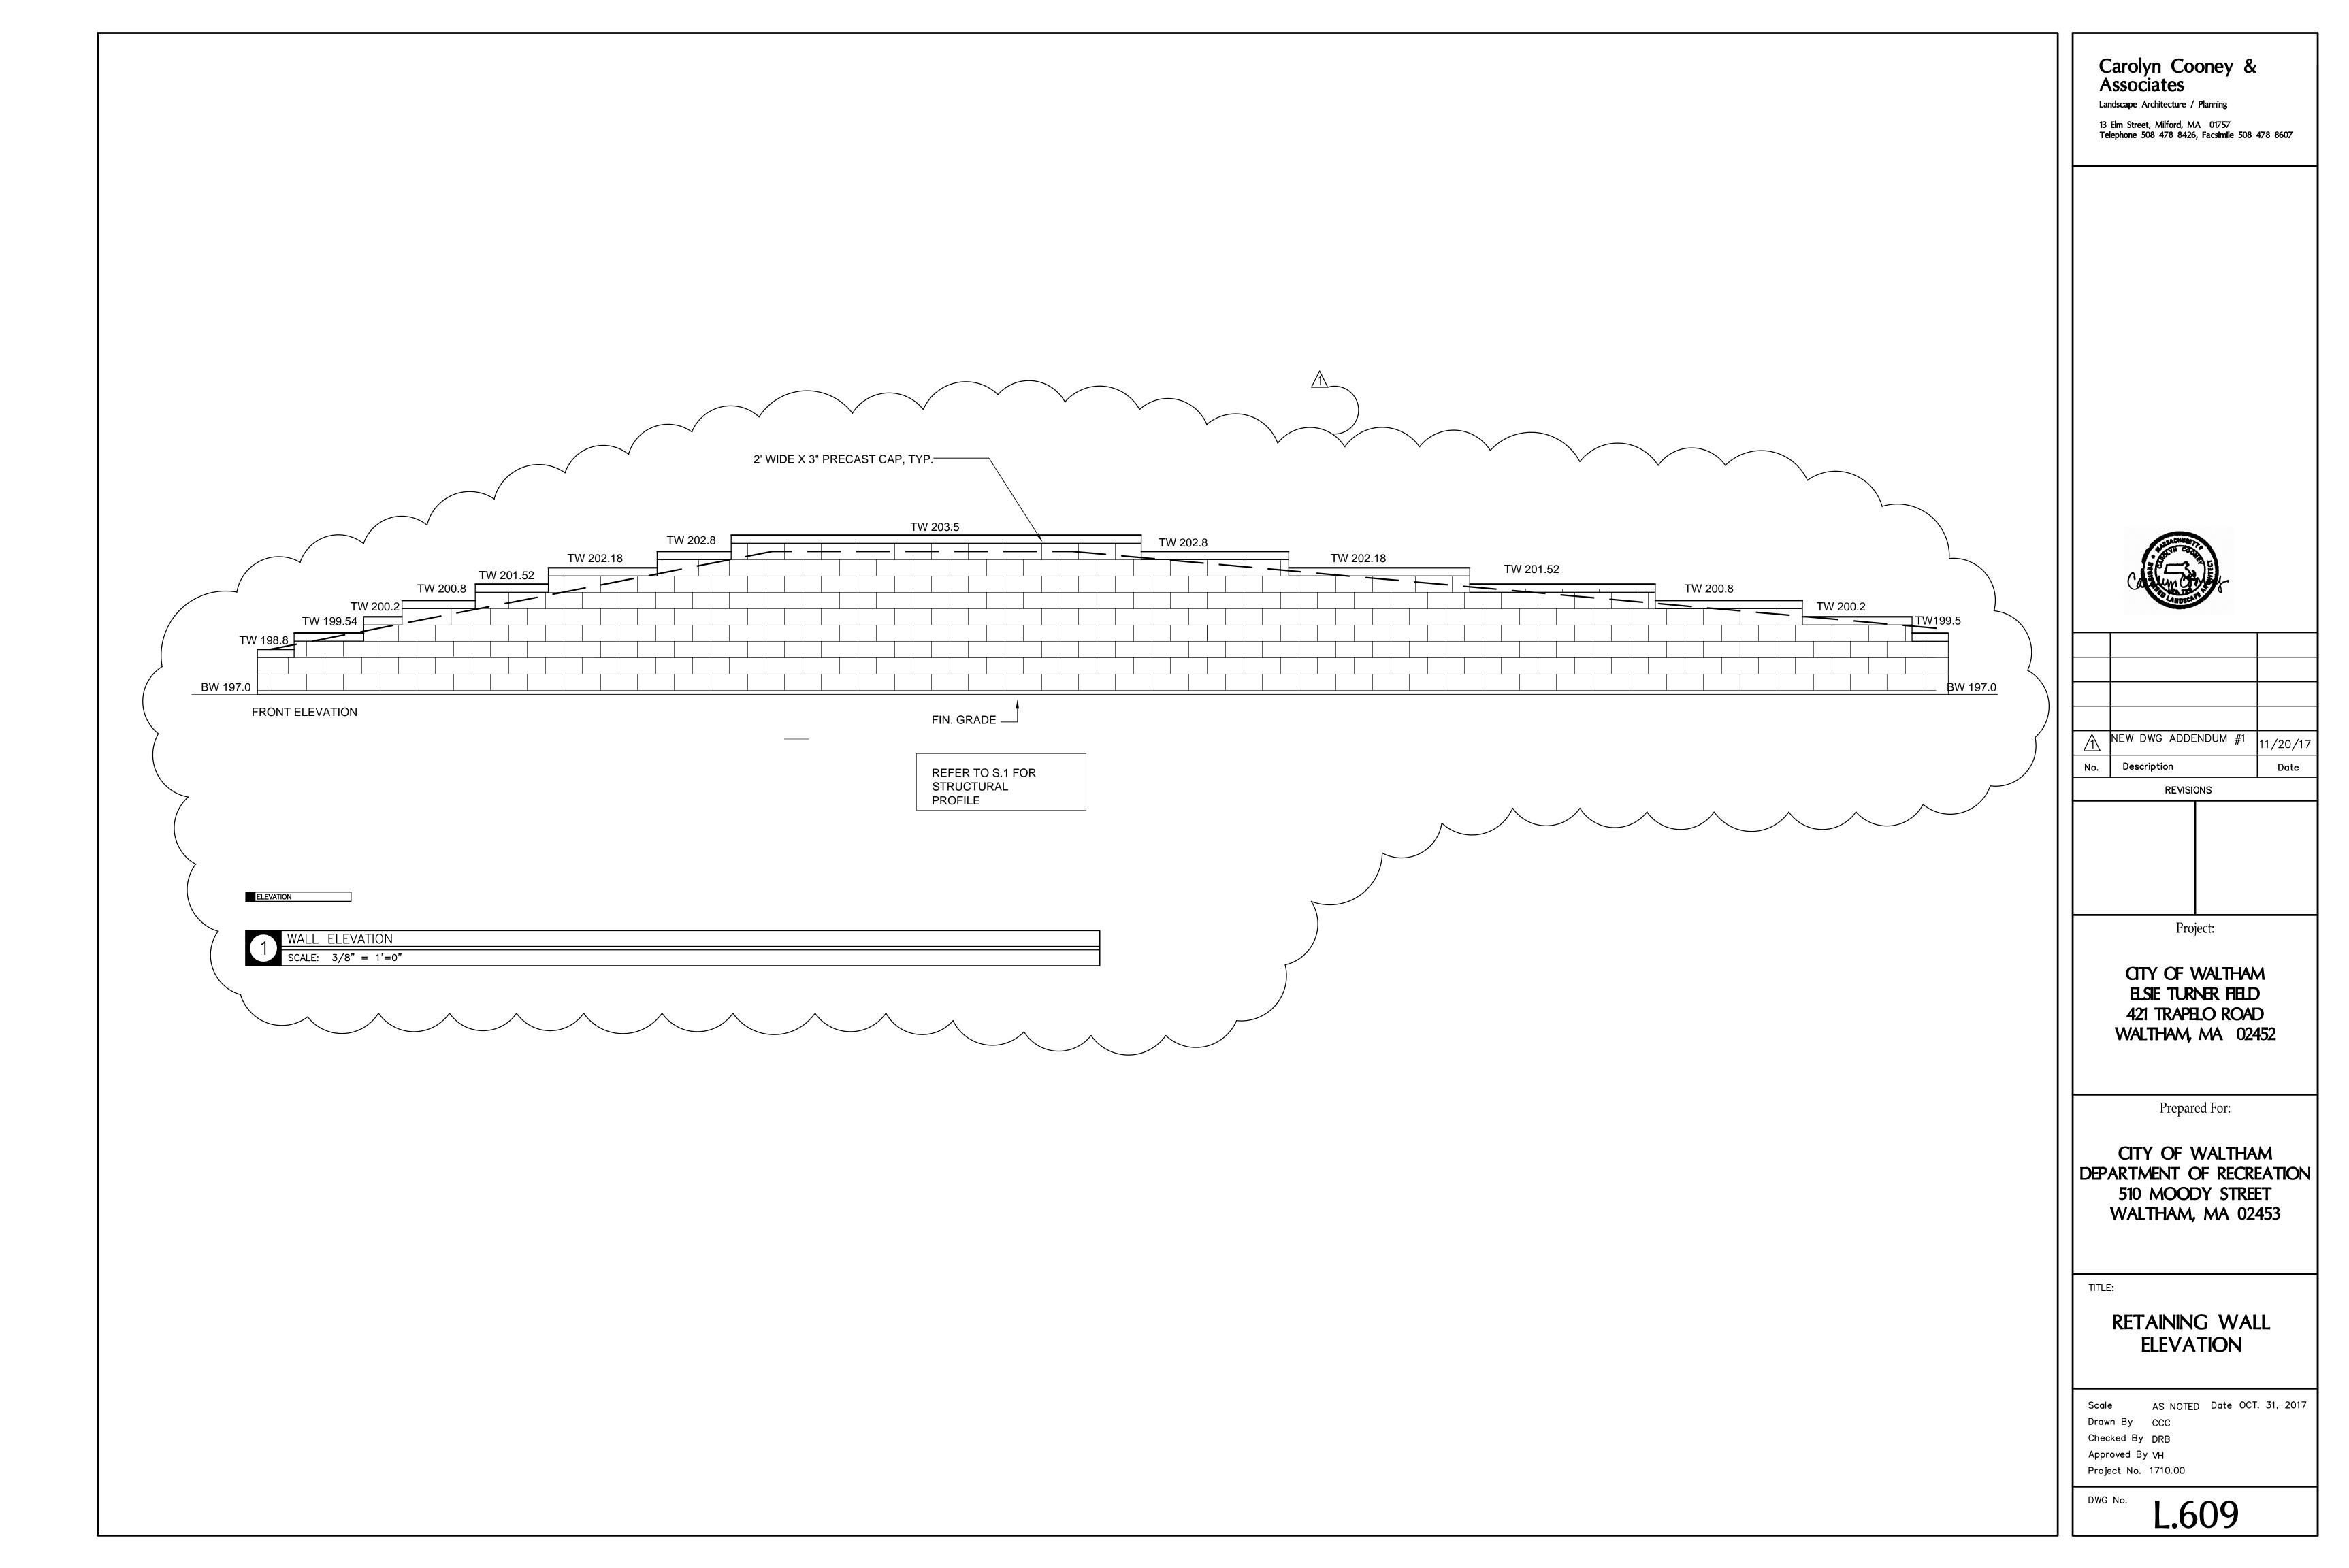

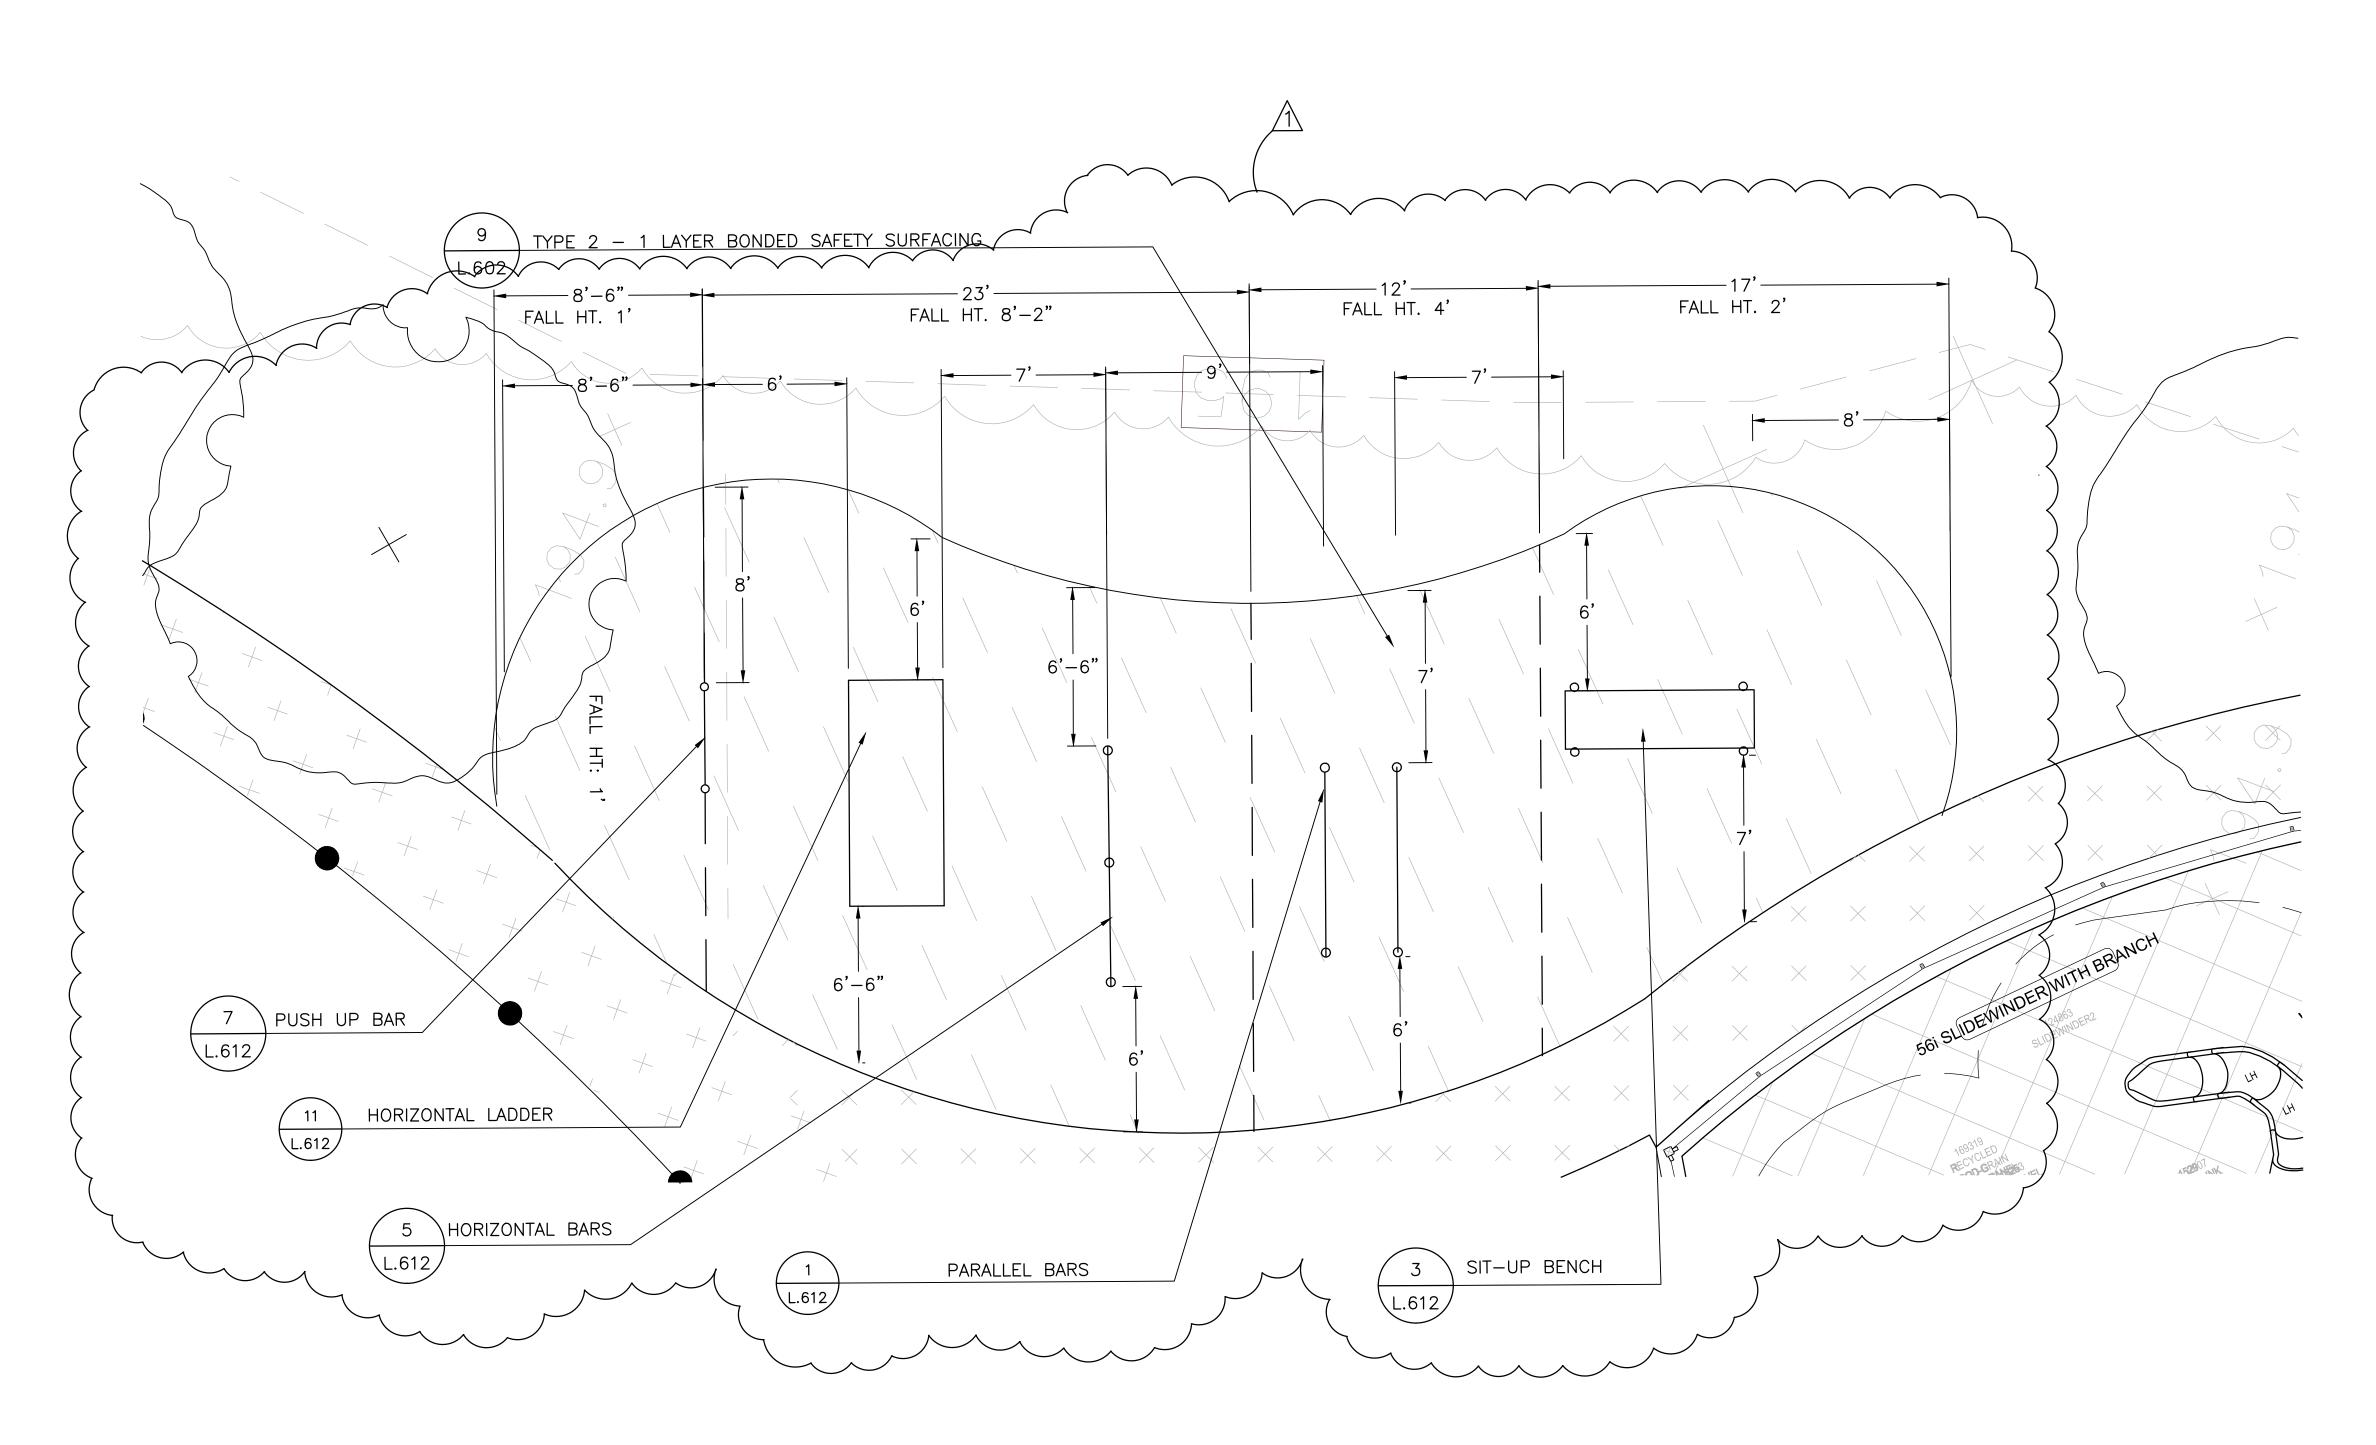

PLAN

1 EXERCISE AREA ENLARGEMENT PLAN

SCALE: 1/4" - 1'-0"

Carolyn Cooney & Associates

Landscape Architecture / Planning

13 Elm Street, Milford, MA 01757
Telephone 508 478 8426, Facsimile 508 478 8607



REVISED ADDENDUM #1 11/20/17

No. Description Date

REVISIONS

North

Project:

CITY OF WALTHAM BLSIE TURNER FIELD 421 TRAPELO ROAD WALTHAM, MA 02452

Prepared For:


CITY OF WALTHAM
DEPARTMENT OF RECREATION
510 MOODY STREET
WALTHAM, MA 02453

TIT

EXERCISE AREA ENLARGEMENT

Scale AS NOTED Date OCT. 31, 2017
Drawn By CCC
Checked By DRB
Approved By VH
Project No. 1710.00

No.

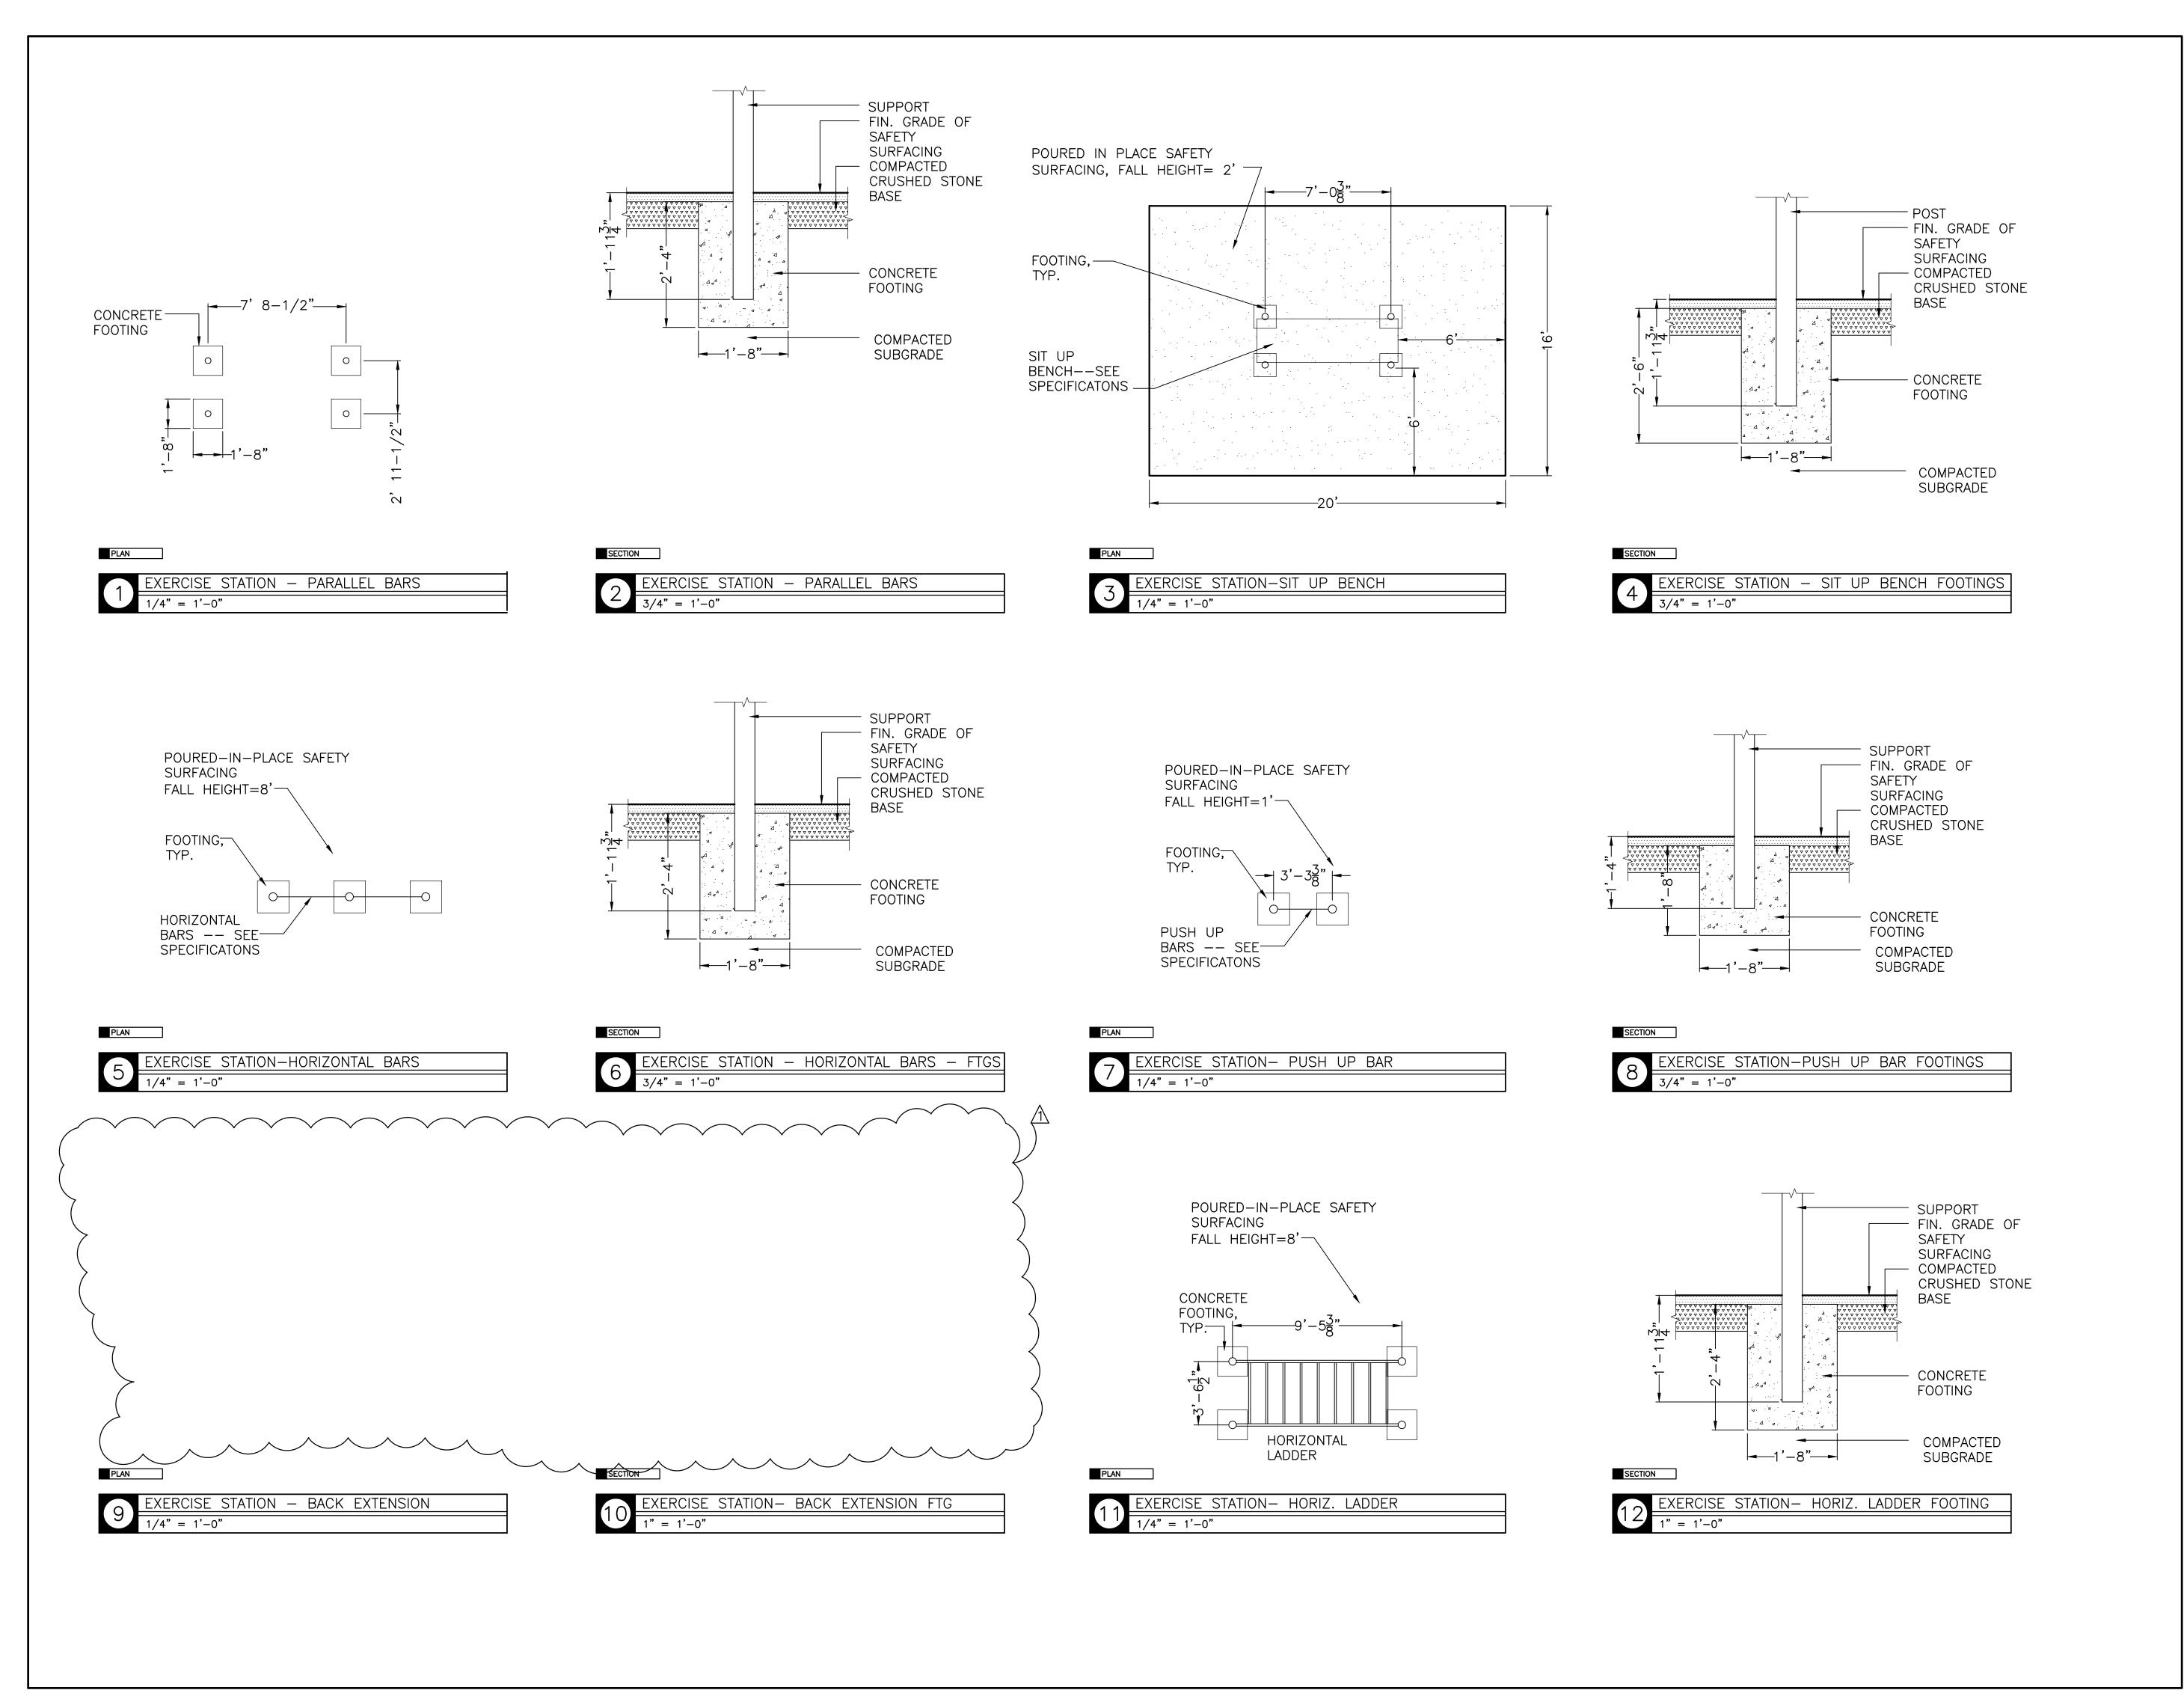

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REVISED ADDENDUM #1 - DELETE BACK EXTENSION Date

REVISIONS

REVISIONS

Project:

CITY OF WALTHAM ELSIE TURNER FIELD 421 TRAPELO ROAD WALTHAM, MA 02452

Prepared For:


CITY OF WALTHAM
DEPARTMENT OF RECREATION
510 MOODY STREET
WALTHAM, MA 02453


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EXERCISE EQUIPMENT EQUIPMENT

Scale AS NOTED Date OCT. 31, 2017
Drawn By CCC
Checked By DRB
Approved By VH
Project No. 1710.00

No. [_ _ 1



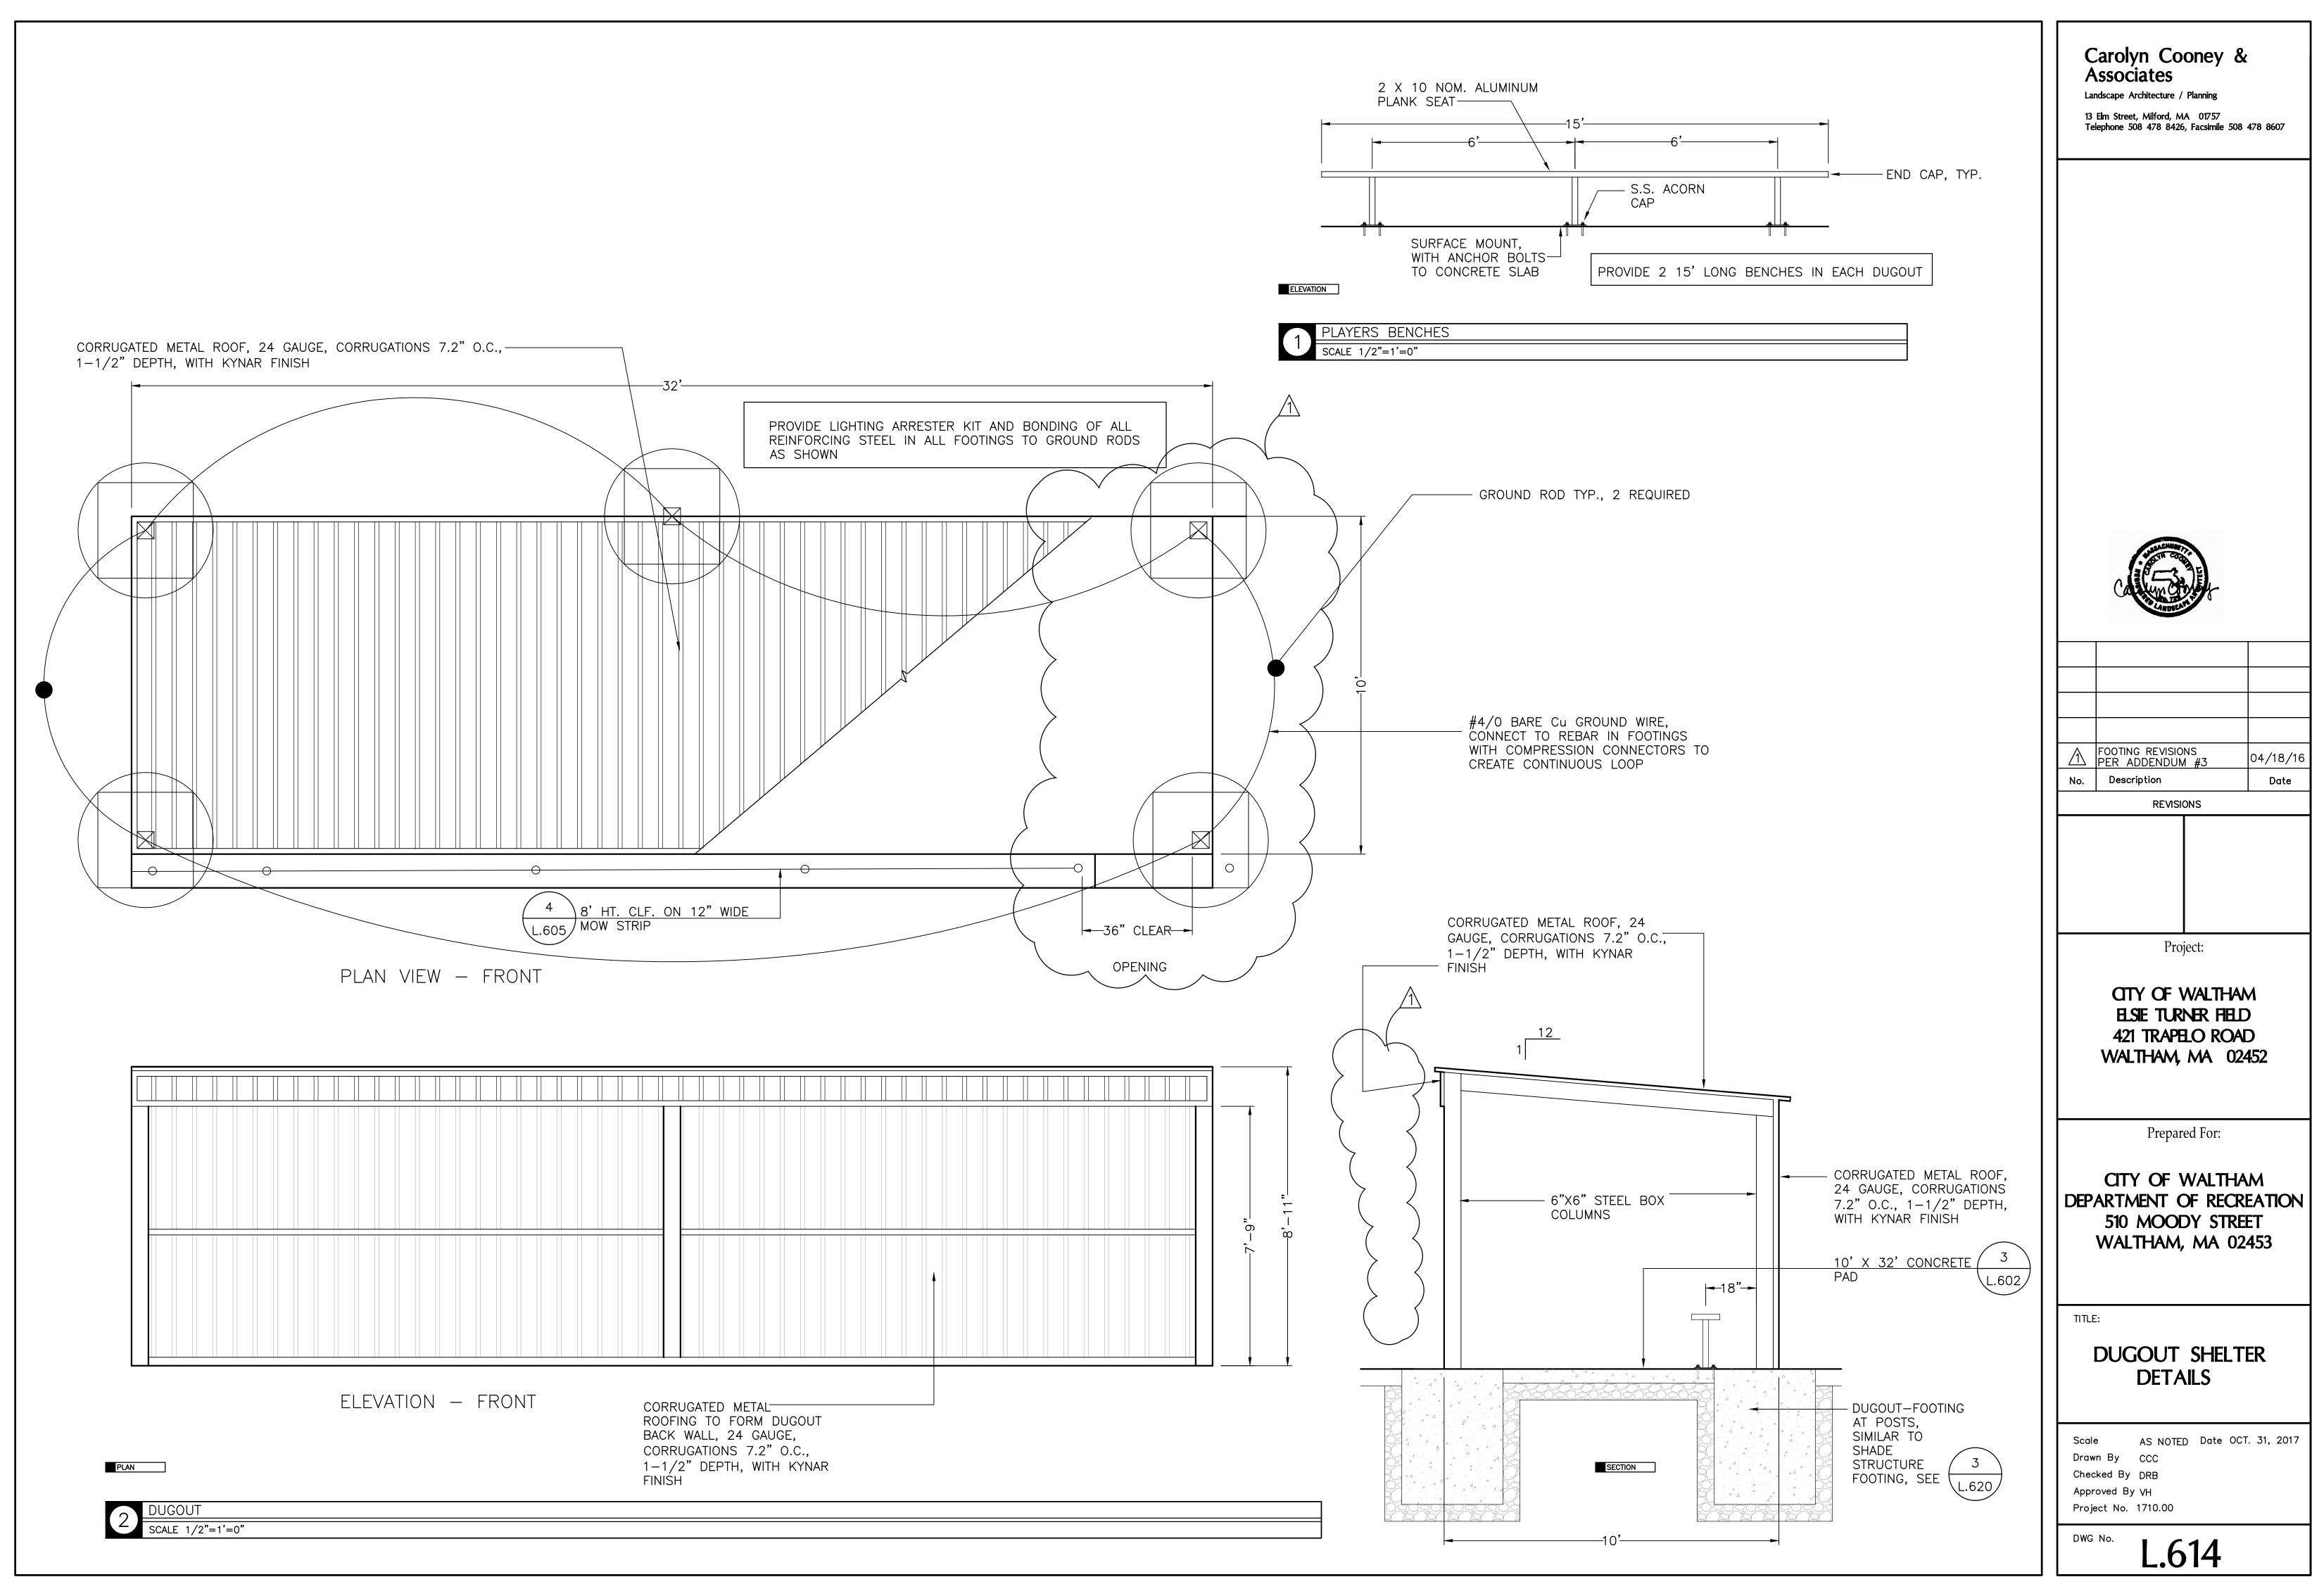

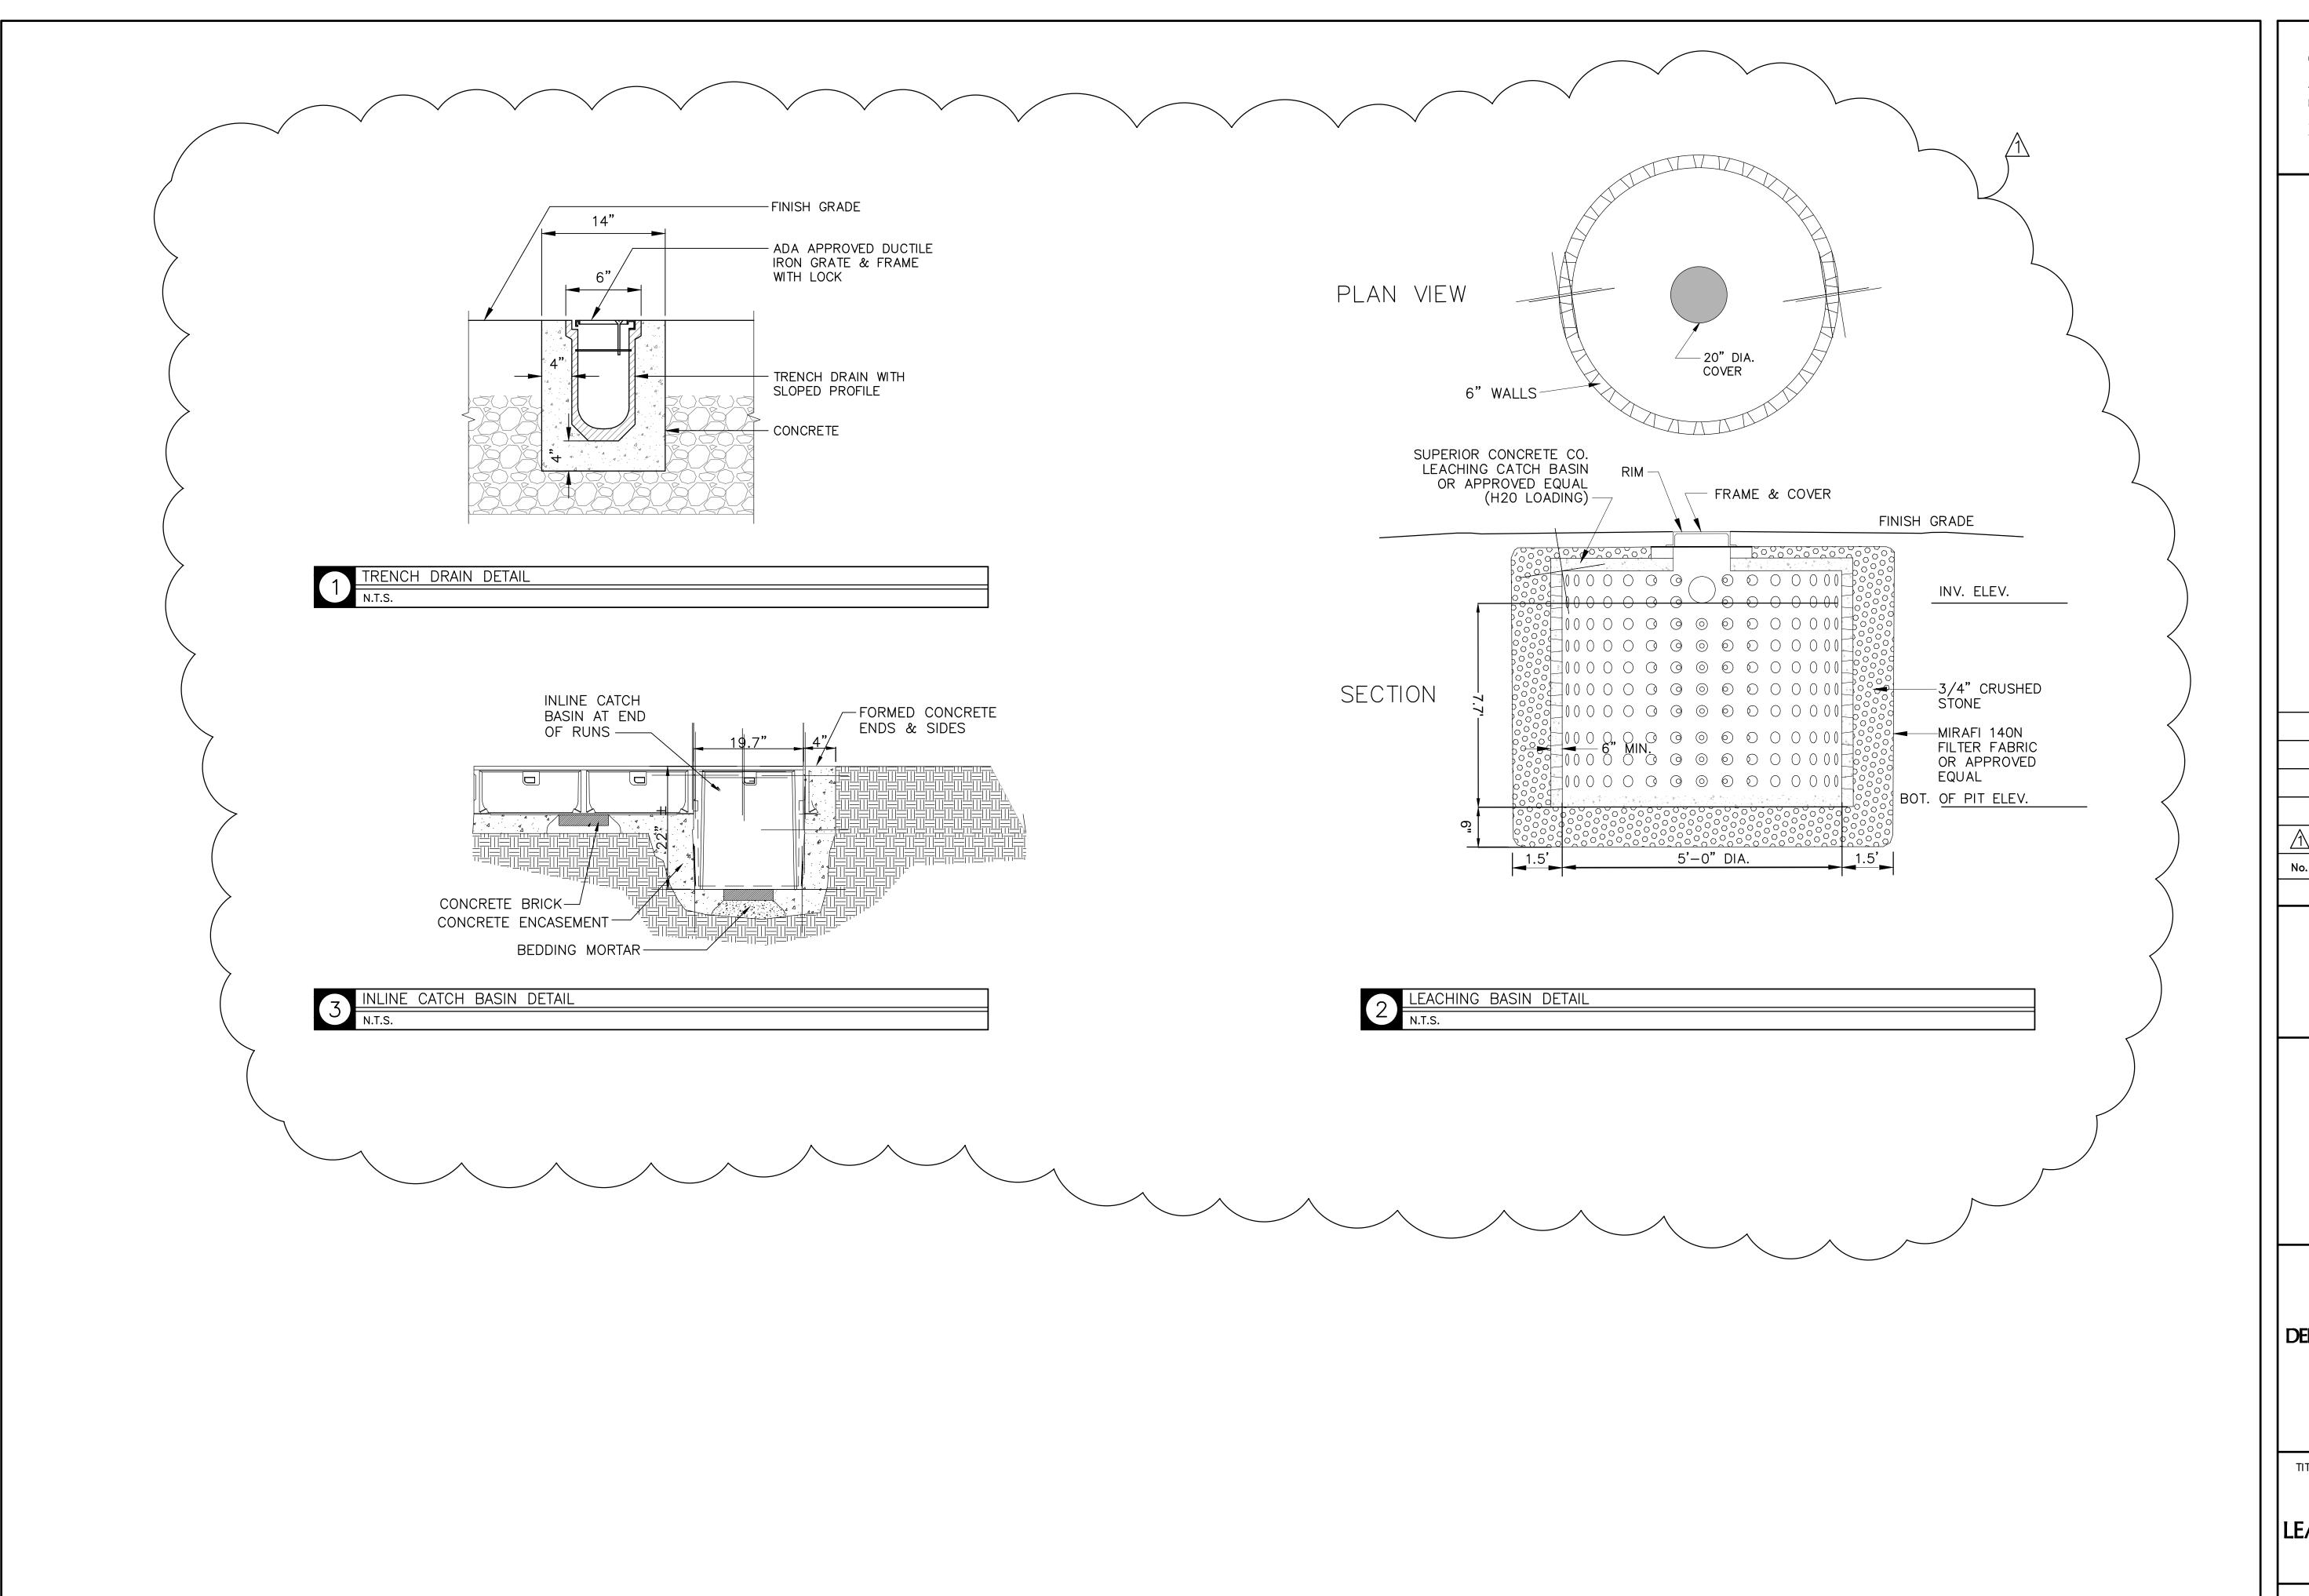Landscape Architecture / Planning 13 Elm Street, Milford, MA 01757 Telephone 508 478 8426, Facsimile 508 478 8607



NEW DWG ADDENDUM #1 11/20/17 Description REVISIONS

Project:

CITY OF WALTHAM ELSIE TURNER FIELD 421 TRAPELO ROAD WALTHAM, MA 02452


Prepared For:

CITY OF WALTHAM DEPARTMENT OF RECREATION 510 MOODY STREET WALTHAM, MA 02453

TRENCH DRAIN/ LEACHING BASIN DETAILS


AS NOTED Date OCT. 31, 2017 Drawn By CCC

Checked By DRB Approved By VH Project No. 1710.00

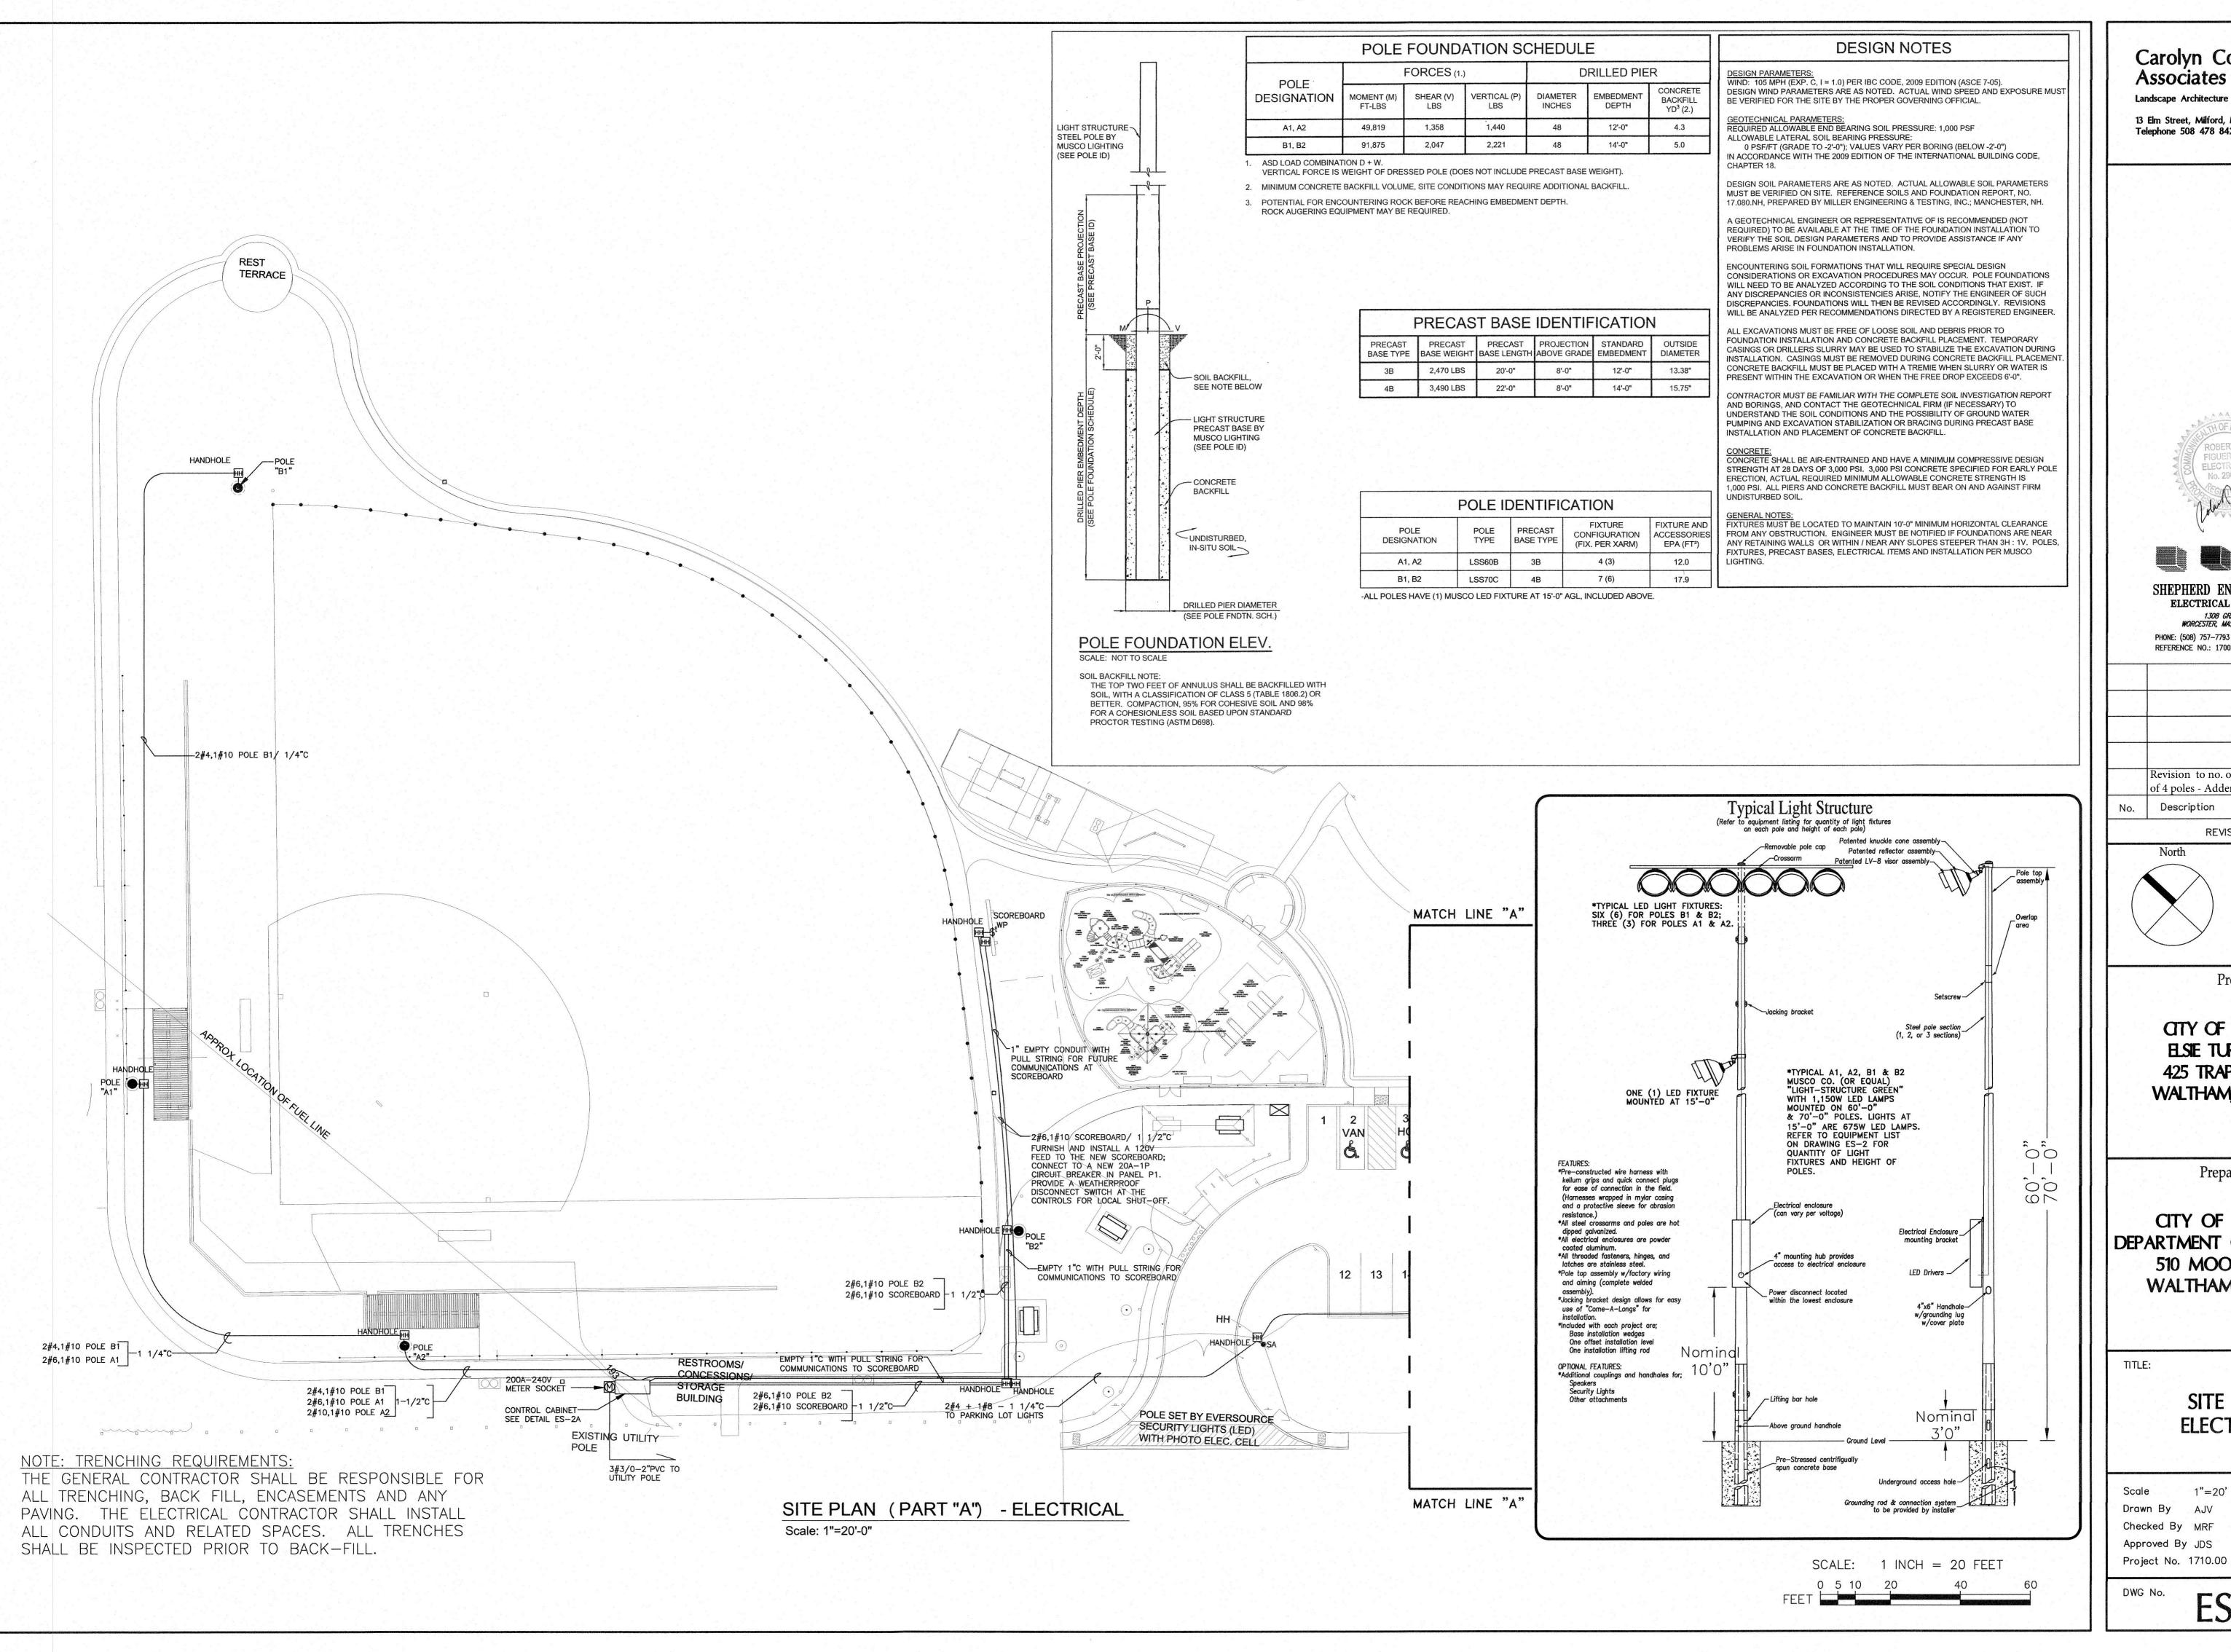

Landscape Architecture / Planning

13 Elm Street, Milford, MA 01757 Telephone 508 478 8426, Facsimile 508 478 8607

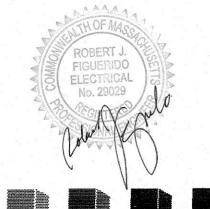


SHEPHERD ENGINEERING, INC. ELECTRICAL CONSULTANTS 1308 GRAFTON STREET WORCESTER, MASSACHUSETTS 01604

PHONE: (508) 757-7793 * FAX: (508) 753-2309 REFERENCE NO.: 17002

	Revision to no. of lights on each of 4 poles - Addendum #1	11-20-17
No.	Description	Date

REVISIONS

North

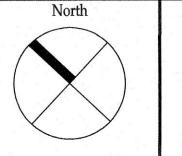

Project:

CITY OF WALTHAM ELSIE TURNER FIELD 425 TRAPELO ROAD WALTHAM, MA 02452


Prepared For:


CITY OF WALTHAM DEPARTMENT OF RECREATION 510 MOODY STREET WALTHAM, MA 02453


SITE PLAN **ELECTRICAL**

Date SEPT 12, 2017 1"=20' Drawn By Checked By MRF

ES.1A

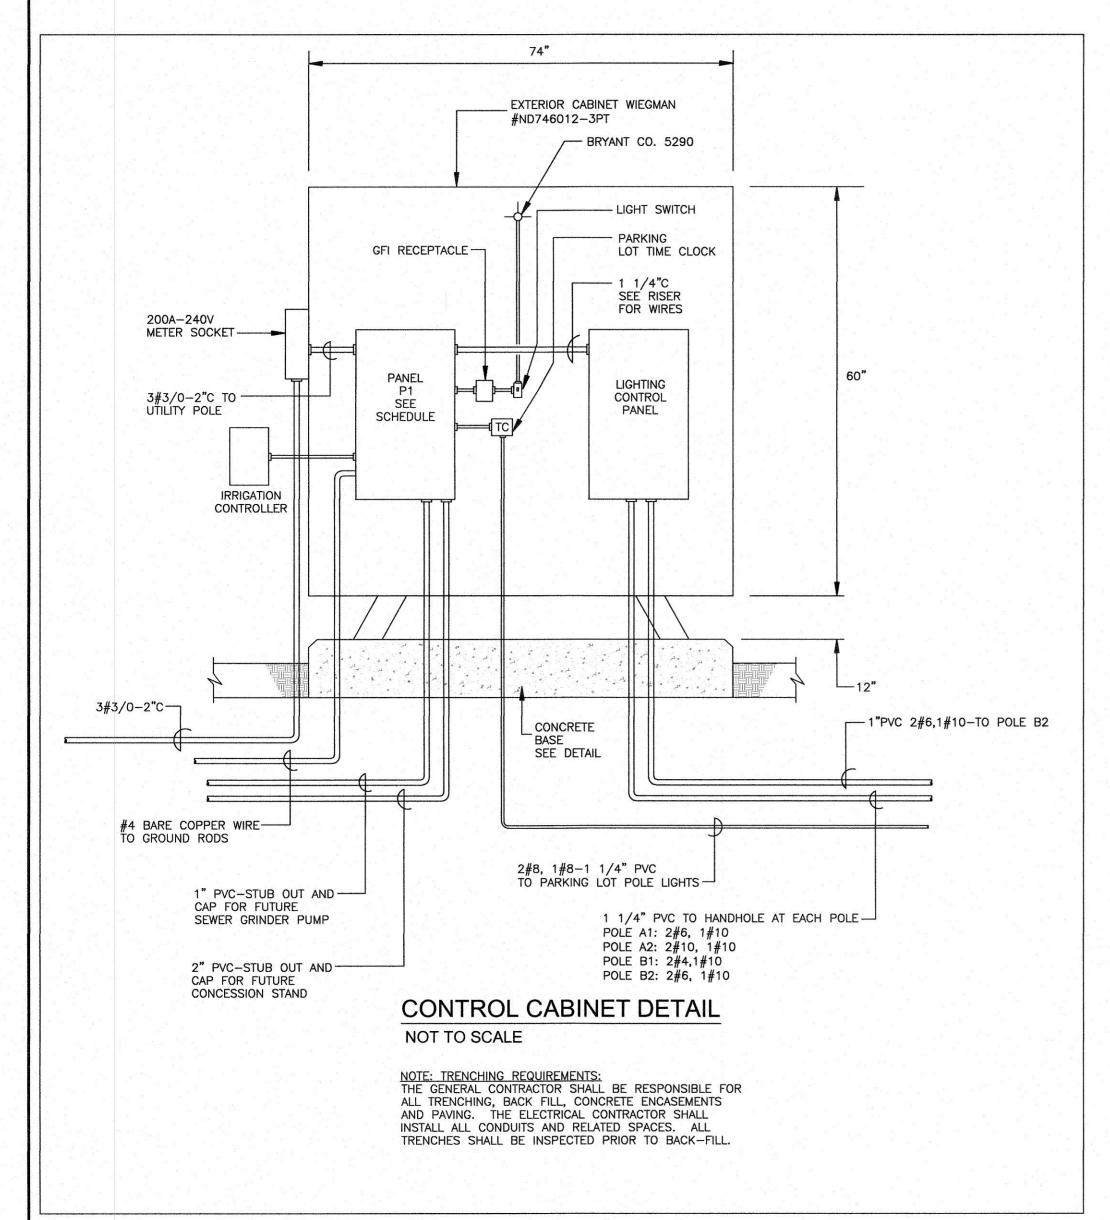

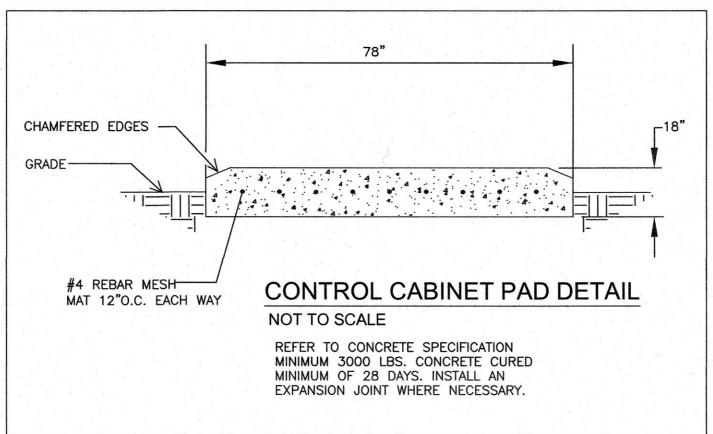


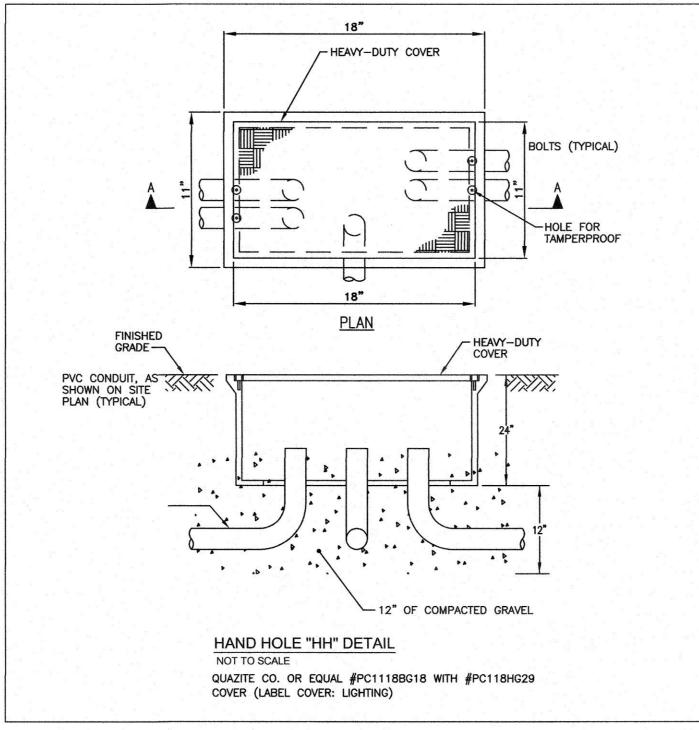


LIGHT FIXTURE POLE SCHEDULE						
TYPE	FIXTURES	FIXTURE TYPE	CONTACTOR ID			
A1	4 (3 HIGH; 1 LOW)	1,150W LED/675W LED	C1			
A2	4 (3 HIGH; 1 LOW)	1,150W LED/675W LED	C2			
B1	7 (6 HIGH; 1 LOW)	1,150W LED/675W LED	C3			
B2	7 (6 HIGH; 1 LOW)	1,150W LED/675W LED	C4			

PANEL: P1						24
MAIN: 200A MCB VOLTAGE: 120/240V PHASE: 1 WIRE:	3			TYPE: SQUARE D CO. OR EQUAL SURFACE BOLT ON		
CIR DESCRIPTION	TRIP	POLE	CIR	DESCRIPTION	TRIP	POLE
POLE A1	30	2	2	POLE A2	30	2
5 7 POLE B1	50	2	6 8	POLE B2	50	2
9 GFI DUPLEX RECEPT.	20	1	10	EXIST. LIGHTING CONTROL PANEL	20	1
11 IRRIGATION SYSTEM	20	1	12	SCOREBOARD	20	1
13 PARKING LOT LIGHTS	20	2	14	SPARE	20	1
15 PARKING LOT LIGHTS	20	2	16	SPARE	20	1

POLE	POLE HT	CIRCUIT DESCRIPTION	# OF FIXTURES	FLA CC	NIACIOR	SIZE
A1	60	MULTI-PURPOSE	4	21.3A	30	
12	60	MULTI-PURPOSE	4	21.3A	30	
31	70	MULTI-PURPOSE	7	39.0A	60	
32	70	MULTI-PURPOSE	7	39.0A	60	

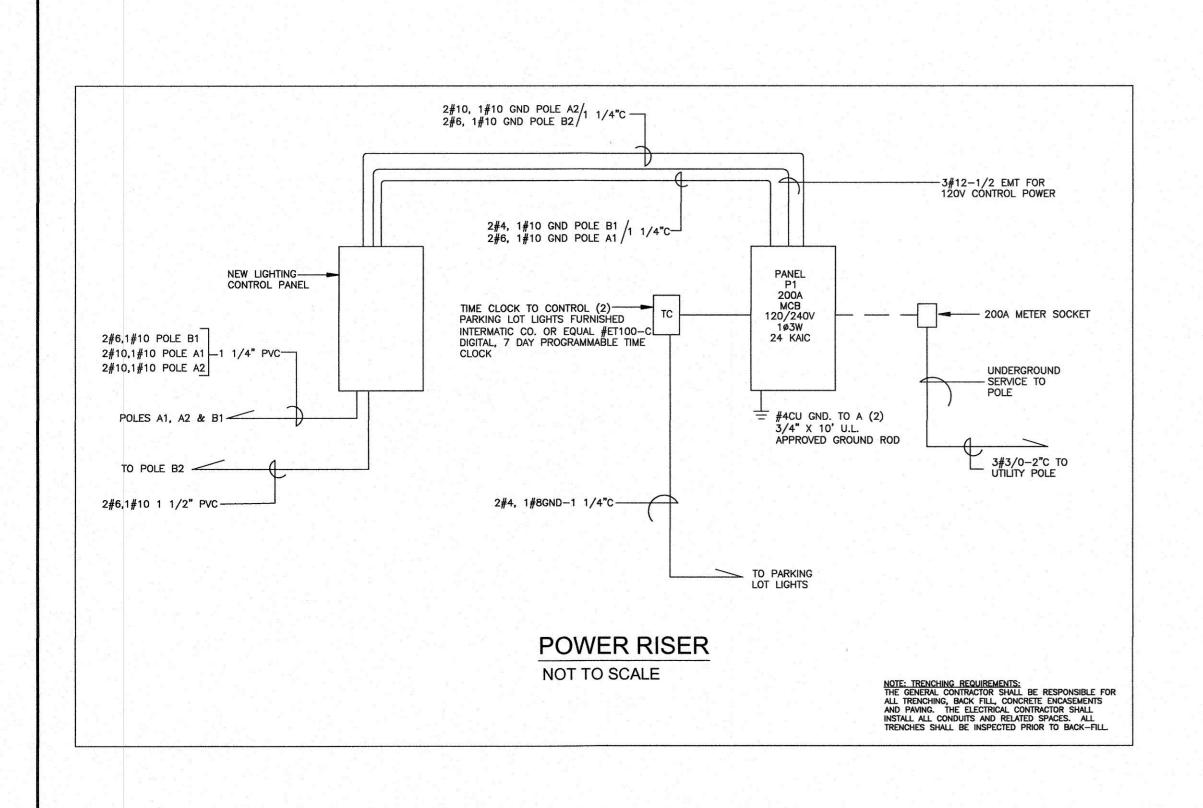

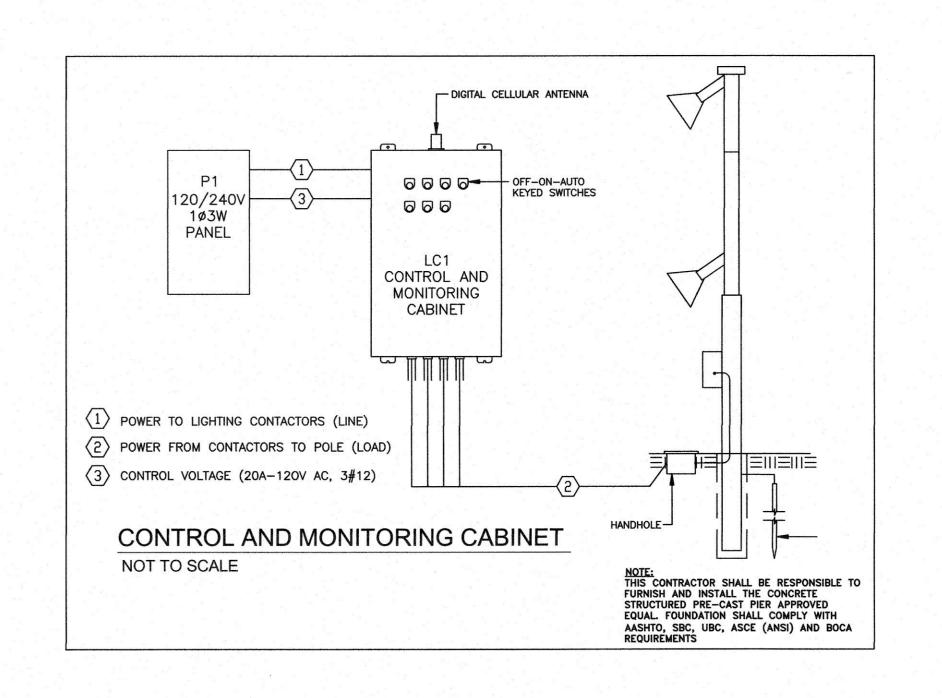

Carolyn Cooney & Associates

Landscape Architecture / Planning

Landscape Architecture / Planning

13 Elm Street, Milford, MA 01757
Telephone 508 478 8426, Facsimile 508 478 8607



SHEPHERD ENGINEERING, INC.
ELECTRICAL CONSULTANTS

1308 GRAFTON STREET
WORCESTER, MASSACHUSETTS 01604

PHONE: (508) 757-7793 * FAX: (508) 753-2309
REFERENCE NO.: 17002

	Addendum #1	- 11/2-/17	
No.	Description		Date
	REVISI	ONS	

Project:

CITY OF WALTHAM ELSIE TURNER FIELD 425 TRAPELO ROAD WALTHAM, MA 02452

Prepared For:

CITY OF WALTHAM
DEPARTMENT OF RECREATION
510 MOODY STREET
WALTHAM, MA 02453

ELECTRICAL DETAILS

Scale N.T.S. Date SEPT 12, 2017
Drawn By AJV
Checked By MRF
Approved By JDS
Project No. 1710.00

DWG No. EC

ES.2