THE CITY OF WALTHAM MASSACHUSETTS

PURCHASING DEPARTMENT

Design for the Reconstruction of the Whittemore Elementary School Playground

ADDENDUM NO.2

June 1, 2018

CHANGES, CORRECTIONS AND CLARIFICATIONS

The attention of bidders submitting proposals for the above subject project is called to the following addendum to the specifications. The items set forth herein, whether of omission, addition, substitution or clarification are all to be included in and form a part of the proposal submitted.

THE NUMBER OF THIS ADDENDUM (NO. 2) MUST BE ENTERED PAGE 35 AT THE END OF THE BID PRICE FORM.

ITEM 1: ANSWERS TO POSED QUESTIONS

- **Q1**. Is the City able to make any plans of the site (either as-built or, if not those, design plans) available?
- A1. See attached
- **Q2.** Is the selection solely based on price, assuming the bidders are qualified/responsible?
- **A2** .No. The selection is first based on the technical merits of the respondent.
- Q3. How many copies should be submitted?
- A3. Please submit 4 copies single sided printing and stapled with a single
- **Q5**. Does the price need to be in a separate envelope from the qualifications, or should it all be in one package?
- **A5.** No


End of Addendum 2

Whittemore Elementary School

30 Parmenter Road Waltham, Massachusetts

100 %CONSTRUCTION DOCUMENTS

September 29, 2006

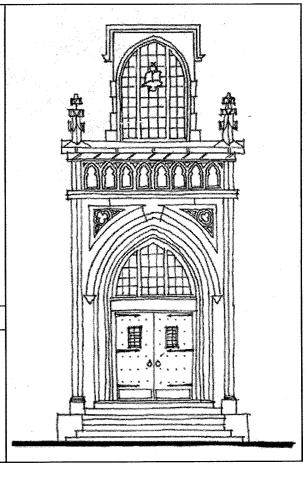

Architect

FLANSBURGH ASSOCIATES

77 North Washington Street Boston, Massachusetts 02114-1910 Telephone 617-367-3970 Fax 617-720-7873 www.faiarchitects.com

FAI Project No. 2015.00

Consultants

Land Surveyor

Welch Associates Land Surveyors, Inc. 218 North Main Street

West Bridgewater, MA 02379

Civil Engineer

Judith Nitsch Engineering, Inc,

186 Lincoln Street, Suite 200 Boston, MA 02111

Landscape Architect

Geller DeVellis, Inc.

77 North Washington Street Boston, MA 02114

Furniture, Equipment and Casework Consultant

Tavares Design Associates, Inc.

319 Massachusetts Avenue Arlington, MA 02174 Structural Engineer

Engineers Design Group, Inc.

10 Cabot Road, Suite 210 Medford, MA 02155

Mechanical, Electrical, Plumbing and Fire Protection Engineer

TMP Consulting Engineers, Inc.

52 Temple Place Boston, MA 02111

Computer/Technology Consultant

Edvance Technology Design, Inc.

2 Summer Street

Chelmsford, MA 01824

Geotechnical/Environmental Consultant

SEA Consultants, Inc.

485 Massachusetts Avenue Cambridge, MA 02139

List o	of D	rawi	ngs
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Elevator Plans, Sections & Details

Enlarged Gym Plan

A6.07

		A7.02	Interior Elevations- Typical Classrooms Existing Building	r.		
A0.00	Cover Sheet	A7.03	Interior Elevations- Typical Classrooms Existing Building			
	s 25	A7.04	Interior Elevations- Typical Classrooms Existing Building.	FIDE DDOT	FEOTION	
SURVEY		A7.05	Interior Elevations- Typical Classrooms Existing Building	FIRE PROT	TECTION	
		A7.06	Interior Elevations Typical Classrooms Existing Building		er	
X1.00	Existing Conditions Survey		**	FP0.00	Legend, Details & Notes Fire Protection	
		A7.07	Interior Elevations- Typical Kindergartens			
CIVIL		A7.08	Interior Elevations- Typical Music and Art Rooms	FP1.11	First Floor Plan Fire Protection	
		A7.09	Interior Elevations- Library/Media Center	FP1.21	Second Floor Plan Fire Protection	
C-1	Site Utility Plan	A7.10	Interior Elevations- Main Lobby	FP1.31	Third Floor Plan Fire Protection	
C-2	Site Utility Details	A7.11	Interior Elevations- Cafetorium			
C-3	Site Utility Details	A7.72	Interior Elevations- Gym	PLUMBING		
C-4	Site Layout Plan	A7.13	Interior Elevations- Gym	1 LOWDING		
0 1	One Edyode Fidir	A7.14	Interior Elevations- Existing Building Corridors	D 0.00	Legand Dataile Natas and Cahadula Diumbina	
LANDSCA	APE			P0.00	Legend, Details, Notes and Schedule Plumbing	
Darboon	W E.	A7.15	Interior Elevations- Existing Building Corridors			
00.4	0% D . Di .	A1.16	Interior Elevations- Existing Building Corridors	P1.11	First Floor Plan Plumbing	
SP-1	Site Prep. Plan			P1.21	Second Floor Plan Plumbing	
L-1	Layout & Materials Plan	A8.01	Signage	P1.31	Third Floor Plan Plumbing	
L-2	Grading Plan	A8.02	Millwork Details	P1.41	Roof Plan Plumbing	
L-3	Planting Plan	A8.03	Millwork Details			
L-4	Enlargement Plan	A8.04	Restoration Details	P2.01	Enlarged Kitchen Plan Plumbing	
L-5	Enlargement Plan	70.04	restoration Details	P2.01	Charged Kitchen Flath Flumbling	
L-6	Site Details- Sheet I		F: . F: . DOB			
		A9.01	First Floor RCP	MECHANIC	CAL	
L-7	Site Details- Sheet II	A9.02	Second Floor RCP			
L-8	Site Details- Sheet III	A9.03	Third Floor RCP	M1.01	LIV/AC Logond	
L-9	Site Details- Sheet IV	A9.04	RCP Details- Existing Building	IVI 1.U I	HVAC Legend	
ADCUITE	CTUDAL	A9.05	RCP Details- New Building			
ARCHITE	CIURAL		,,,,,,,,,,,,,,,,,,,,,,,,,,,,,,,,,,,,,,	M1.11	First Floor Plan	
		A10.01	First Floor Finish Plan	M1.21	Second Floor Plan	
A0.01	Legend			M1.31	Third Floor Plan	
A0.03	Code Plan	A10.02	Second Floor Finish Plan	M1.41	Roof Plan	
A0.04	Accessibility Standards	A10.03	Third Floor Finish Plan			
	·	A10.04	Alt. 1 & 2 Second Floor Plan	M2.01	Detail Sheet No. 1	
D1.01	First Floor Demolition Plan	A10.05	Alt. 1 & 2 Third Floor Plan			
D1.02	Second Floor Demolition Plan			M2.02	Detail Sheet No. 2	
		A11.01	Door Schedule			
D1.03	Third Floor Demolition Plan	A11.02	Door & View Window Details	M3.01	Schedule Sheet No.1	
D1.04	Roof Demo Plan			M3.02	Schedule Sheet No. 2	
D1.05	Demo Elevations	A11.03	Finish Schedule			
D1.06	Demo Elevations	EQUIPME	· · · · · · · · · · · · · · · · · · ·	E! ECTDIC	201	
D1.07	Demo Elevations			ELECTRIC	AL	
		EQ1.01	First Floor Equipment Plan			
A1.01	First Floor Plan	EQ1.02	Second Floor Equipment Plan	E0.00	Legend & Luminaires Schedule	
		EQ1.03	Third Floor Equipment Plan	E0.01	Site Plan Electrical	
A1.02	Second Floor Plan	EQ-4	Casework Elevation Details			
A1.03	Third Floor Plan	EQ-5	Casework Elevation Details	E1.01	First Floor Plan Lighting	
A1.04	Partition Types	EQ-6	Casework Elevation Details	E1.01a	First Floor Plan Power & Systems	
		EQ-0	Casework Elevation Details			
A2.01	Roof Plan			E1.02	Second Floor Plan Lighting	
A2.02	Roof Details	FS-1	Kitchen Equipment Plan, Schedule & Details	E1.02a	Second Floor Plan Power & Systems	
A2.03	Roof Details	FS-2	Kitchen Equipment Rough-in & Details	E1.03	Third Floor Plan Lighting	
74.00	Tool Dolling	FS-3	Kitchen Exhaust	E1.03a	Third Floor Plan Power & Systems	
40.04	Estados Elevatione	STRUCTU		E1.04	Roof Plan	
A3.01	Exterior Elevations			E1.05	Kitchen Part Plan	
A3.02	Exterior Elevations	S0.01	General Notes			
A3.03	Exterior Elevations	\$0.02	Typical Details		Day Distriction District	
A3.04	Exterior Elevations		21	E2.00	Power Distribution Riser Diagram and Schedules	
		S0.03	Typical Details	E2.01	Schedules	
A4.01	Building Sections	S0.04	Typical Details	E2.02	Riser Diagrams	
A4.02	Wall Sections- New Building	S0.04	Typical Details			
		S0.05	Typical Details	TECHNOL	OCV	
A4.03	Wall Sections- New Building			LECHNOL		
A 5 04	Vertical Details	\$1.01	Foundation Plan	T1.01	First Floor Technology Plan	
A5.01		S1.02	Second Floor Framing Plan	T1.02	Second Floor Technology Plan	
A5,10	Plan Details	\$1.03	Third Floor Framing Plan		· · · · · · · · · · · · · · · · · · ·	
A5.11	Plan Details	\$1.04	Roof Framing Plan	T1.03	Third Floor Technology Plan	
A5.12	Plan Details	31.04			· · · · · · · · · · · · · · · · · · ·	
A5.13	Interior Details	00.04	Castiana	T2.01	Technology Detail Sheet #1	
A5.20	Window Types	\$2.01	Sections	T2.02	Technology Detail Sheet #2	
· 	<i>"</i>	\$2.02	Sections	T2.03	Technology Detail Sheet #3	
A6.01	Enlarged Toilet Plans and Elevations			T2.04	Technology Detail Sheet #4	
		\$3.01	Sections	T2.05	Technology Detail Sheet #5	
A6.02	New Stair Plans and Sections	\$3.02	Sections	T2.06	Technology Detail Sheet #6	
A6.03	New Stair Details	\$3.03	Sections			
A6.04	Existing Stairs Plans and Details	20.00		T2.07	Technology Detail Sheet #7	
A 6 0 5	Flavator Plane Sections & Datails					


Brace Frame Elevations

Brace Frame Details

\$4.01

\$4.02

Interior Elevations- Typical Classrooms New Building
Interior Elevations- Typical Classrooms Existing Building

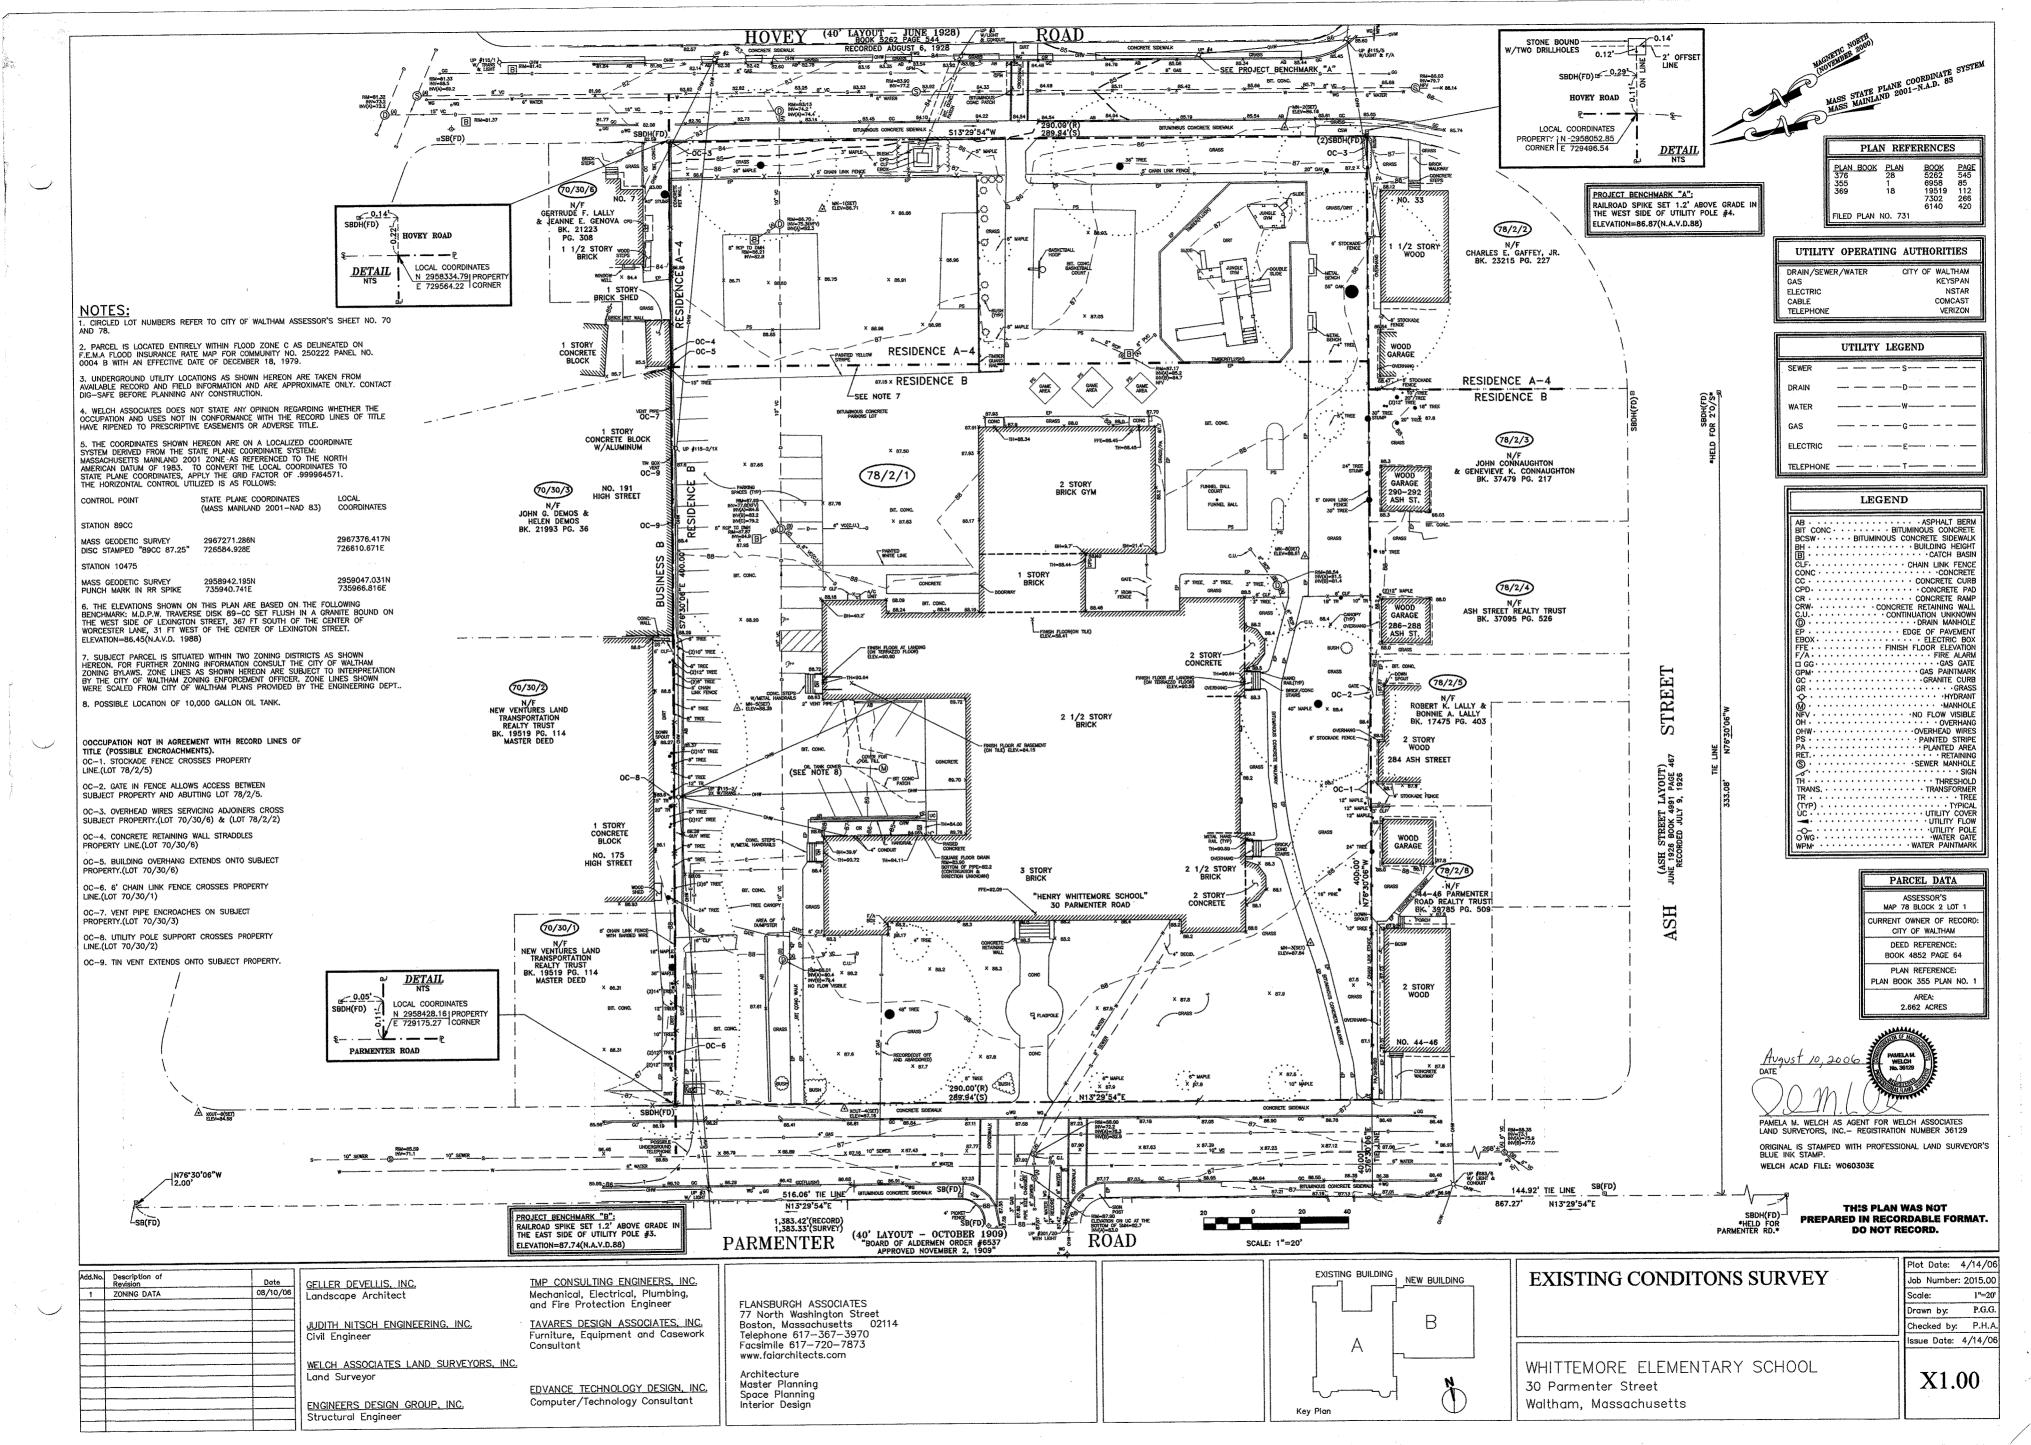


GENERAL NOTES

- 1. TOPOGRAPHIC DATA, PROPERTY LINE INFORMATION, AND EXISTING SITE FEATURES WERE OBTAINED FROM A PLAN ENTITLED "EXISTING CONDITIONS SURVEY, WHITTEMORE ELEMENTARY SCHOOL, WALTHAM MASSACHUSETTS", PREPARED BY WELCH ASSOCIATES., DATED FEBRUARY 22, 2001.
- 2. THE LOCATIONS AND ELEVATIONS OF ALL EXISTING UTILITIES SHALL BE CONSIDERED APPROXIMATE AND MUST BE VERIFIED BY THE CONTRACTOR PRIOR TO ANY UTILITY CONNECTIONS OR CROSSINGS OF PROPOSED UTILITIES AND EXISTING UTILITIES. THE CONTRACTOR SHALL CONTACT THE RESPECTIVE UTILITY COMPANIES RELATIVE TO THE LOCATIONS AND ELEVATIONS OF THEIR LINES. THE CONTRACTOR SHALL KEEP A RECORD OF ANY DISCREPANCIES OR CHANGES IN THE LOCATIONS OF ANY UTILITIES SHOWN OR ENCOUNTERED DURING CONSTRUCTION. ANY DISCREPANCIES SHALL BE REPORTED TO JUDITH NITSCH ENGINEERING, INC.
- 3. THE CONTRACTOR SHALL COMPLY WITH MASSACHUSETTS GENERAL LAWS CHAPTER 82, SECTION 40, AS AMENDED, WHICH STATES THAT NO ONE MAY EXCAVATE IN THE COMMONWEALTH OF MASSACHUSETTS EXCEPT IN AN EMERGENCY WITHOUT 72 HOURS NOTICE, EXCLUSIVE OF SATURDAYS, SUNDAYS, AND LEGAL HOLIDAYS, TO NATURAL GAS PIPELINE COMPANIES, AND MUNICIPAL UTILITY DEPARTMENTS THAT SUPPLY GAS, ELECTRICITY, TELEPHONE, OR CABLE TELEVISION SERVICE IN OR TO THE CITY OR TOWN WHERE THE EXCAVATION IS TO BE MADE. THE CONTRACTOR SHALL CALL "DIG SAFE" AT 1-888-DIG-SAFE.
- 4. ALL UTILITY CONNECTIONS ARE SUBJECT TO THE APPROVAL OF, AND GRANTING OF PERMITS BY, THE CITY OF WALTHAM. IT SHALL BE THE RESPONSIBILITY OF THE GENERAL CONTRACTOR TO SEE THAT ALL PERMITS AND APPROVALS ARE OBTAINED BEFORE STARTING CONSTRUCTION. THE CONTRACTOR SHALL BE SOLELY RESPONSIBLE FOR MAKING ALL NECESSARY ARRANGEMENTS FOR AND FOR PERFORMING ANY NECESSARY WORK INVOLVED IN CONNECTION WITH THE DISCONTINUANCE OF ANY UTILITIES OR WITHIN THE JURISDICTION OF ANY UTILITY COMPANIES, SUCH AS ELECTRICITY, TELEPHONE, WATER, GAS, AND ANY SYSTEM OR SYSTEMS WHICH WILL BE AFFECTED BY THE WORK TO BE PERFORMED UNDER THIS CONTRACT. THE CONTRACTOR SHALL NOTIFY ALL APPROPRIATE AGENCIES, DEPARTMENTS, AND UTILITY COMPANIES, IN WRITING, AT LEAST 48 HOURS AND NOT MORE THAN 30 DAYS PRIOR TO ANY CONSTRUCTION. CONSTRUCTION SHALL NOT INTERFERE WITH OR INTERRUPT UTILITIES WHICH ARE TO REMAIN IN OPERATION.
- 5. THE CONTRACTOR SHALL COMPLY WITH ALL APPLICABLE FEDERAL, STATE, AND LOCAL LAWS, RULES, REGULATIONS AND SAFETY CODES IN THE CONSTRUCTION OF ALL IMPROVEMENTS.
- 6. THE CONTRACTOR SHALL TAKE ADEQUATE PRECAUTIONS TO PROTECT ALL WALKS, GRADING, SIDEWALKS AND SITE DETAILS OUTSIDE OF THE LIMITS OF REGRADING AND WORK AS SHOWN ON THE DRAWINGS AND SHALL REPAIR AND REPLACE OR OTHERWISE MAKE GOOD AS DIRECTED BY THE ENGINEER OR OWNER'S DESIGNATED REPRESENTATIVE ANY SUCH OR OTHER DAMAGE SO CAUSED.
- 7. THE CONTRACTOR SHALL REMOVE FROM THE SITE ALL RUBBISH AND DEBRIS FOUND THEREON. STORAGE OF SUCH MATERIALS ON THE PROJECT SITE WILL NOT BE PERMITTED. THE CONTRACTOR SHALL LEAVE THE SITE IN SAFE, CLEAN, AND LEVEL CONDITION UPON COMPLETION OF THE SITE CLEARANCE WORK.
- 8. THE CONTRACTOR SHALL REMOVE FROM THE AREA OF CONSTRUCTION PAVEMENT, CONCRETE, GRANITE CURBING, CEMENT CURBING, POLES AND FOUNDATIONS, ISLANDS, TREE BERMS AND OTHER FEATURES WITHIN THE LIMITS OF CONSTRUCTION AS REQUIRED TO ACCOMMODATE NEW CONSTRUCTION WHETHER SPECIFIED ON THE DRAWINGS OR NOT.
- 9. FOR SITE LAYOUT, GRADING, MATERIALS, PLANTINGS, GROUND COVER, EROSION CONTROL, AND DETAILS SEE
- 10. ALL WATER, SEWER, AND DRAIN WORK SHALL BE PERFORMED ACCORDING TO THE REQUIREMENTS AND STANDARD SPECIFICATIONS OF THE CITY OF WALTHAM.
- 11. ELEVATIONS REFER TO N.A.V.D 1988.
- 12. GAS, TELEPHONE AND ELECTRIC SERVICES ARE TO BE DESIGNED BY EACH UTILITY COMPANY IN COORDINATION WITH THE MECHANICAL, ELECTRIC AND PLUMBING CONSULTANTS. THE CONTRACTOR SHALL COORDINATE CONSTRUCTION ACTIVITIES AND DESIGN OF NEW UTILITIES WITH ELECTRIC, CABLE TELEVISION AND TELECOMPUNICATION LITERITIES.
- 13. INSTALL WATER LINES WITH A MINIMUM OF FIVE FEET OF COVER AND A MAXIMUM OF SEVEN FEET.
- 14. MAINTAIN 10 FEET HORIZONTAL SEPARATION BETWEEN SEWER AND WATER LINES. ENCASE BOTH UTILITIES WITH CONCRETE IF 10 FEET SEPARATION CANNOT BE MAINTAINED. WHEREVER THERE IS LESS THAN 10 FEET OF HORIZONTAL SEPARATION AND 18" OF VERTICAL SEPARATION BETWEEN A PROPOSED OR EXISTING SEWER LINE TO REMAIN AND A PROPOSED OR EXISTING WATER LINE TO REMAIN, BOTH UTILITIES SHALL BE ENCASED IN CONCRETE.
- 15. UTILITY STRUCTURES TO BE ABANDONED SHALL BE REMOVED TO A DEPTH OF NO LESS THAN 3 FEET BELOW FINISHED GRADE, THE BOTTOMS OF THE STRUCTURES SHALL BE BROKEN AND THE STRUCTURES SHALL BE BACKFILLED WITH GRAVEL BORROW AND COMPACTED.
- 16. CONTRACTOR SHALL MAINTAIN ALL EXISTING UTILITIES EXCEPT THOSE NOTED TO BE ABANDONED OR REMOVED & DISPOSED.
- 17. THE GENERAL CONTRACTOR IS RESPONSIBLE FOR TRENCHING, BACKFILLING, AND SURFACE RESTORATION FOR THE GAS LINE INSTALLATION.
- 18. FOR SOIL INFORMATION REFER TO GEOTECHNICAL REPORT.
- 19. REFER TO THE PLUMBING PLANS FOR THE LOCATION OF THE BUILDING UNDERDRAINS

CANI	ITADV	INIVERTS	

MANHOLE	RIM ELEVATION	INVERT IN	INVERT OUT
10"x8" WYE	_	71.76	_
SMH #300	87.7	76.52 (FROM SMH #301) 73.54 (FROM SMH#303	73.44 (TO 10"x8" WYE)
SMH #301	88.2	78.24 (FROM SMH #302) 80.74 (FROM BUILDING)	78.14 (TO SMH #300)
SMH #302	88.2	80.74 (FROM BUILDING)	78.89 (TO SMH #301)
SMH #303	87.7	74.59 (FROM SMH #304) 74.69 (FROM BUILDING)	74.49 (TO SMH #302)
SMH #304	87.4	76.86 (FROM GREASE TRAP) 77.94 (FROM BUILDING)	75.36 (TO SMH #303)
REASE TRAP	80.0	77.48 (FROM BUILDING)	77.38 (TO SMH #304)


STORM	INVERTS		
MMANHOLE	RIM ELEVATION	INVERT IN	INVERT OUT
EX. DMH	83.1	74.32 (FROM STC #1)	
STC #1	84.0	74.59 (FROM DMH #200)	74.49 (TO EX. DMH)
DMH # 200	83.9	74.89 (FROM DMH #220) 74.85 (FROM DMH #202)	74.62 (TO STC #1)
DMH # 202	83.2	75.70 (FROM DMH #203) 75.77 (FROM OCS #202A) 77.67 (FROM CB #251)	75.60 (TO DMH #200
DMH #202A	83.2	75.03 (FROM SWM A)	75.93 (TO DMH #202
DMH # 203	83.3	76.72 (FROM DMH #204)	76.62 (TO DMH #202
DMH # 204	84.2	77.18 (FROM DMH #205) 77.56(FROM CB #252)	77.08 (TO DMH #203
DMH # 205	86.9	77.64 (FROM DMH #206) 77.64 (FROM AD #253)	77.54 (TO DMH #204
DMH # 206	87.9	78.13 (FROM DMH #206A) 78.13 (FROM AD #254)	78.03 (TO DMH #205
DMH #206A	87.2	78.52 (FROM DMH #207) 78.52 (FOR AD #254A)	78.42 (TO DMH #206
DMH # 207	86.7	81.41(FROM CB #255) 81.17 (FROM CB #256)	78.64 (TO DMH #206
DMH # 220	83.8	75.07 (FROM DMH #221) 77.62 (FROM CB #257) 77.18 (FROM CB #258)	74.97 (TO DMH #200
DMH #221	87.8	76.75 (FROM DMH #222) 82.17 (FROM CB #263)	76.08 (TO DMH #220
DMH #222	87.2	78.77 (FROM DMH #223) 81.35 (FROM CB #259) 81.30 (FROM CB #260)	77.97 (TO DMH #221
DMH #223	87.6	82.40 (FROM CB #261) 81.33 (FROM CB #262)	81.23 (TO DMH #223
CATCH BASIN		INVERT IN	INVERT OUT
CB #251	82.75		77.75 (TO DMH #202
CB #252	82.96		77.96 (TO DMH #204
AD #253	83.45		78.33 (TO DMH #205
AD #254	83.50		78.79 (TO DMH #206
AD #254A	83.60		79.15 (TO DMH #206)
CB #255	86.50		81.50 (TO DMH #207
CB #256	87.00		82.00 (TO DMH #207
CB #257	83.00	- · · · · · · · · · · · · · · · · · · ·	78.00 (TO DMH #220
CB #258	83.40		78.40 (TO DMH #220
CB #259	87.00		82.10 (TO DMH #222
CB #260	87.00		82.10 (TO DMH #222
CB #261	87.50	-	82.50 (TO DMH #223
CB #262	86.70		81.80 (TO DMH #223
CB #263	87.30		82.30 (TO DMH #221
JU #200	07.00	l	1 02.50 (10 DMH #22)

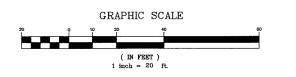

● DMH	PROPOSED DRAIN MANHOLE
■ CB	PROPOSED CATCH BASIN
SMH	PROPOSED SEWER MANHOLE
*	PROPOSED HYDRANT
∞	PROPOSED CLEANOUT
у	PROPOSED WATER LINE
D	PROPOSED DRAIN LINE
	PROPOSED ROOF DRAIN LINE
—— s ——	PROPOSED SEWER LINE
—т—	PROPOSED TELEPHONE LINE
—— <u>E</u> ——	PROPOSED: ELECTRIC LINE
—— G ——	PROPOSED GAS LINE (BY OTHERS
	LINE TO BE ABANDONED
RD	ROOF DRAIN
SS	SANITARY SEWER
QU	UNDER DRAIN

F	L	Α	N	S	В	U	R	G	Η	A	S	S	0	С	***************************************	Α	E	S

77 North Washington Street Boston, Massachusetts 02114 Telephone 617-367-3970 Furniture, Equipment and Casework Consultant Facsimile 617-720-7873 www.faiarchitects.com

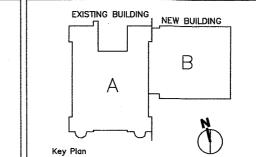

PLUG & ABANDON EXISITING DRAINLINE

D DMH 202 8 NV=75.93 cs 2024

PROPOSED

ADDITION

UNDERGROUND DETENTION SYSTEM A

R&D CB

EXISTING

WHITTEMORE

SCHOOL

INV=82.0-

SB(FD)

SPACE

SB(FD)

SPACE

SB(FD)

UP \$201/20-

GAME AREA

CONCRETE SPENNIX CO. SPENS SPENNIX CO. SPENS SPE

-4" VENT INVERT 78.50

_grease trap see detail

-4" ROOF DRAIN INVERT =82.33

4" ROOF DRAIN INVERT =83.83

-INV=81.27

8" ROOF DRAIN-INVERT =84.33

6" SAN. SEW.-

164LF-12*CPP

-RECURDIONNY 181.3

CONNECT TO EXISTING

-REPLACE EXISTING 516.06' TIE LINE DI WATERMANETE SI

1,383.42'(RECORD) 1,383.33'(SURVEY)

(78/2/1)

-STORMWATER TREATEMENT™CENTER SEE SPECIFICATIONS

--- 5 LF-18" CPF

- R&D CB

8"x6" TEE AND VALVE

R&D CB INVIT

647x12" \

INV=75.98

2)15 38EF

8'12" CPP

ows SBDH(FD)

- "4444

FOUNDATION DRAIN SEE ARCHITECTURAL PLANS

MAINTAIN EXISTING UTILITY POLES-AND WIRES AS NECESSARY. COORDINATE WITH UTILITY OWNER

70/30/3

N/F JOHN G. DEMOS &

BK. 21993 PG. 36

70/30/2

N/F A. LOMBARD, R. MACINNIS

ERT J. KELLY, FEES OF NEW TURES LAND ASPORTATION ALTY TRUST 9519 PG. 114 STER DEED

CONTRACTOR TO COORDINATE CONTRUCTION OF GASMAIN WITH GAS COMPANY

(70/30/1)

WOOD-

-12" CPP

REMOVE AND DISPOSE
COORDINATE WITH
UTILITY OWNERS

CONTRACTOR TO
COORDINATE REMOVAL
OR ABANDEMENT OFFOSSILE
TELECOMM. AND ELECTROMOR
LINES WITH UTILITY
OWNER

RAILROAD SPIKE SET 1.2' ABOVE GRADE IN THE EAST SIDE OF UTILITY POLE #3.

ELECTRICAL DUCT BANK REFER TO ELECTRICAL

REGARDING REMOVAL (TYP)

CONC.

BRICK-

70/30/6

JOHN F. LALLY

& GERTRUDE LALLY BK. 7938 PG. 212

INV=81.5

PARAMENTER_ROAD

UNDERGROUND

Checked by: Issue Date:Sept 29, 2006 WHITTEMORE ELEMENTARY SCHOOL 30 Parmenter Road

SITE UTILITY PLAN

HOVEY ROAD

36 LF-12" CPP

FLEV=86.16

△ GRASS

6' STOCKADE FENCE

-12 CPP

12" CPP

GRASS

DOWN

BK. 141

JOHN (BK. 2

(78/2/5)

N/F ROBERT K. LALLY

BONNIE A. LALL BK. 17475 PG. 4

(78/2/8)

Plot Date: Sept 29, 2006

Job Number: 2015.00

Scale:

Drawn by:

1"=20'

Waltham, Massachusetts

LEGEND & ABBREVIATIONS

•	PROPOSED DRAIN MANHULE
■ CB	PROPOSED CATCH BASIN
SMH	PROPOSED SEWER MANHOLE
*	PROPOSED HYDRANT
· 00	PROPOSED CLEANOUT
y	PROPOSED WATER LINE
D	PROPOSED DRAIN LINE
	PROPOSED ROOF DRAIN LINE
s	PROPOSED SEWER LINE
	PROPOSED TELEPHONE LINE
 Е	PROPOSED ELECTRIC LINE
G	PROPOSED GAS LINE (BY OTHERS
	LINE TO BE ABANDONED
	DOGE DRAW

Description of Revision

GELLER DEVELLIS, INC. Landscape Architect

Structural Engineer

JUDITH NITSCH ENGINEERING, INC. Civil Engineer

WELCH ASSOCIATES LAND SURVEYORS, INC. EDVANCE TECHNOLOGY DESIGN, INC.

Land Surveyor

Computer/Technology Consultant ENGINEERS DESIGN GROUP, INC.


TMP CONSULTING ENGINEERS, INC.


TAVARES DESIGN ASSOCIATES, INC.

Mechanical, Electrical, Plumbing, and Fire Protection Engineer

for any angle of the transfer of the first o

Architecture Master Planning Space Planning Interior Design

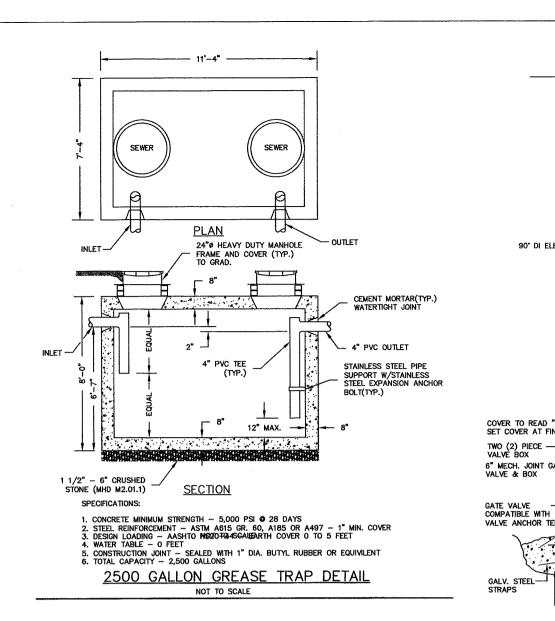

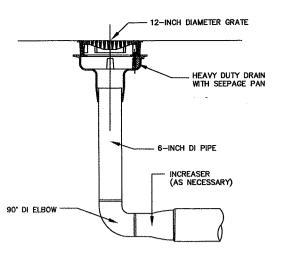



D.I. WATER MAIN WITH VALVE ANCHOR TEE

NOTE: ALL JOINTS ON HYDRANT BRANCH TO BE RESTRAINED JOINTS

FIRE HYDRANT DETAIL

NOT TO SCALE

6" MIN.

TYPICAL CATCH BASIN DETAIL

- PLACE CONCRETE AGAINST UNDISTURBED EARTH OR SHEETING IF SHEETING IS TO REMAIN IN PLACE. (SEE ANCHORAGE DETAIL)

rFIN. GRADE

3/4"CRUSHED STONE TO AT LEAST 6"ABOVE

-PLACE HYD. ON

FINISH GRADE

BIT. CONC. 12" GRAVEL BORROW (MHD M1.03.0 TYPE "B")

PROVIDE "V"
OPENING
MORTAR (TYP.)

OUTLET

OUTSIDE DIA OF PIPE +2* CLEARANCE

--- Unsuitable
MATERIAL TO BE
REMOVED AND
REPLACED W/
GRAVEL BORROW
(MHD M1.03.0 TYPE "B")
COMPACTED IN 6" LAYERS

712" MIN. COMPACTED GRAVEL BORROW (MHD M1.03.0 TYPE "B") /---- UNSUITABLE

HYD.DRAIN CONC.THRUST

COVER TO READ "WATER" -SET COVER AT FIN. GRADE

TWO (2) PIECE -VALVE BOX

VALVE ANCHOR TEE

GALV. STEEL--STRAPS

CAST IRON FRAME AND GRATE-

PRECAST CONCRETE FLAT SLAB OR DOME SECTION—

PRECAST CONCRETE RISER SECTION (TYP.)


SECTIONS VARY FROM 1' TO 4'

PRECAST CONCRETE


BASE SECTION


REMOVABLE CATCH BASIN HOODS REQUIRED ON ALL CATCH BASINS


MORTAR (TYP.)-

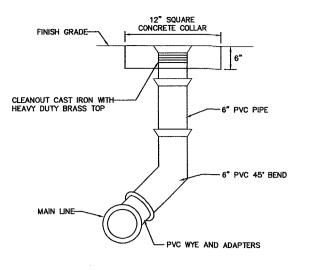


TYPICAL CLEANOUT DETAIL

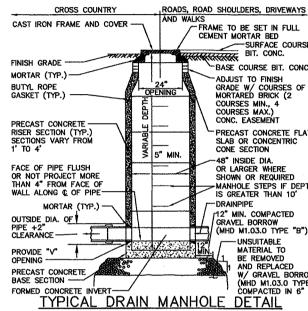

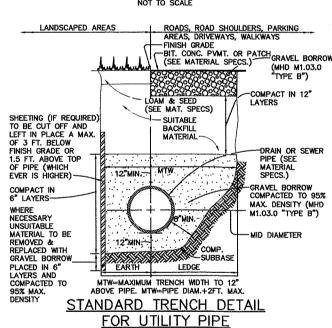

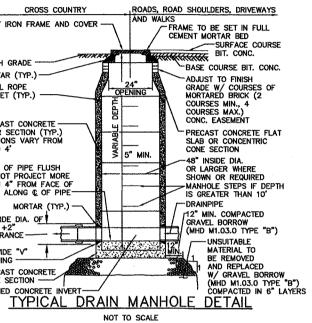

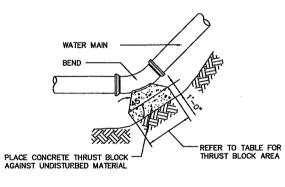

WATER TRENCH DETAIL

NOT TO SCALE

TABLE OF BEARING AREAS IN SQUARE FEET

AGAINS	I UNDISTURBED	MATERIAL FOR	riting.
SIZE OF MAIN (INCHES)	90° BEND (S.F.)	45° BEND (S.F.)	DEAD END (S.F.)
4	2.3	1.3	1.6
6	4.7	2.5	3.3
8	8.0	4.5	6.0
12	17.0	9.5	12.0

NOTES:

CROSS COUNTRY

24" SEWER MANHOLE COVER-

FINISH GRADE

ADJUST TO FINISH GRADE WITH COURSES OF MORTARED BRICK 2-COURSES MIN., 4-COURSES MAX.

STEEL REINFORCED COPOLYMER POLYPROPYLENE

PLASTIC STEPS 12" O.C.(TYP.) TO BOTTOM

MORTAR JOINTS INSIDE & OUT AFTER PRECAST

SECTIONS ARE IN PLACE

INVERTS TO BE INVERTED ARCH W/RED SEWER BRICK LAID AS STRETCHERS & ON EDGE

CROSS COUNTRY

4'-6" MIN.

6'-0" MAX.

ROADS, ROAD SHOULDERS, DRIVEWAYS, WALKWAYS

4'-0" DIA.

12" MIN. COMPACTED GRAVEL BORROW (MHD M1.03.0 "TYPE B") COMPACTED SUBBASE

-- STREET

TYPICAL SEWER MANHOLE DETAIL

6" LOAM AND SEED

-BIT. CONC.

CEMENT CONCRETE COLLAR PRECAST CONCRETE
MH ECCENTRIC CONE
SECTION OR FLAT SLAB
SECTION © SHALLOW MH

-BUTYL ROPE GASKET (TYP.)

PRECAST CONCRETE MH RISER SECTION

BRICK SHELF SHALL BE
SLOPED TOWARD
CHANNEL LOWEST SHELF
ELEVATION TO BE AT
LEAST AS HIGH AS
CROWN OF HIGHEST PIPE.

-UNSUITABLE MATERIAL TO BE REMOVED AND REPLACED

BORROW (MHD M1.03.0 "TYPE B") COMPACTED IN 6" LAYERS

SEE PAVEMENT SECTION DETAIL

-BANK RUN GRAVEL AND/OR SUITABLE MATERIAL FROM THE EXCAVATION COMPACTED IN 12" LIFTS

SAND AROUND PIPE COMPACTED IN 6" LIFTS


DUCTILE IRON CLASS 52 WATER PIPE

W/GRAVEL

RUBBER BOOT

- 1. FOR FITTINGS WITH LESS THAN 45° DEFLECTION USE BEARING AREAS FOR 45° BEND.
- 2. BEARING AREAS BASED ON HORIZONTAL PASSIVE SOIL PRESSURE OF 2000 PSF AND A MINIMUM INTERNAL WATER PRESSURE OF 175 PSIG. JOINTS SHALL NOT BE ENCASED IN CONCRETE, BEARING AREAS MAY BE DISREGARDED FOR TRENCHES IN ROCK WHERE THE TOP OF THE ROCK FACE IS AT OR ABOVE THE CROWN OF THE PIPE. HOWEVER, CONCRETE BACKING SHALL BE PLACED BETWEEN THE PIPE AND ROCK FACE.
- 3. RESTRAINED JOINTS SHALL BE FURNISHED ON ALL HYDRANT BRANCHES AND VERTICAL BENDS

THRUST BLOCK DETAIL NOT TO SCALE

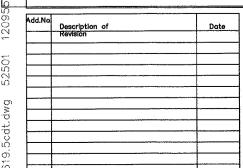

GELLER DEVELLIS, INC. Landscape Architect

Civil Engineer

Structural Engineer

JUDITH NITSCH ENGINEERING, INC.

ENGINEERS DESIGN GROUP, INC.

TMP CONSULTING ENGINEERS, INC. Mechanical, Electrical, Plumbing, and Fire Protection Engineer

TAVARES DESIGN ASSOCIATES, INC. Furniture, Equipment and Casework Consultant


WELCH ASSOCIATES LAND SURVEYORS, INC. EDVANCE TECHNOLOGY DESIGN, INC. Land Surveyor

Computer/Technology Consultant

FLANSBURGHASSOCIATES

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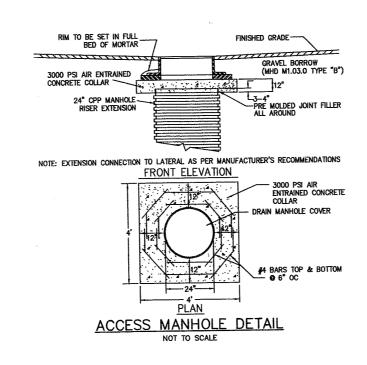



SITE UTILITY DETAILS

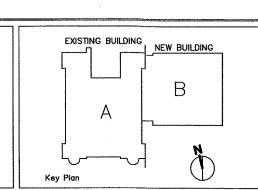Plot Date: Sept 29, 2006 Job Number: 2015.00 Scale: Drawn by: Checked by: Issue Date:Sept 29, 2006


WHITTEMORE ELEMENTARY SCHOOL 30 Parmenter Road Waltham, Massachusetts

C-2




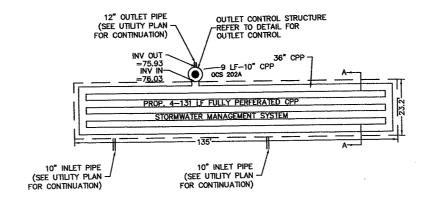




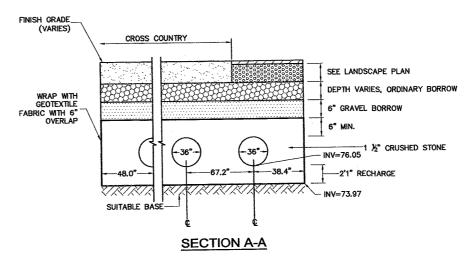


UNDERGROUND DETENTION STRUCTURE A

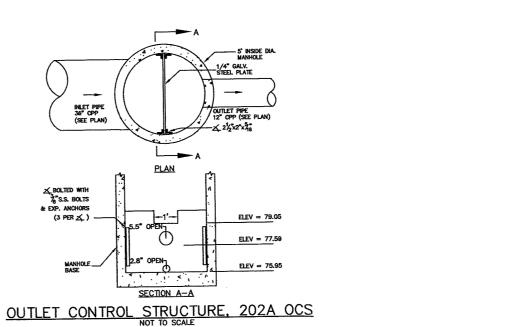


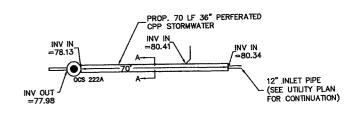


<u>PLAN</u>

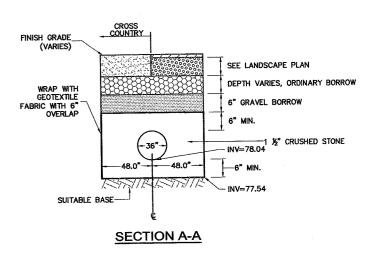

UNDERGROUND DETENTION STRUCTURE B
NOT TO SCALE

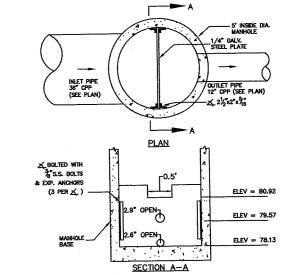

OUTLET CONTROL STRUCTURE, 222A OCS
NOT TO SCALE

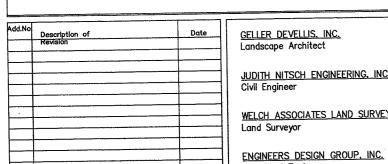

GELLER DEVELLIS, INC. Landscape Architect

Structural Engineer

JUDITH NITSCH ENGINEERING, INC. Civil Engineer

Land Surveyor

WELCH ASSOCIATES LAND SURVEYORS, INC. EDVANCE TECHNOLOGY DESIGN, INC.


TMP CONSULTING ENGINEERS, INC. Mechanical, Electrical, Plumbing, and Fire Protection Engineer

TAVARES DESIGN ASSOCIATES, INC. Furniture, Equipment and Casework Consultant

Computer/Technology Consultant

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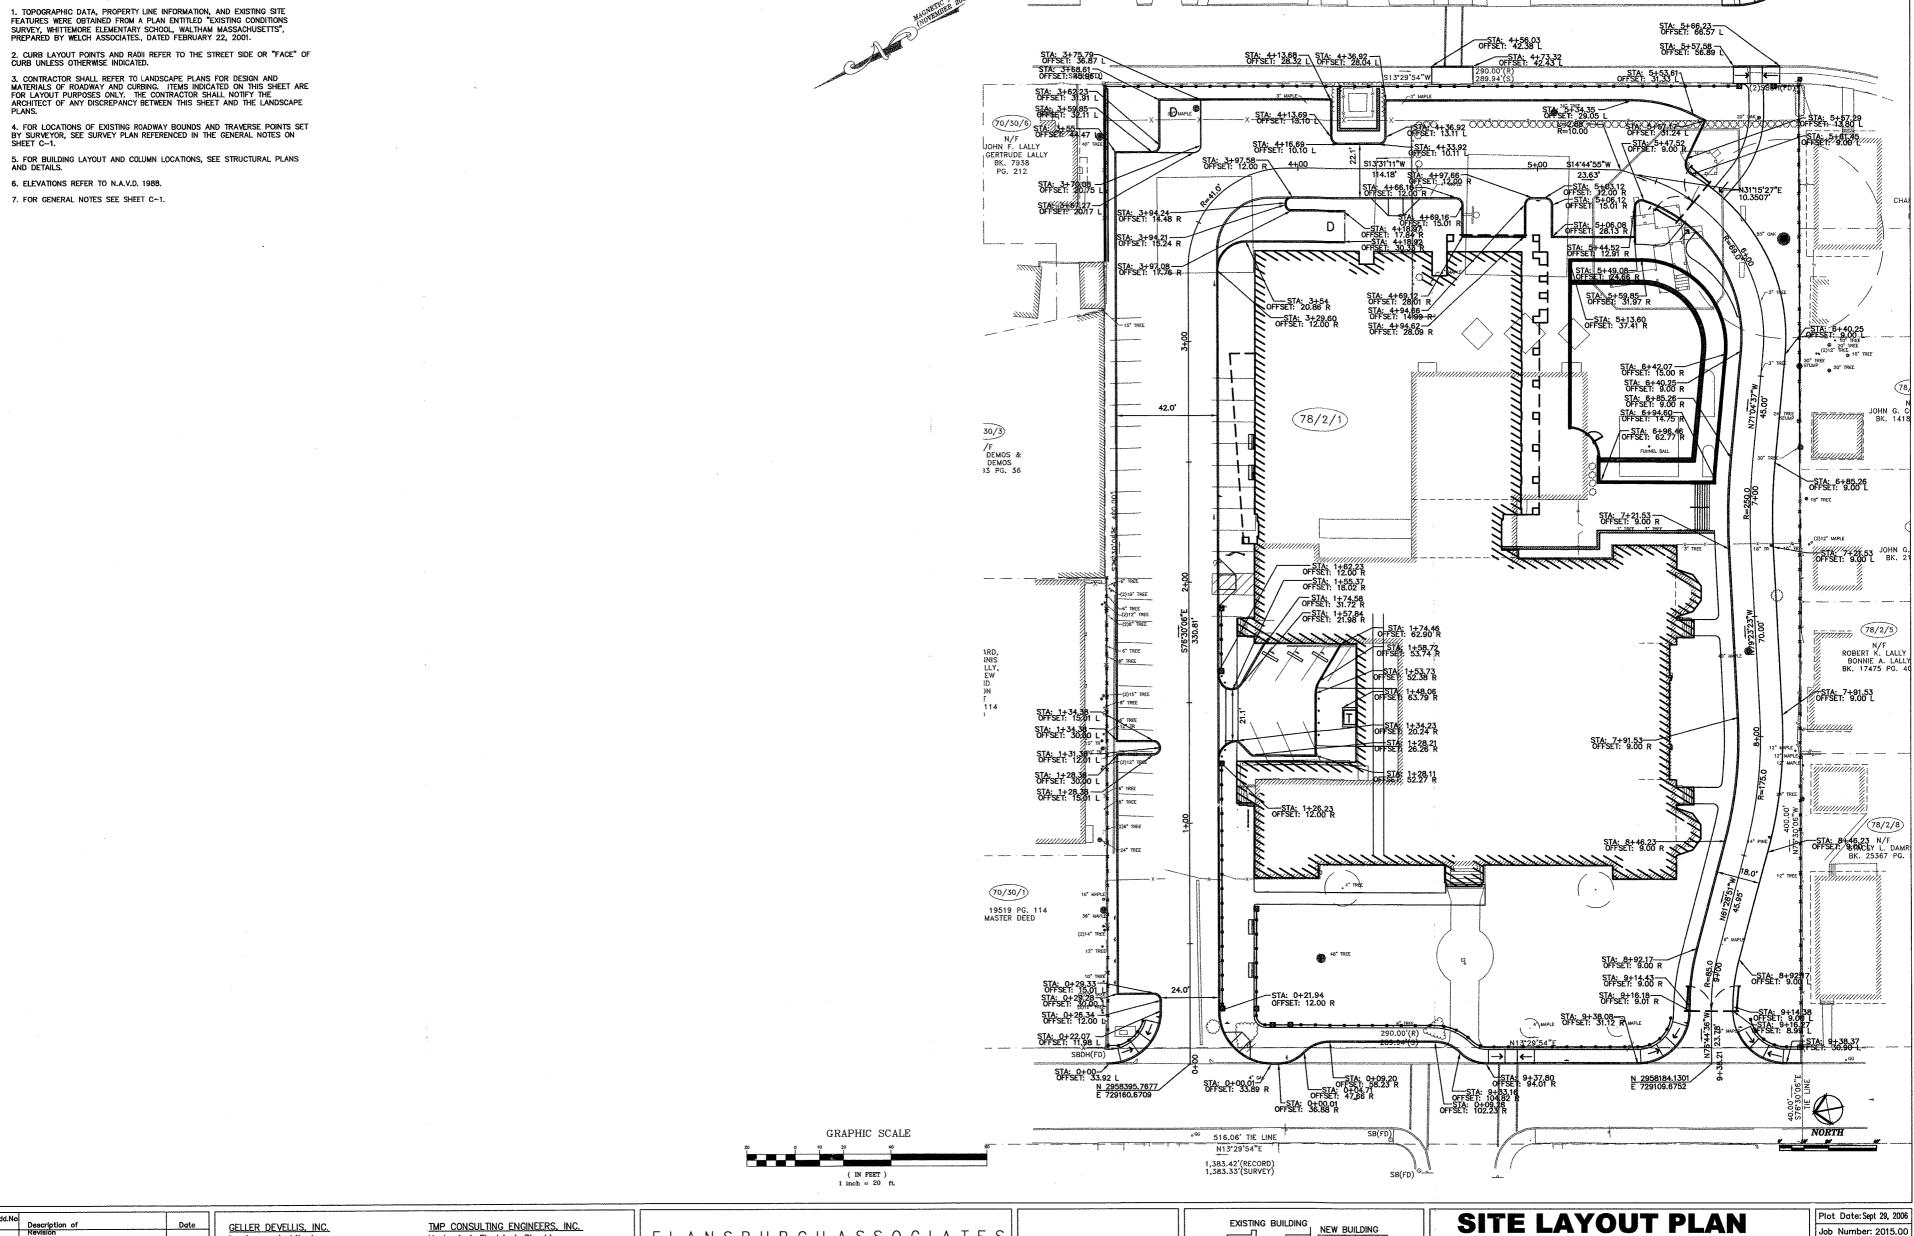


SITE UTILITY DETAILS

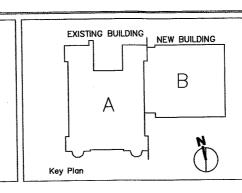Plot Date: Sept 29, 2006 Job Number: 2015.00 Drawn by: Checked by: Issue Date:Sept 29, 2006

WHITTEMORE ELEMENTARY SCHOOL 30 Parmenter Road Waltham, Massachusetts

LAYOUT NOTES



Add.No	Description of	Date
	Description of Revision	
-		
		·
-+	<u> </u>	
-+		

Landscape Architect

JUDITH NITSCH ENGINEERING, INC.

WELCH ASSOCIATES LAND SURVEYORS, INC. EDVANCE TECHNOLOGY DESIGN, INC. Land Surveyor

ENGINEERS DESIGN GROUP, INC. Structural Engineer

Mechanical, Electrical, Plumbing, and Fire Protection Engineer


TAVARES DESIGN ASSOCIATES, INC. Furniture, Equipment and Casework Consultant

Computer/Technology Consultant

FLANSBURGHASSOCIATES

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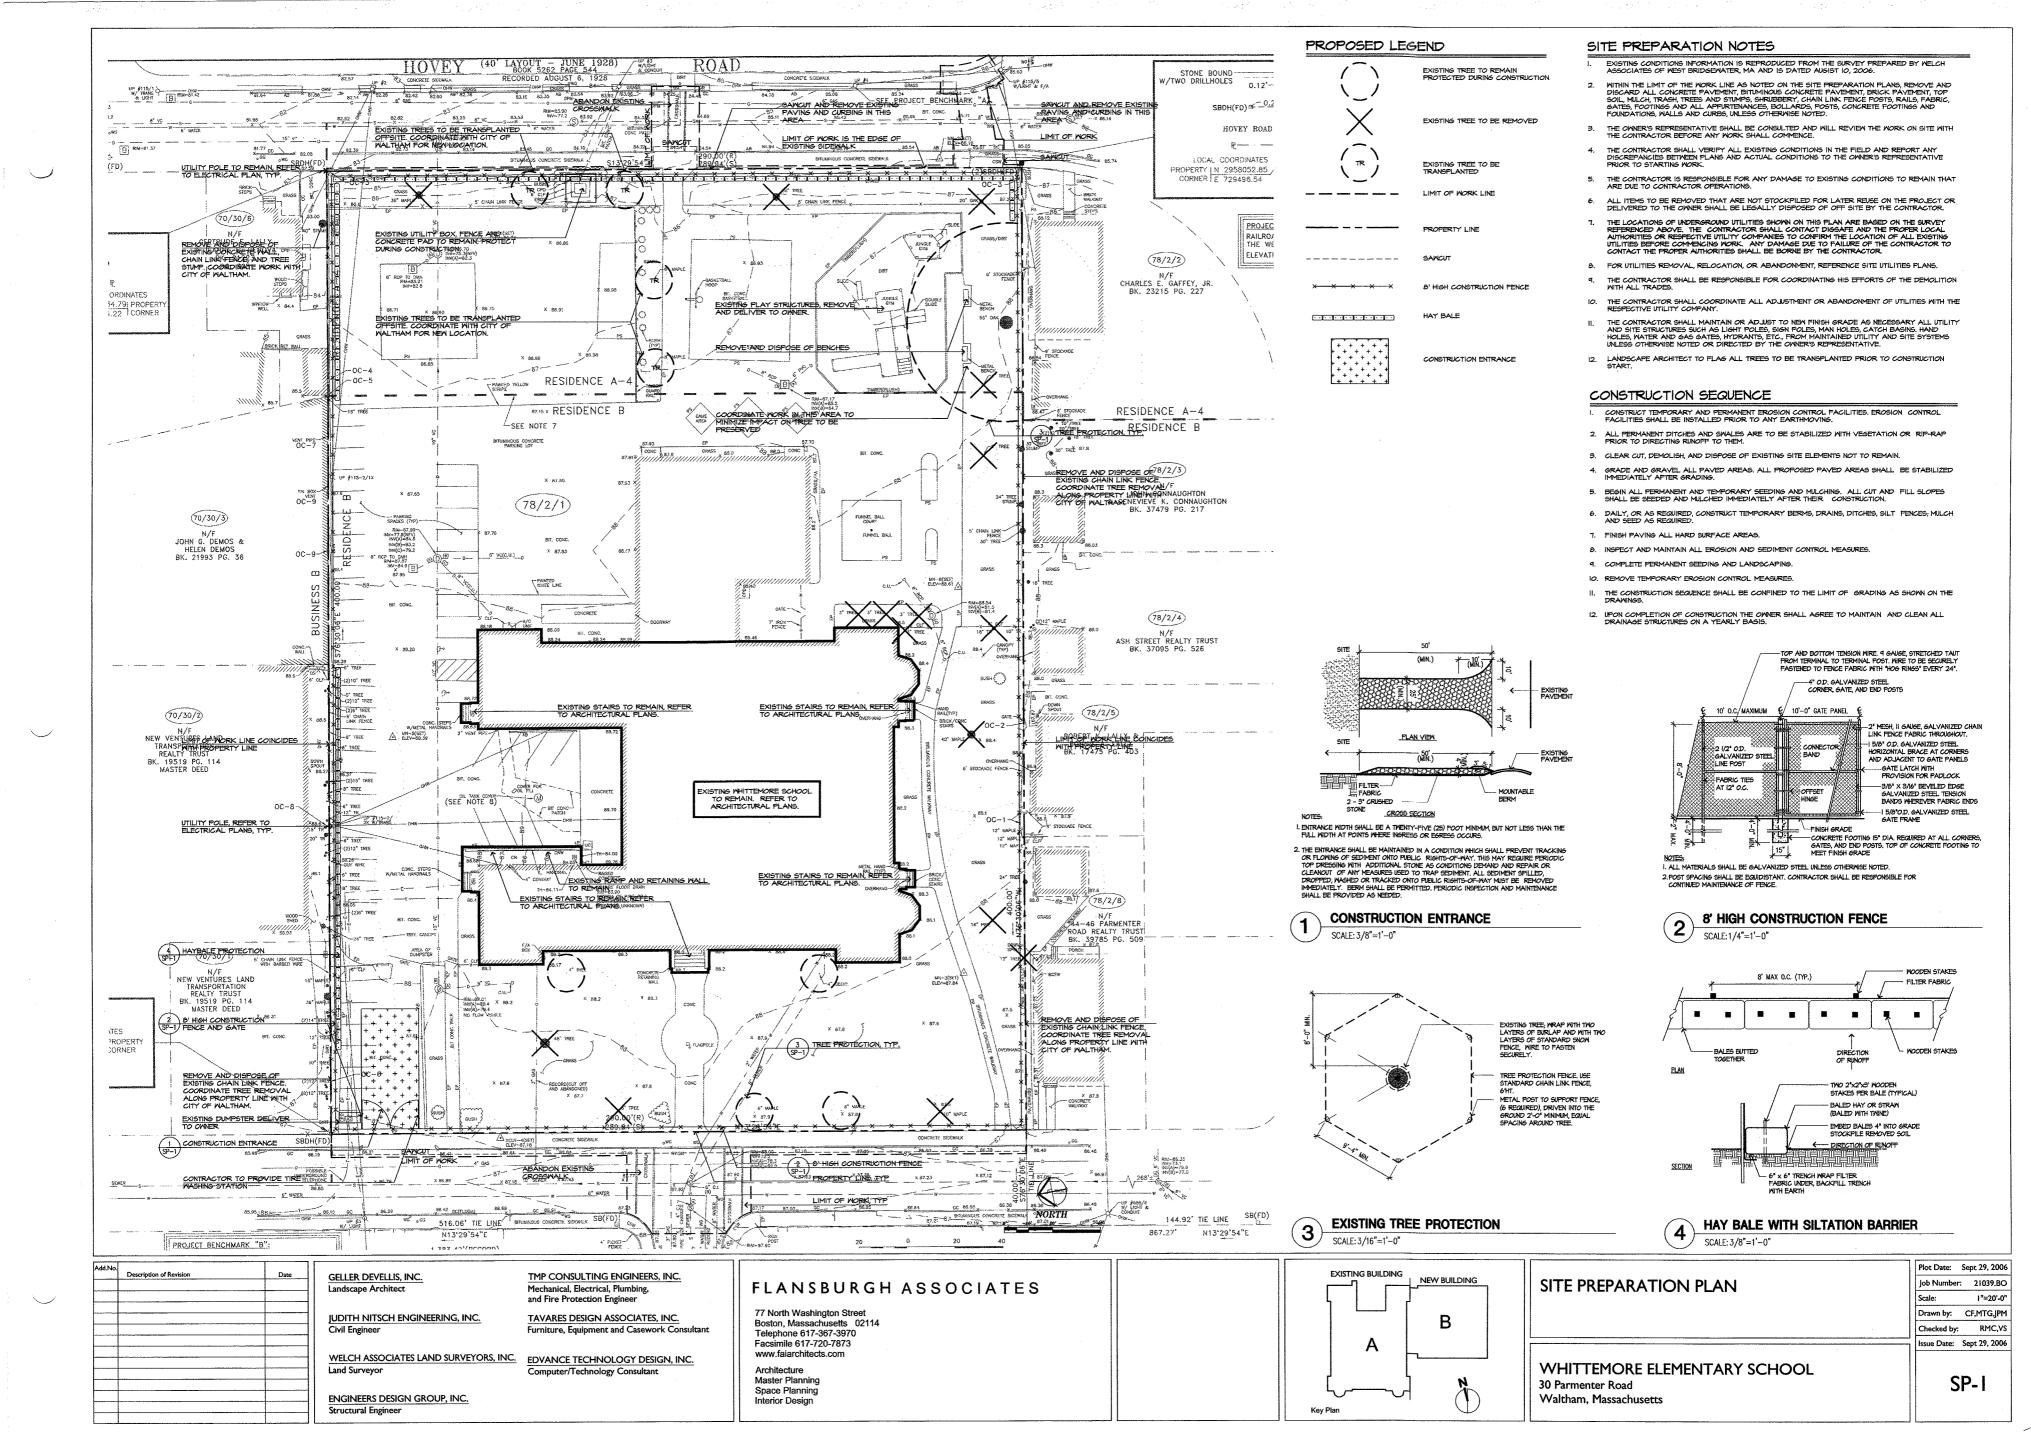
Master Planning Space Planning Interior Design

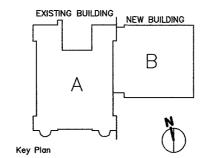


WHITTEMORE ELEMENTARY SCHOOL 30 Parmenter Road Waltham, Massachusetts

Job Number: 2015.00 Scale: 1"=20" Drawn by: Checked by: Issue Date:Sept 29, 2006

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LAYOUT AND MATERIAL NOTES

- EXISTING CONDITIONS INFORMATION IS REPRODUCED FROM THE SURVEY PREPARED BY WELCH ASSOCIATES OF WEST BRIDGEWATER, MASSACHUSETTS AND IS DATED AUGUST 10, 2006.
- THE LOCATIONS OF UNDERGROUND UTILITIES SHOWN ARE BASED ON THE SURVEY REFERENCED ABOVE. THE CONTRACTOR SHALL NOTIFY DISSAFE AND THE PROPER LOCAL AUTHORITIES OR RESPECTIVE UTILITY COMPANIES TO CONFIRM THE LOCATION OF ALL EXISTING UTILITIES BEFORE COMMENCING WORK. ANY DAMAGE DUE TO FAILURE OF THE CONTRACTOR TO CONTACT THE PROPER AUTHORITIES SHALL BE BORNE BY THE CONTRACTOR.
- CONTRACTOR(s) SHALL THOROUGHLY FAMILIARIZE THEMSELVES WITH ALL CONSTRUCTION DOCUMENT SPECIFICATIONS, AND SITE CONDITIONS PRIOR TO BIDDING AND PRIOR TO CONSTRUCTION.
- ANY DISCREPANCIES BETWEEN DRAWINGS, SPECIFICATIONS, AND SITE CONDITIONS SHALL BE REPORTED IMMEDIATELY TO THE OWNER'S REPRESENTATIVE FOR CLARIFICATION AND RESOLUTION PRIOR TO BIDDING OR CONSTRUCTION.
- ALL WORK CONDUCTED WITHIN PUBLIC RIGHT-OF-WAYS SHALL CONFORM TO THE REQUIREMENTS AND SPECIFICATIONS OF THE CITY OF WALTHAM AND THE MASSACHUSETTS HIGHWAY DEPARTMENT.
- SEE ARCHITECTURAL DRAWINGS FOR EXACT BUILDING DIMENSIONS AND ALL DETAILS CONTIGUOUS TO THE BUILDING, INCLUDING SIDEMALKS, RAMPS, UTILITY ENTRANCE LOCATIONS, WALL PACKS, CONCRETE DOOR PADS, ROOF DRAINS, ETC.
- ACCESSIBLE CURB RAMPS SHALL BE PER THE MASSACHUSETTS ARCHITECTURAL ACCESS BOARD (MAAS) AND THE AMERICANS WITH DISABILITIES ACT (ADA) ACCESSIBILITY SUIDELINES, WHICHEVER IS MORE STRINGENT.
- THE FOLLOWING LAYOUT CRITERIA SHALL CONTROL UNLESS OTHERWISE NOTED ON THE PLAN: ALL DIMENSIONS ARE TO FACE OF LORD AT GUTTER LINE: ALL DIMENSIONS ARE TO FACE OF LORD AT GUTTER LINE: ALL DIMENSIONS ARE TO CENTER OF PAYEMENT MARKINGS. ALL TIES ARE TO PROPERTY LINES ARE PERPENDICULAR TO THE PROPERTY LINE UNLESS OTHERWISE NOTED.
- 9. FOR LAYOUT AND DIMENSIONING OF BUILDINGS, SEE ARCHITECTURAL DRAWINGS
- SCREENED IMAGES SHOW EXISTING CONDITIONS. WHERE EXISTING CONDITIONS LIE UNDER OR ARE IMPINED UPON BY PROPOSED BUILDINGS AND/OR SITE ELEMENTS, THE EXISTING CONDITION WILL BE REMOVED, ABANDONED AND/OR CAPPED OR DEMOLISHED AS REGUIRED.

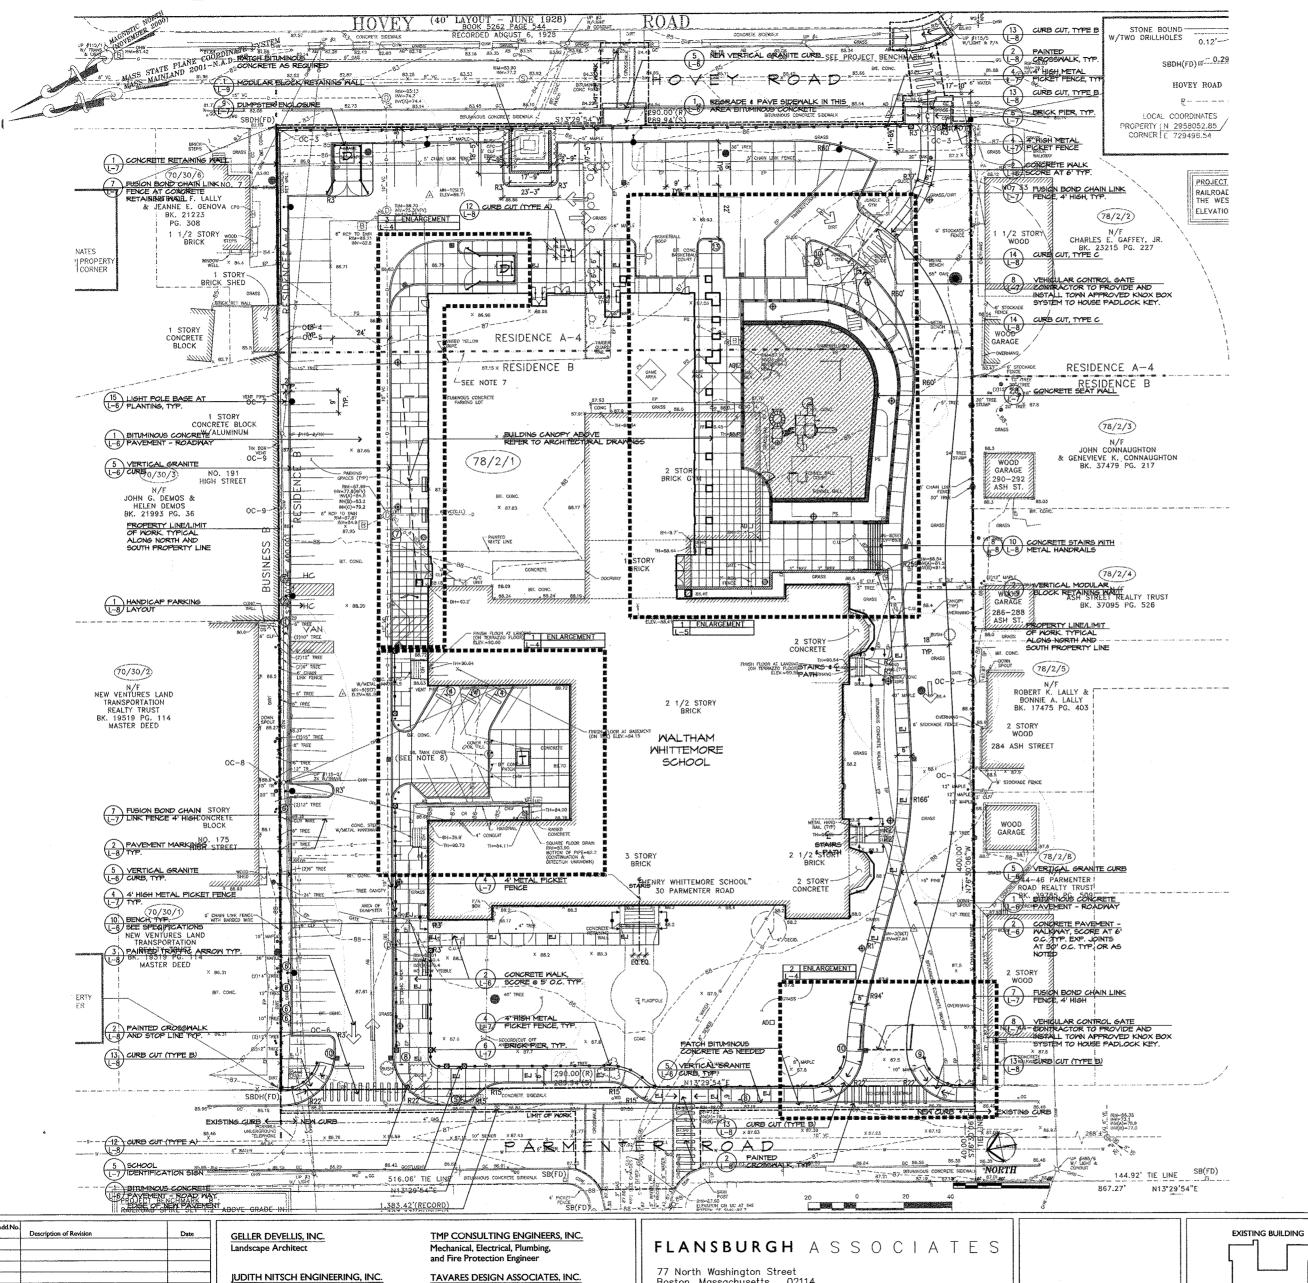PROPOSED LEGEND

PEDESTRIAN LIGHTING SITE LIGHTING STEEL PIPE BOLLARD RESILIENT SURFACING VERTICAL GRANITE CURE FLAGPOLE, WITH UPLIGHTS 4' CHAIN LINK FENCE 4' METAL PICKET FENCE BIKE RACK

MODULAR BLOCK RETAINING WALL

CONCRETE SEAT WALL

SIGN SCHEDULE

SIGN#	COPY	# REQ'D.	DETAIL
1	HANDICAP PARKING-VAN	1	5,7/L-8
2	HANDICAP PARKING	2	5,7/L~8
3	BUSES AND EMERGENCY VEHICLES ONLY	1	4,6/L-8
4	RESERVED PARKING	2	5,7/L-8
5	PARENT DROP-OFF / PICK-UP ONLY	. 1	5,7/L~8
6	VISITOR PARKING	4	5,7/L-8
7	BUS DROP OFF ONLY	1	5,7/L-8
8	NO PARKING/ STOPPING ANYTIME	2	5,7/L-8
9	DO NOT ENTER	1	4,6/L~8
10	STOP SIGN	3	4,6/L-8
11	NO VISITOR PARKING BEYOND THIS POINT	1	4,6/L-8
12	DO NOT DUMP (MOUNT ON FENCE ENCLOSURE)	2	5,7/L-8 AL
13	COMPACT VEHICLE PARKING	1	5,7/L-8

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Furniture, Equipment and Casework Consultan

Computer/Technology Consultant

WELCH ASSOCIATES LAND SURVEYORS, INC. EDVANCE TECHNOLOGY DESIGN, INC.

Land Surveyor

Structural Engineer

ENGINEERS DESIGN GROUP, INC.

NEW BUILDING В

Key Pian


LAYOUT AND MATERIALS PLAN

Job Number: 21039.BO 1"=20'-0" Drawn by: CF,MTG,JPM Checked by: RMC,VS Issue Date: Sept 29, 2006

Plot Date: Sept 29, 2006

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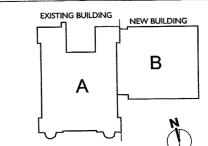
GRADING NOTES

- EXISTING CONDITIONS INFORMATION IS REPRODUCED FROM THE SURVEY PREPARED BY WELC ASSOCIATES OF WEST BRIDGEWATER, MA AND IS DATED AUGUST 10, 2006.
- PRIOR TO THE START OF ANY EXCAVATION FOR THE PROJECT, BOTH ON AND OFF THE SITE, THE CONTRACTOR SHALL NOTIFY DIGSAFE AND BE PROVIDED MITH A DIGSAFE NUMBER INDICATING THAT ALL EXISTING UTILITIES HAVE BEEN LOCATED AND MARKED.
- CONTRACTOR SHALL MAINTAIN POSITIVE DRAINAGE AWAY FROM ALL BUILD STRUCTURES AND PLANTING BEDS.
- MAXIMUM SLOPE IN DISTURBED AREAS SHALL NOT EXCEED 5.1, UNLESS OTHERWISE NOTED.
- ENSURE ALL EXISTING (TO REMAIN), AND PROPOSED MANHOLE COVERS PROPERLY IDENTIFUTILITY SERVICED.

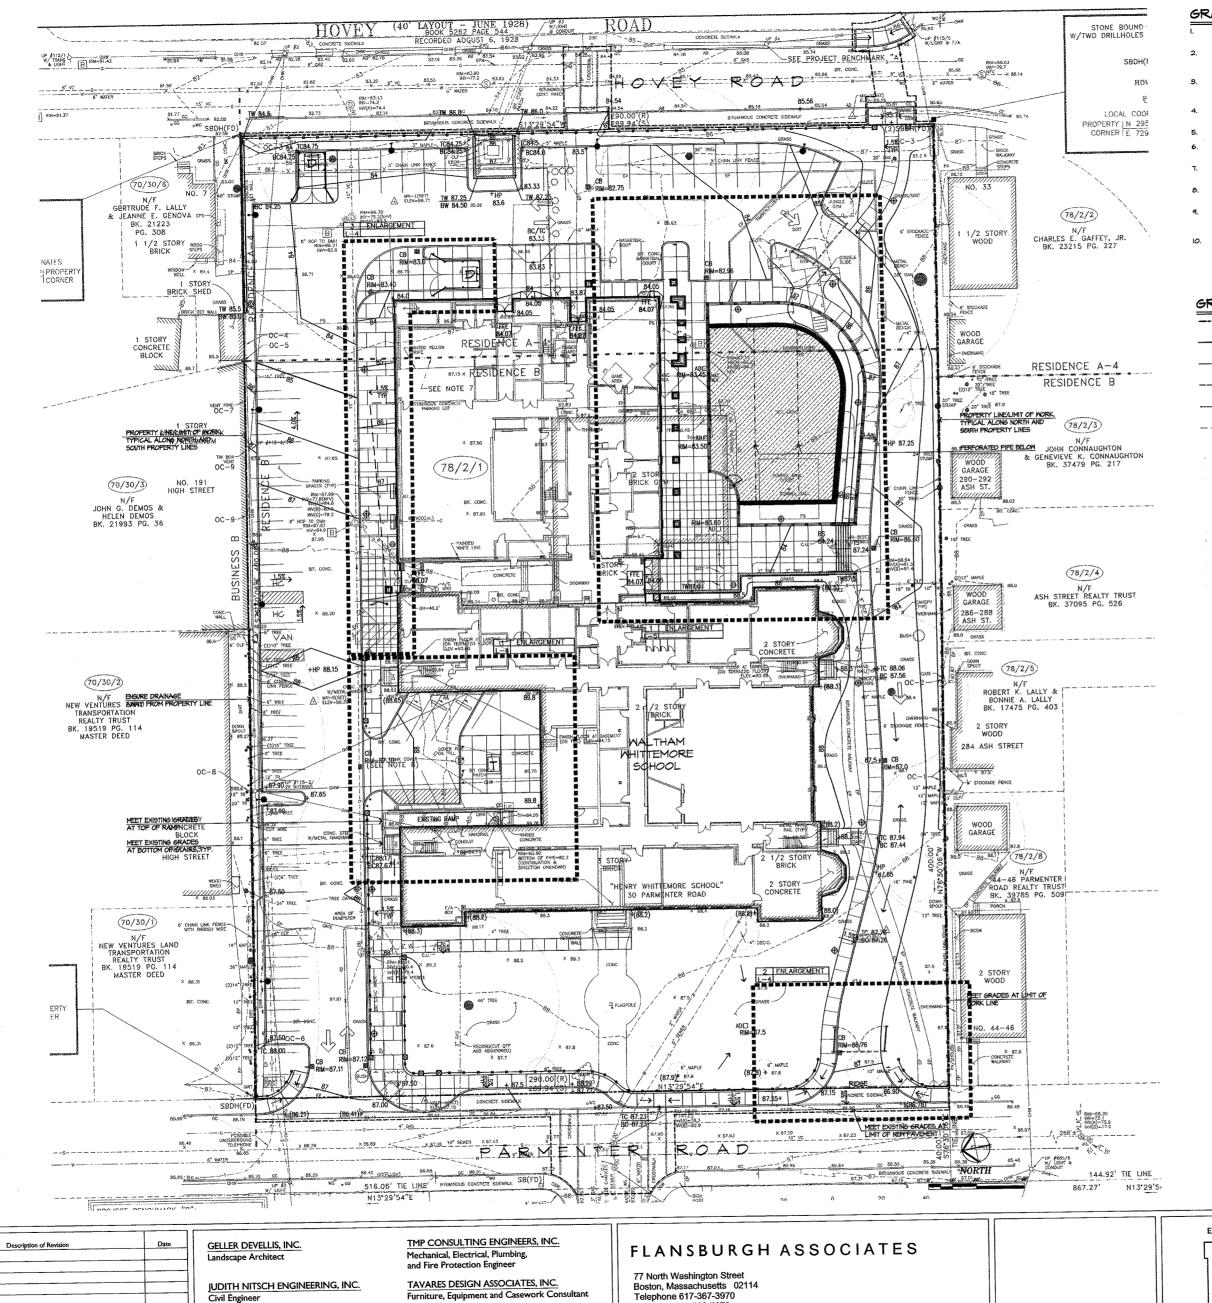- CONTRACTOR TO ADJUST UTILITY ELEMENT MEANT TO BE FLUSH WITH GRADE (CLEAN-OUTS, UTILITY MANHOLES, CATCH BASINS, INLETS, ETC) THAT IS AFFECTED BY SITE WORK OR GRAIC CHANGES, WHETHER SPECITICALLY NOTED ON PLANS OR NOT.
- SCREENED IMAGES SHOW EXISTING CONDITIONS. WHERE EXISTING CONDITIONS LIE UNDER OR ARE IMPINGED UPON BY PROPOSED BUILDINGS AND/OR SITE ELEMENTS, THE EXISTING CONDITION WILL BE REMOVED, ABANDONED AND/OR CAPPED OR DEMOLISHED AS REQUIRED

GRADING LEGEND

	PROPERTY LINE
110	PROPOSED CONTOUR MAJOR LINE
112	PROPOSED CONTOUR MINOR LINE
	LIMIT OF WORK LINE
April 100 and 100 and 100 fine for the last time control to the last time for the control to the control to the	LIMIT OF NEW PAVEMENT
	PERFORATED PIPE
+100.50	SPOT GRADE PROPOSED
+(100.50)	SPOT GRADE EXISTING
C8□	CATCH BASIN - REFER TO CIVIL PLANS
CJOA	AREA DRAIN - REFER TO CIVIL PLANS
T	TRANSFORMER



GRADING PLAN

l"=20'-0" Drawn by: CF,MTG,JPM Checked by: RMC,VS Issue Date: Sept 29, 2006

Plot Date: Sept 29, 2006

Job Number: 21039.BO

WHITTEMORE ELEMENTARY SCHOOL 30 Parmenter Road Waltham, Massachusetts

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Computer/Technology Consultant ENGINEERS DESIGN GROUP, INC. Structural Engineer

WELCH ASSOCIATES LAND SURVEYORS, INC. EDVANCE TECHNOLOGY DESIGN, INC.

Telephone 617-367-3970 Facsimile 617-720-7873

Architecture Master Planning Space Planning Interior Design Key Plan

